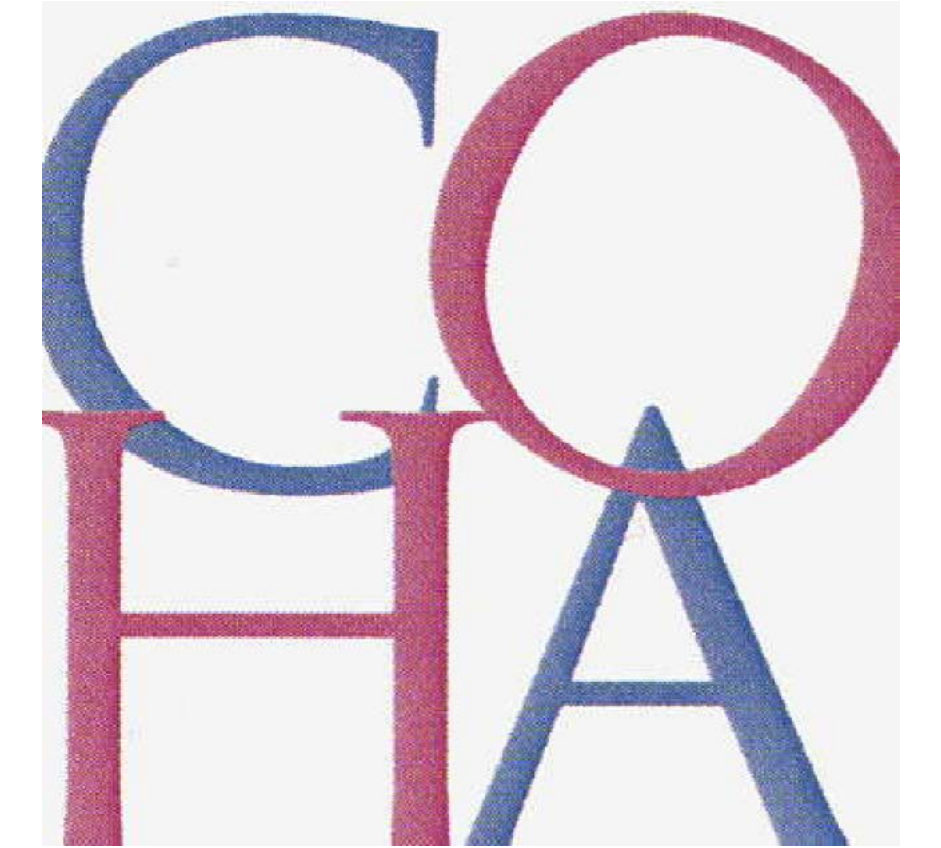


# COLUMBUS ONCOLOGY ASSOCIATES



JASONWAY PROFESSIONAL BUILDING  
810 JASONWAY AVENUE, SUITE A  
COLUMBUS, OHIO 43214-2329

DATE: OCTOBER 23, 2007  
PROJECT NO: 11406



3660 embassy parkway  
akron, ohio 44333  
tel. 330 . 666 . 5770  
fax. 330 . 666 . 8812  
www . mann-architects . com

## STRUCTURAL CONSULTANT

City View Engineers  
445 West Liberty Street, Suite 220  
Medina, Ohio 44256  
Attn: John Kabak  
P: (440) 229-1383

## MECHANICAL CONSULTANT

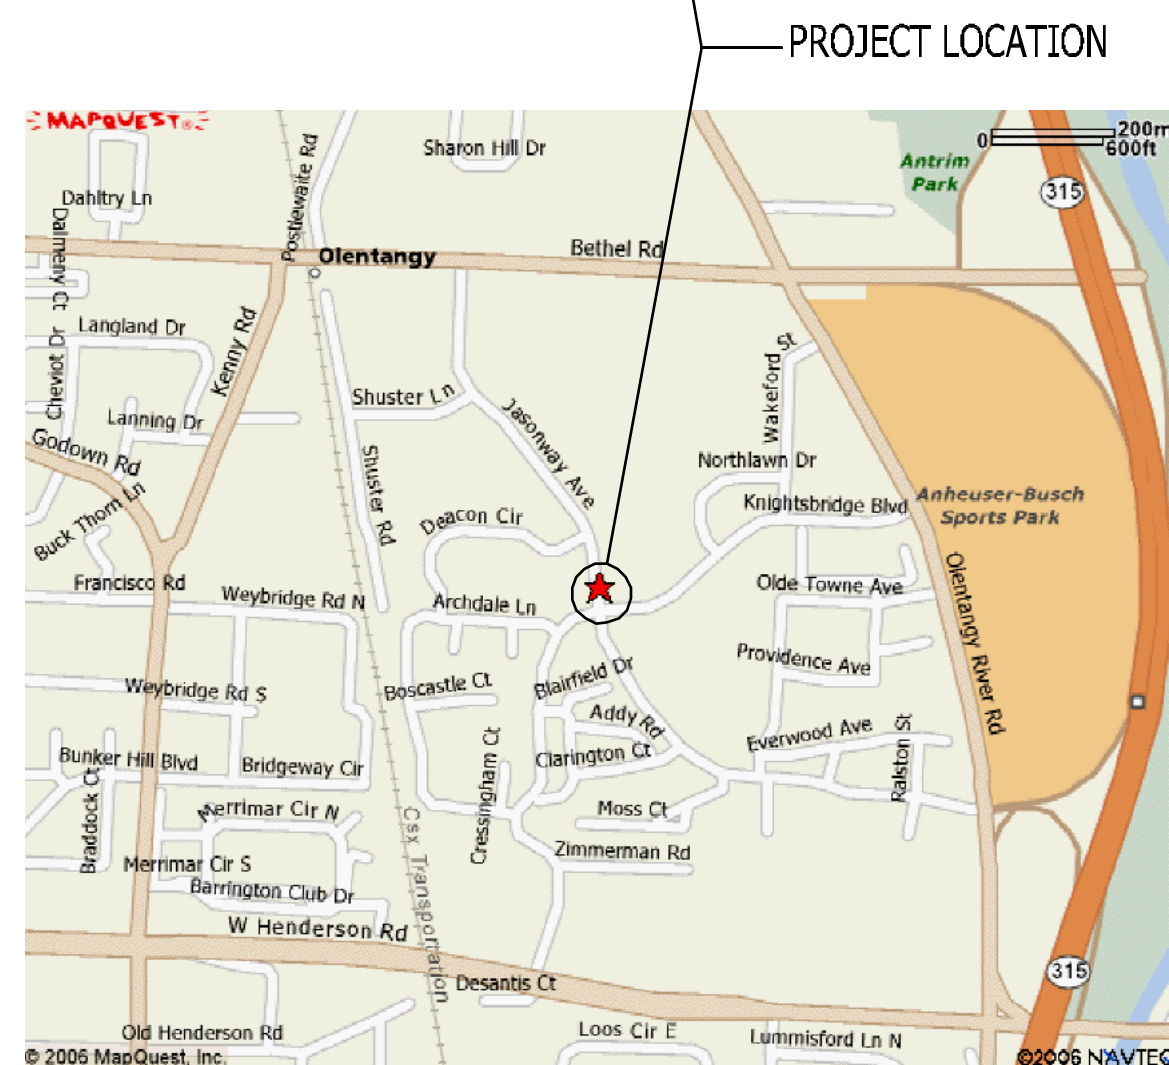
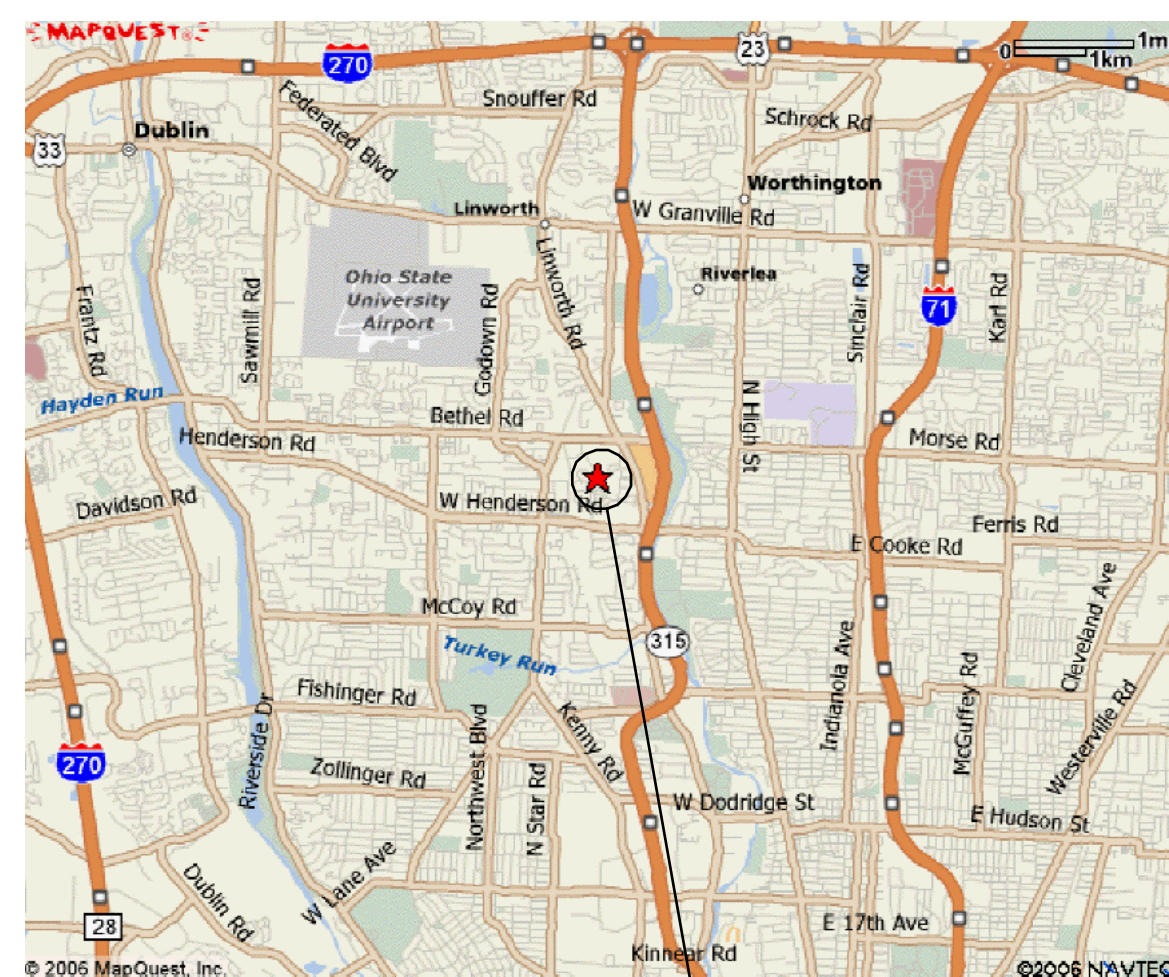
Staley Mechanical Consulting, Inc.  
302 South Chapel Street  
PO Box 191  
Louisville, Ohio 44641  
Attn: Josh Staley  
P: (330) 875-7344

## ELECTRICAL CONSULTANT

Balach Associates  
10834 Gate Post Dr.  
Strongsville, Ohio 44149  
Attn: Larry Balach  
P: (440) 572-2941

## INTERIOR CONSULTANT

Martha Allison, Consultant  
2734 E Main St., Box 210  
Columbus, Ohio 43209  
P: 614-437-7417



VICINITY MAP  
SCALE: N.T.S.

### PLANS EXAMINER NOTE!!

THIS PROJECT ENTAILS TENANT IMPROVEMENTS TO THE INTERIOR OF AN EXISTING BUILDING AND THE ADDITION OF A DRIVE UP CANOPY.

### 2007 OHIO BUILDING CODE (OBC) INFO.

PROPOSED CIRCULATION ADDITION + TENANT BUILD-OUT WITHIN EXISTING BUILDING

CHAPTER 3 - USE GROUP(S)  
EXISTING NON-SEPARATED USE  
EXISTING OCCUPANCY: B - BUSINESS (304)  
PROPOSED OCCUPANCY: B - BUSINESS (304)

CHAPTER 3 - GENERAL BUILDING HEIGHTS AND AREAS  
ALLOWABLE HEIGHT AND BUILDING AREAS - TABLE 303

ALLOWABLE AREAS:  
BUILDING HEIGHT: 4 STORY  
BUILDING AREA: 19,000 SF/FLOOR  
EXISTING AREAS:  
BUILDING HEIGHT: 2 STORY ABOVE GRADE  
FIRST FLOOR AREA: 21,565 SF  
SECOND FLOOR AREA: 8,912 SF  
TOTAL BUILDING AREA: 30,477 SF  
PROPOSED AREAS:  
FIRST FLOOR AREA: 21,565 SF  
SECOND FLOOR AREA: 8,912 SF  
TOTAL BUILDING AREA: 30,477 SF

CHAPTER 6 - TYPES OF CONSTRUCTION  
TYPE OF CONSTRUCTION - 3B  
FIRE RESISTANCE RATING REQUIREMENTS - TABLE 601, 602  
STRUCTURAL FRAME 0HR  
BEARING WALLS  
EXTERIOR WALLS 0HR  
INTERIOR WALLS 0HR  
NONBEARING WALLS AND PARTITIONS  
EXTERIOR 0HR  
INTERIOR 0HR  
CORRIDOR WALLS 0HR - TABLE 1016.1  
FLOOR CONSTRUCTION 0HR  
ROOF CONSTRUCTION 0HR

CHAPTER 9 - FIRE PROTECTION SYSTEMS  
AUTOMATIC SPRINKLER SYSTEMS (903)  
BUILDING IS CURRENTLY FULLY SUPPRESSED  
BUILDING WILL REMAIN FULLY SUPPRESSED IN ACCORDANCE WITH THIS SECTION AND THE NFPA - CHAPTER 13

CHAPTER 10 - MEANS OF EGRESS  
MAX. FLOOR AREA ALLOWANCES/OCCUPANT - TABLE 1004.1.2  
30,477 SF @ 100 SF/OCCUPANT = 305 PEOPLE  
EGRESS WIDTH PER OCCUPANT SERVED - TABLE 1005.1

CHAPTER 29 - PLUMBING SYSTEMS  
MIN. NUMBER OF REQUIRED PLUMBING FIXTURES - TABLE 2902.1  
WATER CLOSETS REQUIRED - 1 PER 25 FOR THE FIRST 50 (2) AND 1 PER 50 FOR THE REMAINDER EXCEEDING 50. (6)  
WATER CLOSETS PROVIDED - 11  
URINALS PROVIDED - 0  
LAVATORIES REQUIRED - 1 PER 40 FOR THE FIRST 50 (1) AND 1 PER 80 FOR THE REMAINDER EXCEEDING 50. (4)  
LAVATORIES PROVIDED - 11  
DRINKING FOUNTAINS REQUIRED - 1 PER 100  
DRINKING FOUNTAINS PROVIDED - 4  
SERVICE SINKS REQUIRED - 1  
SERVICE SINKS PROVIDED - 1

### BIDDING PRECAUTIONS

1. PRIOR TO SUBMITTING PROPOSALS, BIDDERS SHALL EXAMINE DRAWINGS AND SPECIFICATIONS AND CONDUCT A PERSONAL EXAMINATION OF THE SITE AND BECOME AWARE OF ALL EXISTING CONDITIONS AND LIMITATIONS AFFECTING THE WORK AND THEIR PROPOSAL.

### GENERAL NOTES

- TO BE CONSTRUCTED UNDER 2007 OBC, CITY OF COLUMBUS BUILDING INSPECTION DEPARTMENT MATERIALS AND CONSTRUCTION FOR SEWERAGE TO MEET LOCAL CODES. BUILDING MATERIALS AND CONSTRUCTION TO MEET LOCAL CODES AND THE OHIO BUILDING CODE. ALL PROPER PERMITS MUST BE OBTAINED FOR ALL CONSTRUCTION WORK (WHICH HAS BEEN APPROVED BY PROPER DEPARTMENTS) PRIOR TO ANY CONSTRUCTION. ALL CONTRACTORS, INCLUDING GENERAL, HVAC, ELECTRICAL AND PLUMBING MUST BE LICENSED TO DO WORK WITHIN THE GOVERNING MUNICIPALITY.
- THE CONTRACTOR SHALL VERIFY ALL FIRE EXTINGUISHER LOCATIONS WITH THE LOCAL FIRE DEPARTMENT AND SHALL COMPLY WITH ALL NFPA AND FIRE DEPARTMENT REQUIREMENTS.
- CONTRACTOR TO VERIFY ALL EXISTING CONDITIONS, DIMENSIONS, ETC. PRIOR TO ANY CONSTRUCTION AND SHALL REPORT ANY DISCREPANCIES IMMEDIATELY TO THE ARCHITECT FOR CLARIFICATION OR RESOLUTION.
- ALL DIMENSIONS ARE CLEAR DISTANCE FROM FACE OF STUD TO FACE OF STUD AND/OR EXISTING WALL(S), UNLESS NOTED OTHERWISE.
- PROVIDE BEHIND WALL REINFORCING AND BLOCKING AS REQUIRED FOR ATTACHMENT OF MILLWORK, CASEWORK, TOILET ACCESS, ETC.
- ALL STUDS WALLS NOT BUILT TO DECK ABOVE SHALL BE BRACE AS REQUIRED FOR LATERAL SUPPORT.
- THESE DESIGNS AND ALL ITEMS DEPICTED HEREIN, WHETHER IN WRITING OR GRAPHICALLY, AS INSTRUMENTS OF PROFESSIONAL SERVICE, MAY NOT BE ALTERED OR CHANGED, IN ANY WAY, WITHOUT THE PRIOR KNOWLEDGE AND WRITTEN CONSENT OF THE ARCHITECT. ANY CHANGE MADE WITHOUT THE ARCHITECT'S WRITTEN APPROVAL WILL VOID ALL SUCH DOCUMENTS AND INSTRUMENTS AND THE ARCHITECT WILL NOT BE PERSONALLY LIABLE FOR ANY DAMAGE, HARM OR LOSS CAUSED THEREBY.

### SYMBOL LEGEND

- INDICATES WALL CONSTRUCTION TYPE, REFER TO WALL TYPE LEGEND FOR WALL ASSEMBLY DESCRIPTIONS
- RECEPTION [104] INDICATES ROOM NAME AND NUMBER, REFER TO INTERIOR SHEETS FOR ROOM FINISH MATERIALS
- INDICATES DOOR TYPE(S) - REFER TO SHEET A/B FOR DOOR AND FRAME MATERIALS AND ELEVATIONS
- TYPICAL SECTION AND DETAIL FLAGS:
- REFERS TO SECTION OR ELEVATION NUMBER
- REFERS TO DRAWING SHEET NUMBER
- INDICATES EXISTING WINDOWS TO REMAIN.
- FLAG NOTE
- INDICATES EXISTING EXTERIOR WALL
- INDICATES NEW WALL

### ACCESSIBILITY REQUIREMENTS

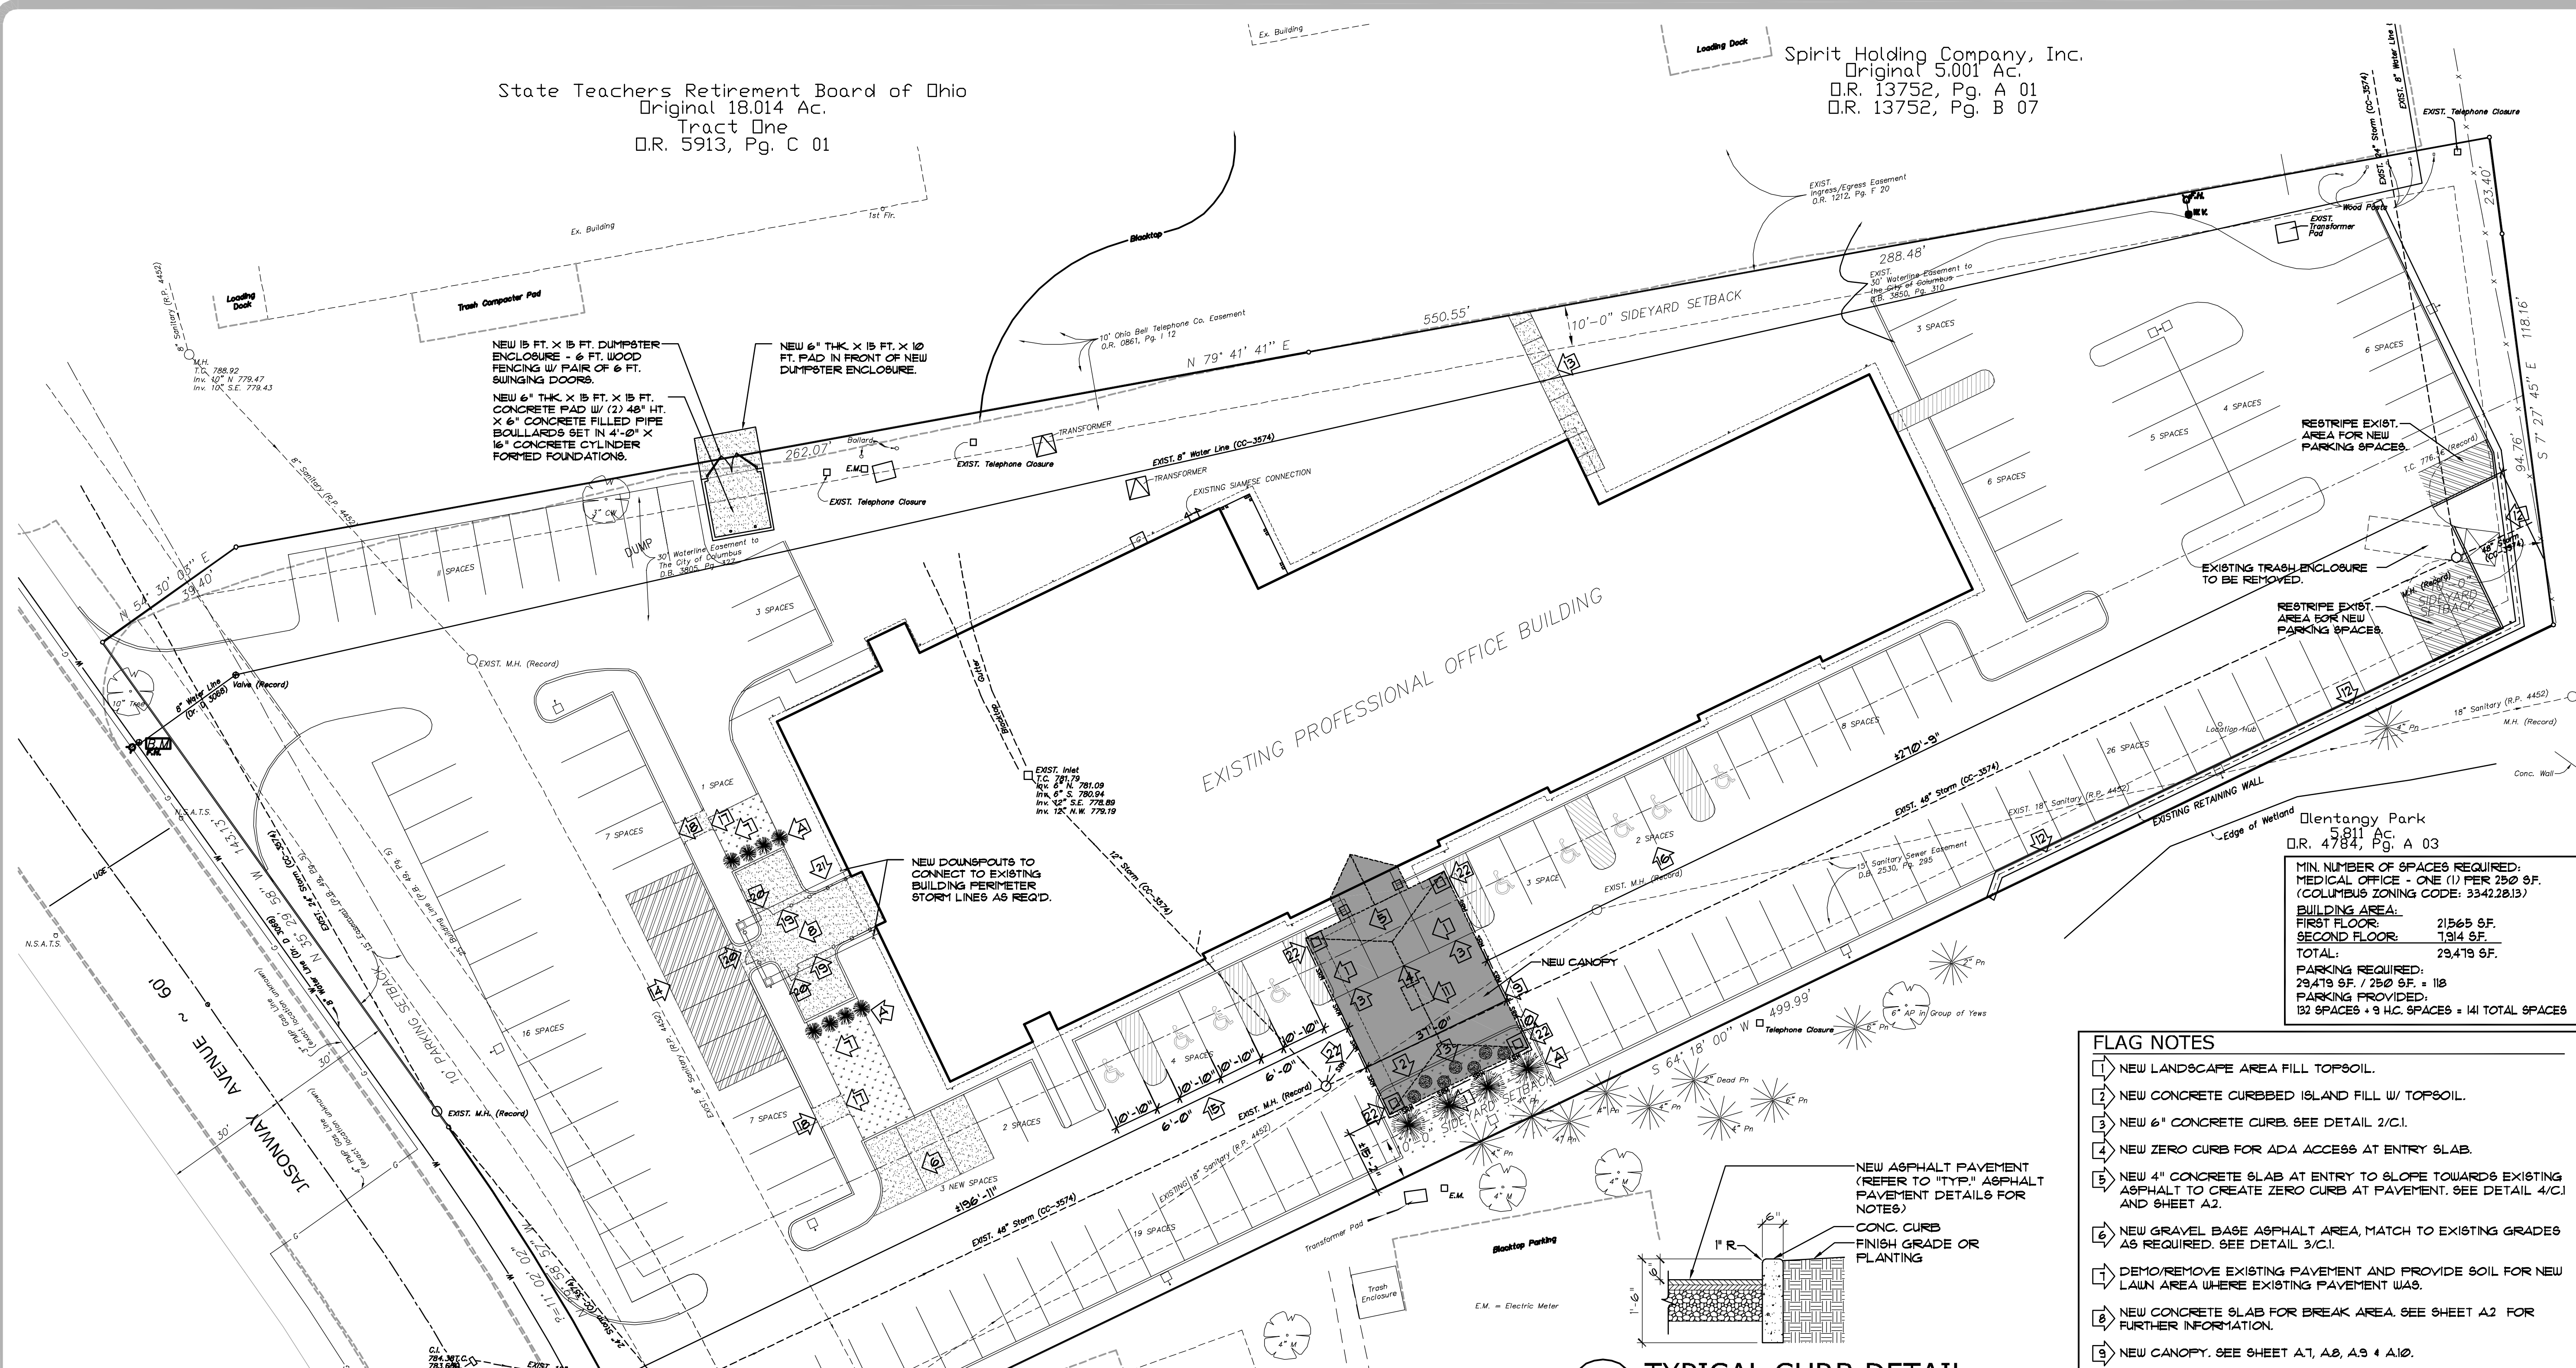
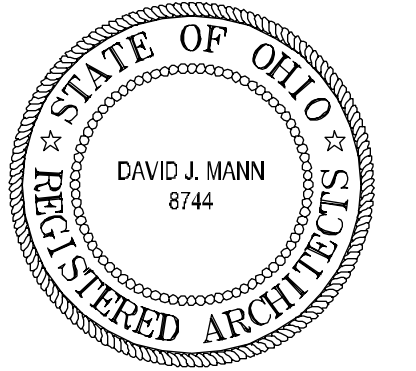
- ALL PUBLIC AND HANDICAP ACCESSIBLE RESTROOM FACILITIES, ELECTRIC WATER COOLERS, PUBLIC SPACES, AND HANDICAP GUESTROOMS SHALL BE IN FULL COMPLIANCE WITH THE AMERICANS WITH DISABILITIES ACT (ADA AND ADAAG) AND ANSI INCLUDING BUT NOT LIMITED TO THE FOLLOWING:
  - ENTRY RAMP
  - ENTRY AND EXIT DOORS
  - EXIT STAIRS AND EXIT ACCESS CORRIDORS
  - HANDICAP RESTROOM FACILITIES
  - DOOR HARDWARE AND CLEARANCES

### DRAWING INDEX

- T10 TITLE SHEET
- C1 CIVIL SITE PLAN
- ARCHITECTURAL
- D1 DEMOLITION FIRST FLOOR PLAN - WEST
- D2 DEMOLITION FIRST FLOOR - EAST
- D3 DEMOLITION PARTIAL SECOND FLOOR PLAN
- A0 OVERALL FIRST FLOOR PHASING PLAN
- A1 NOT USED
- A2 FIRST FLOOR LIFE SAFETY PLAN
- A3 SECOND FLOOR LIFE SAFETY PLAN
- A4 FIRST FLOOR PLAN - WEST
- A5 FIRST FLOOR PLAN - EAST
- A6 PARTIAL SECOND FLOOR PLAN
- A7 CANOPY ROOF PLAN
- A8 CANOPY ELEVATIONS
- A9 CANOPY SECTIONS
- A10 EXTERIOR ELEVATIONS
- A11 ENLARGED ROOMS + INTERIOR ELEVATIONS
- A12 ENLARGED ROOMS + INTERIOR ELEVATIONS
- A13 ENLARGED ROOMS + INTERIOR ELEVATIONS
- A14 ENLARGED ROOMS + INTERIOR ELEVATIONS
- A15 DOOR SCHEDULE AND NOTES
- A16 FIRST FLOOR REFLECTED CEILING PLAN - WEST
- A17 FIRST FLOOR REFLECTED CEILING PLAN - EAST
- A18 PARTIAL SECOND FLOOR REFLECTED CEILING
- INTERIORS
- ID-1 FIRST FLOOR FINISHES - WEST
- ID-2 FIRST FLOOR FINISHES - EAST
- ID-3 FIRST FLOOR FINISHES - OVERALL PLAN
- ID-4 SECOND FLOOR FINISHES - WEST
- ID-5 ROOM FINISH SCHEDULE
- MECHANICAL + PLUMBING
- H1 HVAC DEMOLITION PLAN
- H2 HVAC PLANS
- H3 HVAC PLANS
- H4 HVAC SCHEDULES / DETAILS
- P1 PLUMBING DEMOLITION PLAN
- P2 PLUMBING PLAN - WEST
- P3 PLUMBING PLAN - EAST
- P4 PLUMBING SCHEDULES / DETAILS
- ELECTRICAL
- E11 FIRST FLOOR DEMOLITION PLAN
- E12 SECOND FLOOR DEMOLITION PLAN
- E21 FIRST FLOOR LIGHTING PLAN - WEST
- E22 FIRST FLOOR LIGHTING PLAN - EAST
- E23 SECOND FLOOR LIGHTING PLAN
- E31 FIRST FLOOR POWER PLAN - WEST
- E32 FIRST FLOOR POWER PLAN - EAST
- E33 SECOND FLOOR POWER PLAN
- E41 ELECTRICAL SPECIFICATIONS

State Teachers Retirement Board of Ohio  
Original 18,014 Ac.  
Tract One  
D.R. 5913, Pg. C 01

Spirit Holding Company, Inc.  
Original 5,001 Ac.  
D.R. 13752, Pg. A 01  
D.R. 13752, Pg. B 07



EXISTING PROFESSIONAL OFFICE BUILDING


Olentangy Park  
5.811 Ac.  
D.R. 4784, Pg. A 03

MIN. NUMBER OF SPACES REQUIRED:	
MEDICAL OFFICE - ONE (1) PER 250 SF.	
(COLUMBUS ZONING CODE: 3342.2B13)	
<b>BUILDING AREA:</b>	
FIRST FLOOR:	21,565 SF.
SECOND FLOOR:	1,914 SF.
<b>TOTAL:</b>	23,479 SF.
<b>PARKING REQUIRED:</b>	29,479 SF. / 250 SF. = 118
<b>PARKING PROVIDED:</b>	132 SPACES + 9 H.C. SPACES = 141 TOTAL SPACES


Morgan Lumber Sales Company  
D.R. 7081, Pg. D 20

**SITE PLAN**  
SCALE: 20'-0" = 1'-0"

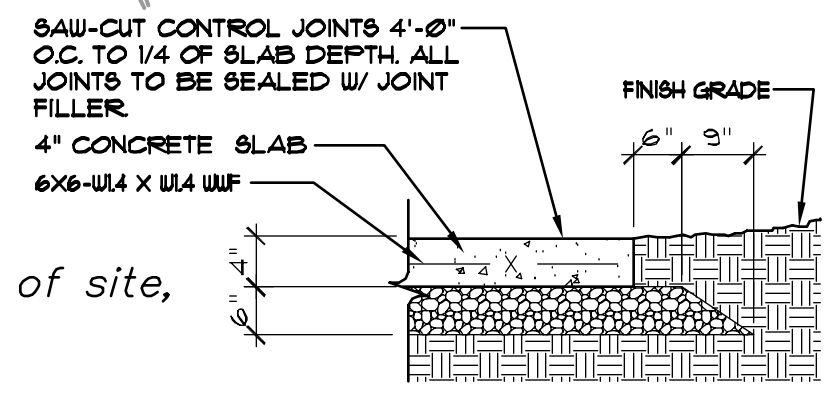
NOTE: C.M. TO COORDINATE NEW LANDSCAPING SELECTIONS W/ OWNER AND INSTALL W/ HARDWOOD MULCH BEDDING.



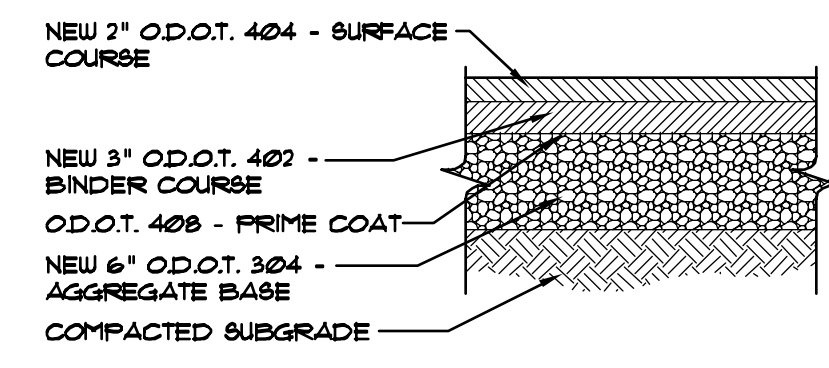
**4 CONCRETE SIDEWALK**  
C.1 SCALE: 1/2" = 1'-0"



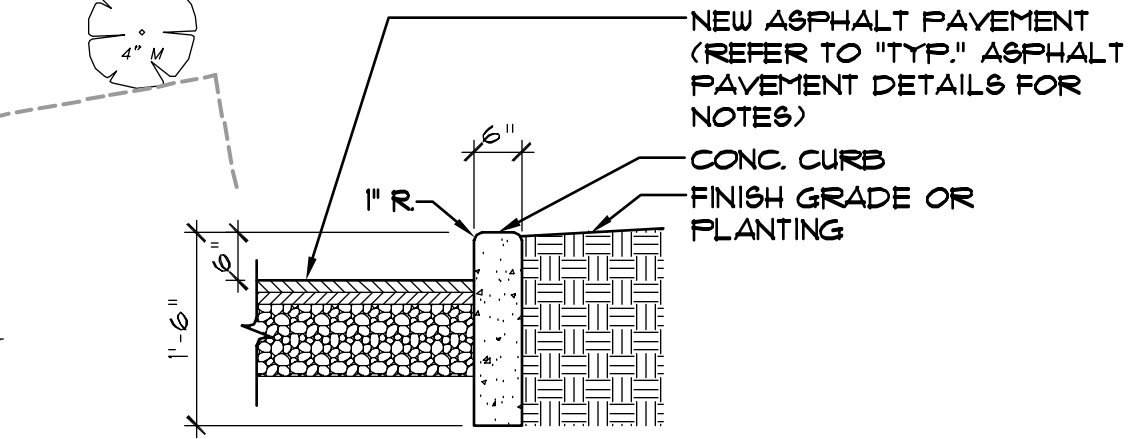**3 ASPHALT PAVEMENT PROFILE**  
C.1 SCALE: 1/2" = 1'-0"



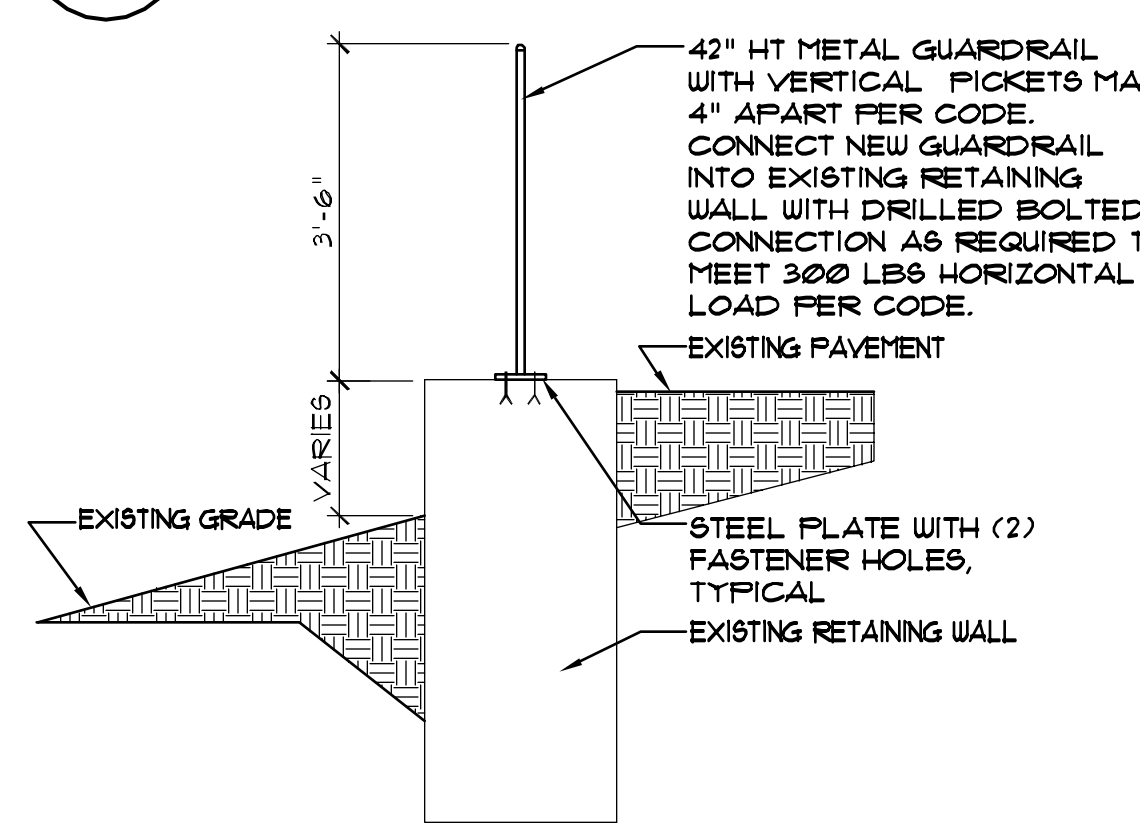**2 TYPICAL CURB DETAIL**  
C.1 SCALE: 1/2" = 1'-0"



**1 METAL GUARDRAIL**  
C.1 SCALE: 1/2" = 1'-0"

- FLAG NOTES**
- 1 NEW LANDSCAPE AREA FILL TOPSOIL.
  - 2 NEW CONCRETE CURBED ISLAND FILL W/ TOPSOIL.
  - 3 NEW 6" CONCRETE CURB. SEE DETAIL 2/C.1.
  - 4 NEW ZERO CURB FOR ADA ACCESS AT ENTRY SLAB.
  - 5 NEW 4" CONCRETE SLAB AT ENTRY TO SLOPE TOWARDS EXISTING ASPHALT TO CREATE ZERO CURB AT PAVEMENT. SEE DETAIL 4/C.1 AND SHEET A2.
  - 6 NEW GRAVEL BASE ASPHALT AREA, MATCH TO EXISTING GRADES AS REQUIRED. SEE DETAIL 3/C.1.
  - 7 DEMO/REMOVE EXISTING PAVEMENT AND PROVIDE SOIL FOR NEW LAWN AREA WHERE EXISTING PAVEMENT WAS.
  - 8 NEW CONCRETE SLAB FOR BREAK AREA. SEE SHEET A2 FOR FURTHER INFORMATION.
  - 9 NEW CANOPY. SEE SHEET A1, A2, A3 & A10.
  - 10 NEW CANOPY COLUMN. TYPICAL FOR 6.
  - 11 NEW CUPOLA ON NEW CANOPY. SEE A1, A2, A3 & A10.
  - 12 NEW 42" HIGH GUARDRAIL. SEE DETAIL 1/C.1.
  - 13 NEW 5'-0" WIDE CONCRETE SIDEWALK. C.M. TO ADJUST GRADE ACCORDINGLY TO ALLOW FOR MIN. SLOPING WALK. SEE DETAIL 4/C.1 & A5.
  - 14 AREA TO BE RE-STRIPED TO CREATE NORMAL PARKING SPACES.
  - 15 RE-STRIPED TO CREATE (4) H.C. PARKING SPACES WITH LOADING AREA PER CODE.
  - 16 PAINT H.C. CHAIR SYMBOL ON EXISTING (2) SPACES.
  - 17 REMOVE EXISTING CONCRETE CURB.
  - 18 REMOVE EXISTING CONCRETE SIDEWALK AND REPLACE WITH NEW LANDSCAPE. LANDSCAPE BY OWNER.
  - 19 NEW 4'-0" HT. ALUM. 'POOL' FENCE WITH VERTICAL PICKETS AND SUPPORT POSTS AS REQ'D. COLOR SELECTION BY OWNER.
  - 20 NEW 3'-0" W. MIN. SWINGING GATE TO ALLOW ACCESS/EGRESS FROM EMPLOYEE TERRACE.
  - 21 NEW WOOD ROOF STRUCTURE BUILT ON EXISTING STEEL BEAMS - SEE SHEET A1.
  - 22 NEW DOWNSPOUTS TO CONNECT TO CLOSEST EXISTING CATCH BASIN. G.C. TO CONNECT NEW STORM LINE TO EXISTING UNDERGROUND STORM AS REQ'D. PATCH AND REPAIR EXISTING ASPHALT AS REQ'D.

BENCH MARK  
W. Bolt of Fire Hydrant, 24± S. of N.W. corner of site,  
E. side of Jasonway Avenue.  
Elev. 787.53  
(U.S.G.S. Datum)

revisions


3660 embassy parkway  
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fax. 330.666.8812  
web site www.mann-architects.com



drawing  
SITE PLAN  
project no. 11406  
date OCTOBER 23, 2001  
scale AS NOTED

**COLUMBUS ONCOLOGY**  
JASONWAY PROFESSIONAL BUILDING  
810 JASONWAY AVENUE, SUITE A  
COLUMBUS, OHIO 43214-2329

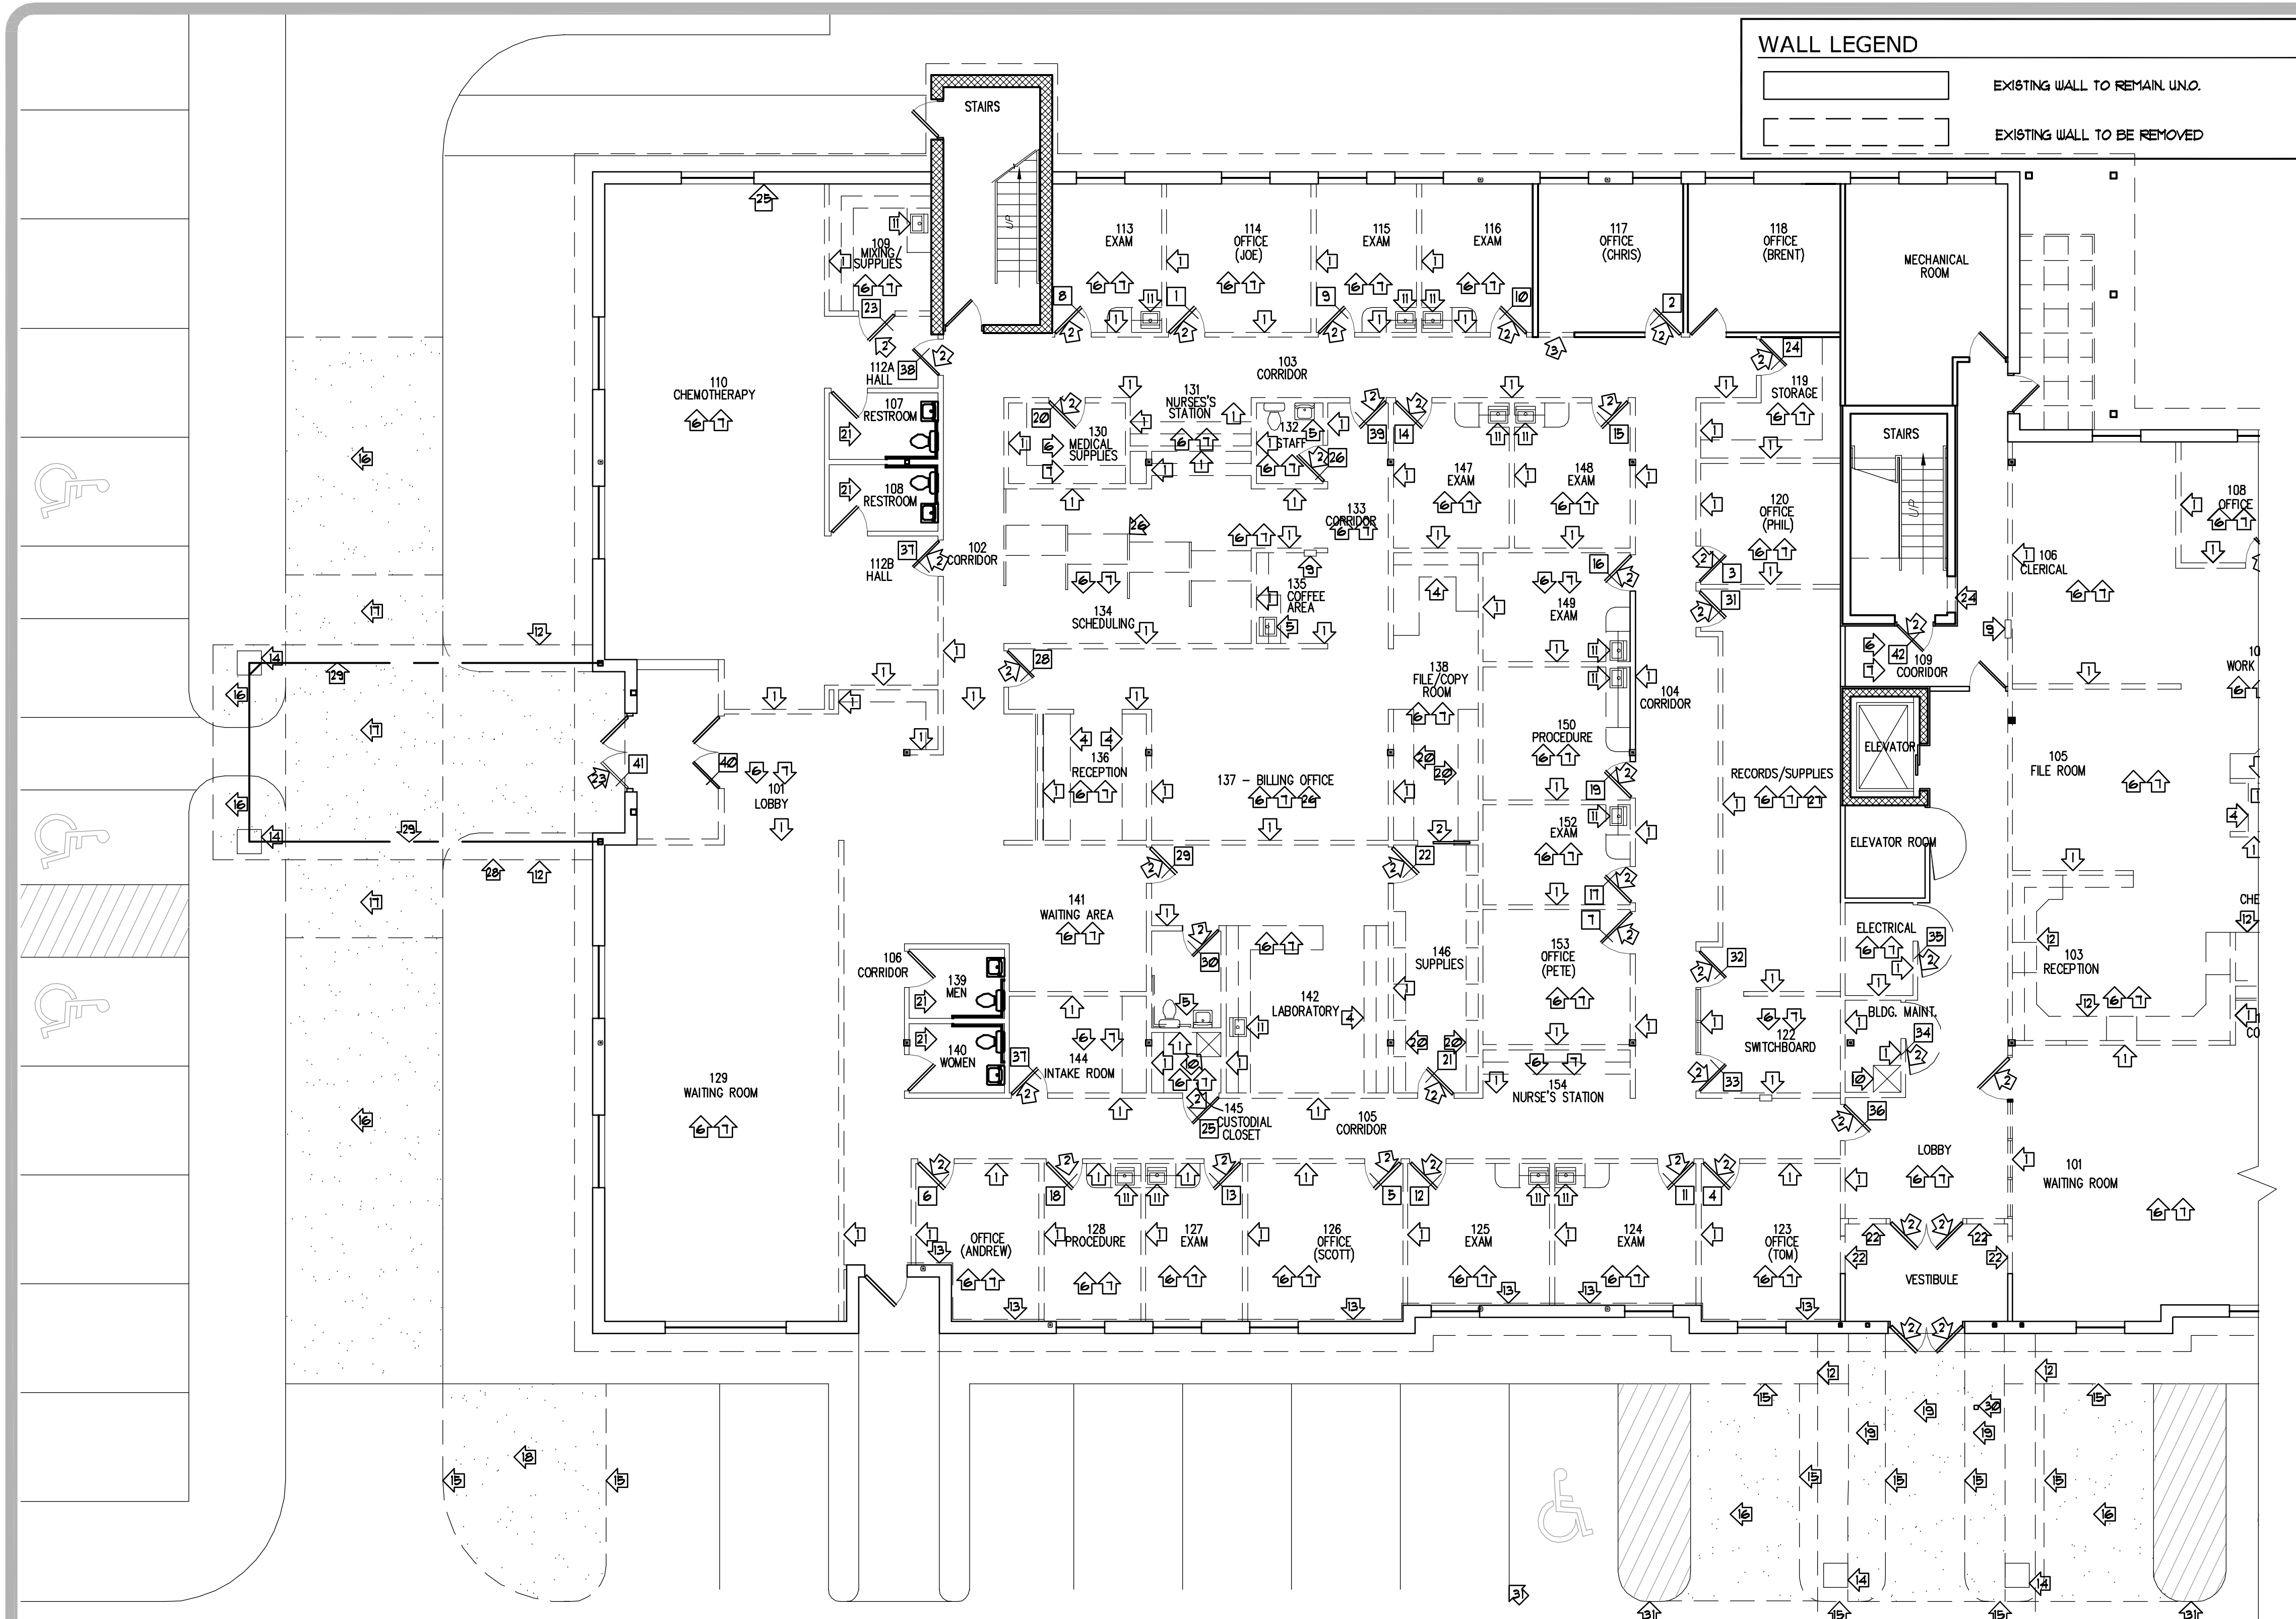**C.1**  
OF 1  
sheet no.



**WALL LEGEND**

	EXISTING WALL TO REMAIN UNO.
	EXISTING WALL TO BE REMOVED

**DOOR REUSE TABLE WEST WING (WU)**

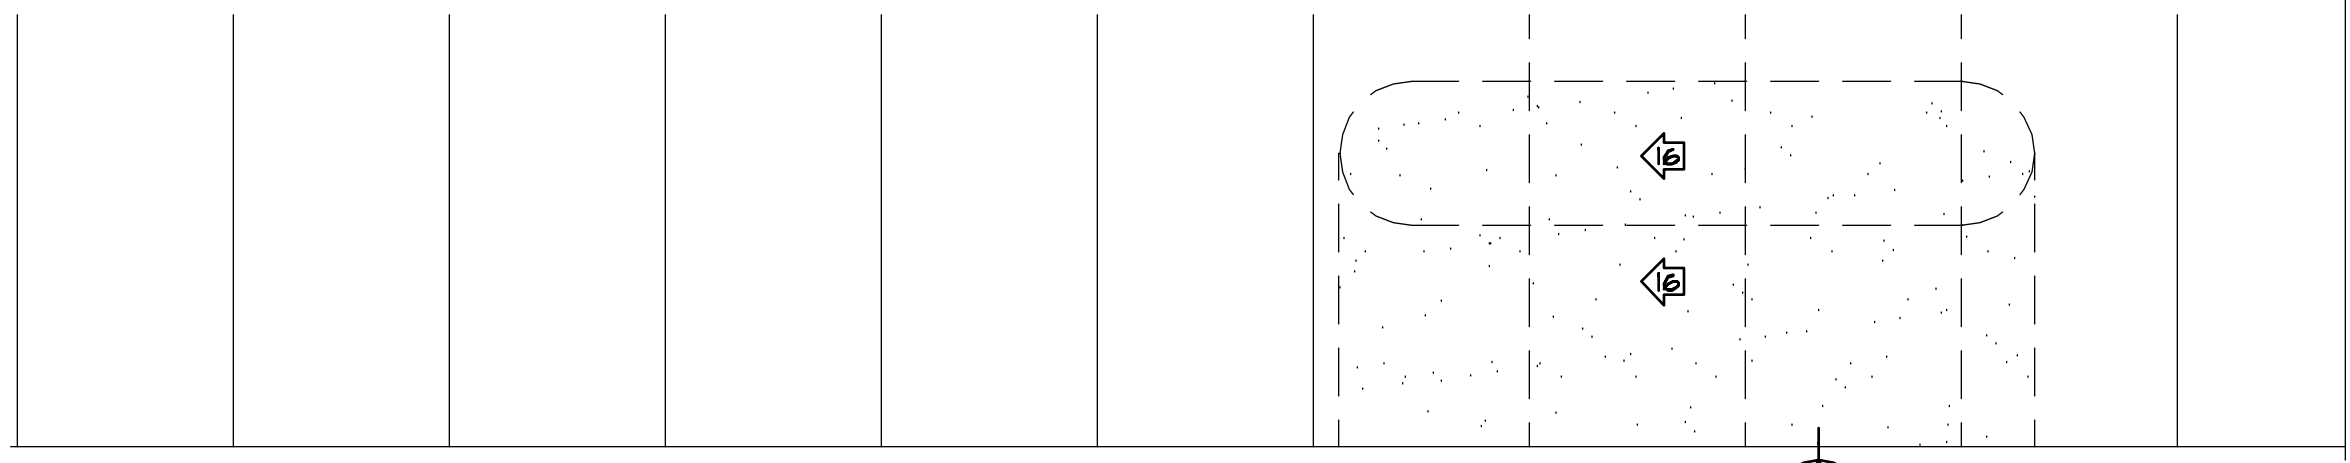
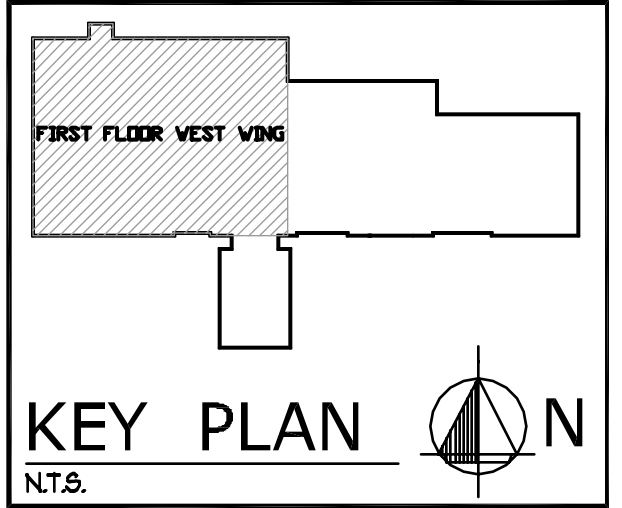
EXISTING DOOR #	EXIST. ROOM NAME/NUMBER	NEW ROOM NAME/NUMBER	EXISTING DOOR #	EXIST. ROOM LOCATION	NEW ROOM LOCATION
1	OFFICE 114	OFFICE 138	22	SUPPLIES 146	OFFICE 56 (1)
2	OFFICE 117	STAFF 150	23	MIX SUPPL. 109	-
3	OFFICE 120	CORR 154	24	STORAGE 119	STORAGE 143
4	OFFICE 123	OFFICE 131	25	CUST. 145	LINEN 114
5	OFFICE 126	TRIAGE III	26	REST. R. 132	-
6	OFF. ANDREW	OFFICE 118	27	INTAKE 144	OFFICE 56 (2)
7	OFFICE 193	EXAM 120	28	BILLING 151	REG. 128 (2)
8	EXAM 113	EXAM 145	29	LAB 142	CORR 149
9	EXAM 115	EXAM 146	30	REST LAB	-
10	EXAM 116	EXAM 134	31	RECORDS	OFFICE 111
11	EXAM 124	EXAM 206	32	RECORDS	-
12	EXAM 125	EXAM 121	33	SWITCH 122	OFFICE 122
13	EXAM 121	EXAM 123	34	BLDG MAINT.	-
14	EXAM 141	EXAM 132	35	ELECTRICAL	-
15	EXAM 148	EXAM 141	36	CORR 125	REG. 128 (1)
16	EXAM 149	EXAM 125	37	CORR 122	-
17	EXAM 152	OFFICE 210	38	CORR 123	CORR 121
18	PROC. RM 128	PROC. RM 113	39	CORR 133	-
19	PROC. RM 150	PROC. RM 148	40	LOBBY 101	-
20	SUPPLY 130	-	41	LOBBY 101	-
21	SUPPLIES 146	FLS. 144-1	42	STAIRS	-

**NOTE:**  
CONTRACTOR TO SAVE UNUSED DOORS HARDWARE AND USE AS "STOCK" FOR REUSING RELOCATED DOORS AS NEEDED. SOME HARDWARE REUSING OR CHANGING MAY OCCUR TO ADDRESS EXISTING DOOR NEW LOCATION REQUIREMENT.


- DEMOLITION FLAG NOTES:**
- EXISTING WALL TO BE REMOVED IN ITS ENTIRETY.
  - EXISTING DOOR/FRAME AND HARDWARE TO BE REMOVED. REFER TO DOOR REUSE TABLE ON THIS SHEET.
  - REMOVE PORTION OF WALL AND PREP FOR NEW DOOR.
  - REMOVE EXISTING MILLWORK, CABINETS, COUNTER AND MISC. IN ITS ENTIRETY.
  - EXISTING LAVS, COUNTER TOP, WATER CLOSET, MIRROR, ETC. TO BE REMOVED
  - REMOVE EXISTING FLOORING FINISHES, ADHESIVES AND BASE. PATCH AS REQUIRED, PREP FOR NEW FINISH FLOOR.
  - REMOVE EXISTING CEILING FINISHES AND GRID. REMOVE ALL LIGHTING FIXTURES AS REQUIRED.
  - EXISTING LOW WALL TO BE REMOVED IN ITS ENTIRETY.
  - REMOVE DEVICE IN ITS ENTIRETY. REFER TO OTHER DRAWINGS FOR RELOCATION.
  - REMOVE JANITORS SINK IN ITS ENTIRETY AND SAVE FOR REUSE.
  - REMOVE SINK AND CABINET IN ITS ENTIRETY.
  - REMOVE EXISTING CANOPY AND ALUM. SUPPORTS.
  - REMOVE EXISTING GYP. BOARD FROM EXTERIOR WALL AND ALLOW OWNER'S INSECT EXTERMINATOR TO ACCESS WALL CAVITY AND TREAT WALLS AS REQ'D.
  - EXISTING BRICK COLUMN TO REMAIN.
  - REMOVE EXISTING CONCRETE CURB AND SIDEWALK AS REQUIRED - SEE SHEET A2.
  - REMOVE EXISTING ASPHALT, PREPARE NEW LANDSCAPE, ADD SOIL AND PLANT GRASS.
  - REMOVE EXISTING ASPHALT AND PREPARE FOR NEW CONCRETE SLAB/PATIO - SEE SHEET A2.
  - REMOVE EXISTING LANDSCAPE AND PREPARE FOR NEW ASPHALT FOR PARKING SPACES - SEE SHEET C1 FOR INFORMATION AND PAVING DETAILS.
  - REMOVE EXISTING CONCRETE AND LANDSCAPE AND PREPARE FOR NEW SLOPED CONCRETE SLAB - SEE SHEET A2.
  - EXISTING STORAGE SHELVES TO BE RELOCATED TO DEBOX #91 - CM SHALL PROVIDE NEW BRACKETS AS REQUIRED FOR THESE SHELVES.
  - EXISTING RESTROOMS TO REMAIN - SEE ROOM FINISH SCHEDULE FOR NEW FINISHES.
  - REMOVE EXISTING GYPSUM BOARD/STUD WALL AS REQUIRED FOR NEW STOREFRONT SYSTEM - SEE SHEETS A4 AND A15 FOR ADDITIONAL INFORMATION.
  - REMOVE SOUTH DOOR AND MODIFY FRAME TO INSERT NEW SIDE LITE, NORTH DOOR TO REMAIN - SEE SHEETS A4 AND A15 FOR ADDITIONAL INFORMATION.
  - REMOVE PORTION OF EXISTING MASONRY WALL W/ GYP. BD. FINISH TO ALLOW FOR 3'-4" OPENING.
  - CM TO INVESTIGATE SOURCE OF ODOR IN THIS AREA - DEMOLITION MAY BE NEEDED IN WALL OR ABOVE CEILING TO AID EXPLORATION.
  - EXISTING FURNITURE UNITS TO BE REMOVED.
  - EXISTING MEDICAL RECORDS ROLLING FILES TO BE REMOVED AND RELOCATED BY CM.
  - SEE SHEET A1 FOR NEW ROOF AT EMPLOYEE TERRACE.
  - EXISTING STEEL BEAMS TO REMAIN, SEE SHEET A4.1.
  - EXISTING DOOR OPERATOR TO REMAIN.
  - RESTRIP PARKING SPACES, SEE SHEET C-1 FOR NEW LAYOUT AND ADDED HANDICAP PARKING SPACES. PROVIDE HANDICAP SIGNS PER LOCAL CODES.

**NOTE:**  
ALL DOORS, FRAME, HARDWARE, SINKS, FAUCETS, WATERCLOSETS TO BE SAVED AND REINSTALLED THROUGHOUT PROJECT. REFER TO DRAWINGS FOR LOCATION OF RE-INSTALLATION OF ITEMS.

- GENERAL DEMOLITION NOTES:**
- SOME NON-DEMO ITEMS MAY BE INDICATED ON THE DEMOLITION PLAN WHICH ARE INCLUDED TO DESCRIBE THE OVERALL SCOPE OF THE PROJECT AND TO AID IN THE CONTRACTOR'S COORDINATION. THE DEMOLITION CONTRACTOR IS RESPONSIBLE FOR ALL WORK REQUIRED TO COMPLETE THE INTENT OF THE CONTRACT DOCUMENTS.
  - REFER TO PLUMBING, MECHANICAL AND ELECTRICAL DRAWINGS FOR ADDITIONAL DEMOLITION WORK.
  - THE DEMOLITION CONTRACTOR SHALL COORDINATE ACTUAL DIMENSIONS, LOCATIONS OF OPENINGS, UTILITY LOCATIONS, SYSTEM REQUIREMENTS, ETC. WITH ALL OTHER CONTRACT DOCUMENTS AND OTHER CONTRACTORS.
  - ALL SURFACES, FURNISHINGS, EQUIPMENT, ETC. ADJACENT TO DEMOLITION AREAS SHALL BE PROTECTED FROM DAMAGE.
  - DEMOLITION CONTRACTOR SHALL BE RESPONSIBLE FOR NOTIFYING THE GENERAL CONTRACTOR PRIOR TO REMOVING THROUGH ROOF ITEMS OR OPENING EXTERIOR WALLS.
  - DEMOLITION CONTRACTOR SHALL BE RESPONSIBLE FOR OBTAINING ALL NECESSARY PERMITS AND FOLLOWING THE REQUIREMENTS FOR DEMOLITION WORK WITHIN THE GOVERNING MUNICIPALITY.





SCALE: 1/8" = 1' - 0"

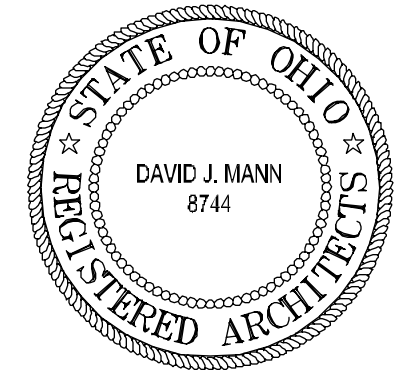

revisions

3660 embassy parkway  
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fax. 330.666.8812  
web site www.mann-architects.com

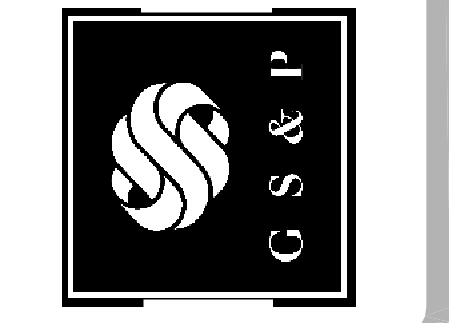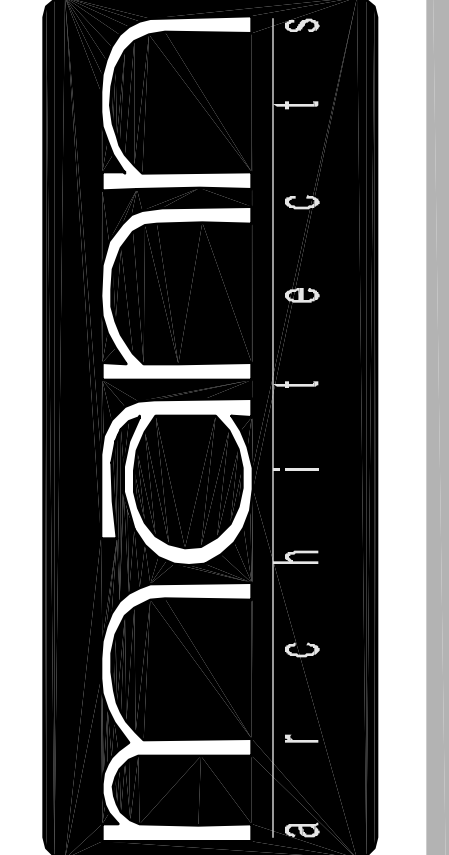


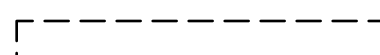
drawing  
DEMOLITION FIRST FLOOR - WEST scale  
project no. 11406 date OCTOBER 23, 2001 AS NOTED  
COLUMBUS ONCOLOGY  
JASONWAY PROFESSIONAL BUILDING  
810 JASONWAY AVENUE SUITE A  
COLUMBUS, OHIO 43214-2329  
project

**D.1**  
OF 3  
sheet no.

**GENERAL DEMOLITION NOTES:**

- SOME NON-DEMO ITEMS MAY BE INDICATED ON THE DEMOLITION PLAN WHICH ARE INCLUDED TO DESCRIBE THE OVERALL SCOPE OF THE PROJECT AND TO AID IN THE CONTRACTOR'S COORDINATION. THE DEMOLITION CONTRACTOR IS RESPONSIBLE FOR ALL WORK REQUIRED TO COMPLETE THE INTENT OF THE CONTRACT DOCUMENTS.
- REFER TO PLUMBING, MECHANICAL AND ELECTRICAL DRAWINGS FOR ADDITIONAL DEMOLITION WORK.
- THE DEMOLITION CONTRACTOR SHALL COORDINATE ACTUAL DIMENSIONS, LOCATIONS OF OPENINGS, UTILITY LOCATIONS, SYSTEM REQUIREMENTS, ETC. WITH ALL OTHER CONTRACT DOCUMENTS AND OTHER CONTRACTORS.
- ALL SURFACES, FURNISHINGS, EQUIPMENT, ETC. ADJACENT TO DEMOLITION AREAS SHALL BE PROTECTED FROM DAMAGE.
- DEMOLITION CONTRACTOR SHALL BE RESPONSIBLE FOR NOTIFYING THE GENERAL CONTRACTOR PRIOR TO REMOVING THROUGH ROOF ITEMS OR OPENING EXTERIOR WALLS.
- DEMOLITION CONTRACTOR SHALL BE RESPONSIBLE FOR OBTAINING ALL NECESSARY PERMITS AND FOLLOWING THE REQUIREMENTS FOR DEMOLITION WORK WITHIN THE GOVERNING MUNICIPALITY.

**WALL LEGEND**

-  EXISTING WALL TO REMAIN. U.N.O.
-  EXISTING WALL TO BE REMOVED

**DEMOLITION FLAG NOTES:**

- EXISTING WALL TO BE REMOVED IN ITS ENTIRETY.
- EXISTING DOOR/FRAME AND HARDWARE TO BE REMOVED. REFER TO DOOR REUSE TABLE ON THIS SHEET.
- EXISTING RESTROOMS TO REMAIN - SEE ROOM FINISH SCHEDULE FOR NEW FINISHES.
- REMOVE EXISTING MILLWORK, CABINETS, COUNTER AND FACE WALL IN ITS ENTIRETY.
- EXISTING LAVS, COUNTER TOP, WATER CLOSET, MIRROR, ETC. TO BE REMOVED. PLUMBING FIXTURES TO BE REUSED. SEE PLUMBING SHEETS FOR MORE INFORMATION.
- REMOVE EXISTING FLOORING FINISHES, ADHESIVES, BASE AND PATCH AS REQ'D. PREP FOR NEW FINISH FLOOR.
- REMOVE EXISTING CEILING FINISHES AND GRID. REMOVE ALL LIGHTING FIXTURES AS REQUIRED.
- EXISTING LOW WALL TO BE REMOVED IN ITS ENTIRETY.
- REMOVE DEVICE IN ITS ENTIRETY. REFER TO OTHER DRAWINGS FOR RELOCATION.
- REMOVE JANITORS SINK IN ITS ENTIRETY.
- REMOVE SINK/CABINET AND COUNTERTOP AND REUSE IN NEW LOCATIONS - REFER TO FLOOR PLAN SHEET A.4 & A.5.
- REMOVE EXISTING COUNTERTOP, SINKS, AND UPPER/LOWER CABINETS - REUSE UPPER & LOWER CABINETS PER SHEETS A11, A12, & A13.
- REMOVE EUC AND SAVE FOR REUSE - SEE PLUMBING DRAWINGS FOR MORE INFORMATION.

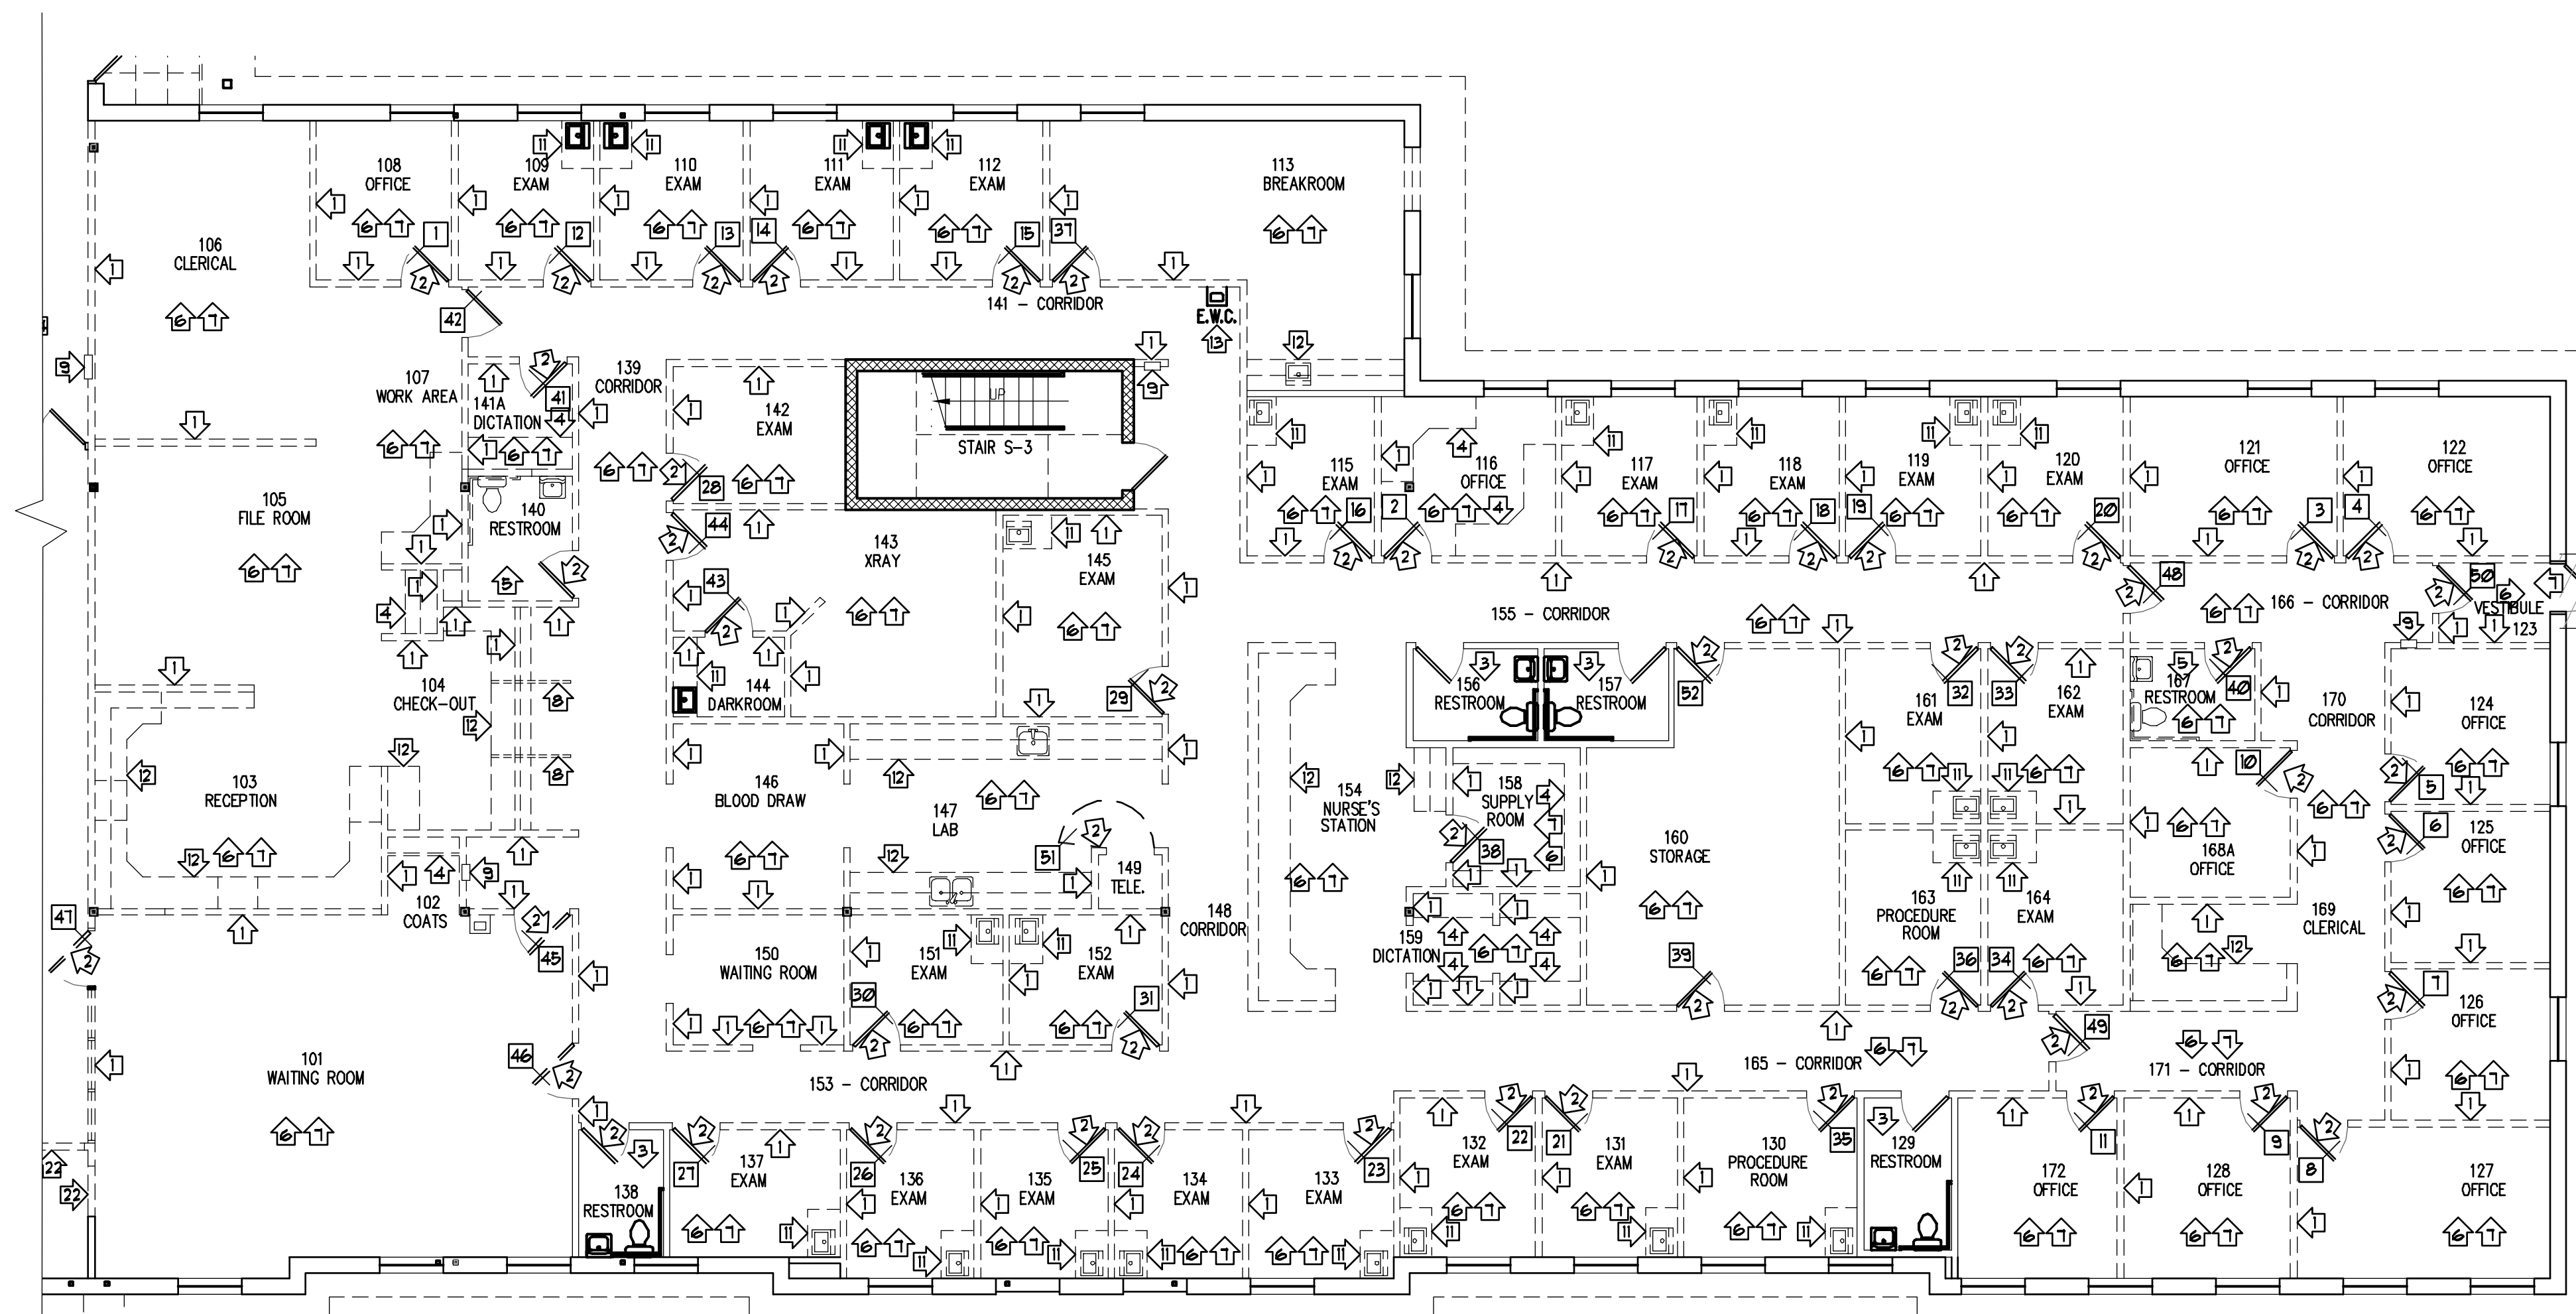
**DOOR REVISED TABLE - EAST WING (EW)**

EXISTING DOOR #	EXIST. ROOM NAME	NEW ROOM NAME	EXISTING DOOR #	EXIST. ROOM LOCATION	NEW ROOM LOCATION
1	OFFICE 108	ACC. 162	27	EXAM 131	-
2	OFFICE 116	OFFICE 163	28	EXAM 142	-
3	OFFICE 121	ACC. 163	29	EXAM 145	-
4	OFFICE 122	OFFICE 110	30	EXAM 151	EXAM 116
5	OFFICE 124	OFFICE 167	31	EXAM 152	-
6	OFFICE 125	OFFICE 190	32	EXAM 161	EXAM 118
7	OFFICE 126	OFFICE 189	33	EXAM 162	-
8	OFFICE 127	DEBOX 191	34	EXAM 164	EXAM 184
9	OFFICE 128	SOIL C115	35	PROC. 130	EXAM 164
10	OFFICE 168A	-	36	PROC. 163	-
11	OFFICE 112	-	37	BREAKR 113	-
12	EXAM 109	EXAM 160	38	SUPPLY R. 150	-
13	EXAM 110	-	39	STORAGE 160	STORAGE C11
14	EXAM 111	EXAM 161	40	REST. R. 167	-
15	EXAM 112	-	41	DICT. 141A	-
16	EXAM 115	-	42	CORR 141	-
17	EXAM 117	-	43	DARK R. 144	-
18	EXAM 118	-	44	X RAY 143	-
19	EXAM 119	EXAM 115	45	WAITING 101	PH-LAB C104
20	EXAM 120	-	46	WAITING 101	MA 119 (2)
21	EXAM 131	-	47	WAITING 101	CORR C107
22	EXAM 132	EXAM 117	48	CORR 155	MA 119 (1)
23	EXAM 133	-	49	CORR 165	LAB. C105
24	EXAM 134	-	50	CORR 166	-
25	EXAM 135	EXAM 114	51	TELE. 143	-
26	EXAM 136	-	52	CORR 155	MIX C16

NOTE:  
CONTRACTOR TO SAVE UNUSED DOORS HARDWARE AND USE AS "STOCK" FOR REUSING RELOCATED DOORS AS NEEDED. SOME HARDWARE REUSING OR CHANGING MAY OCCUR TO ADDRESS EXISTING DOOR NEW LOCATION REQUIREMENT.


**NOTE:**

ALL CABINETS, MOST COUNTERTOPS, SINKS, FAUCETS, WATERCLOSETS, DOORS, FRAMES, HARDWARE TO BE SAVED AND REINSTALLED THROUGHOUT PROJECT. REFER TO DRAWINGS FOR LOCATION OF RE-INSTALLATION OF ITEMS.




**DEMOLITION FIRST FLOOR - EAST**

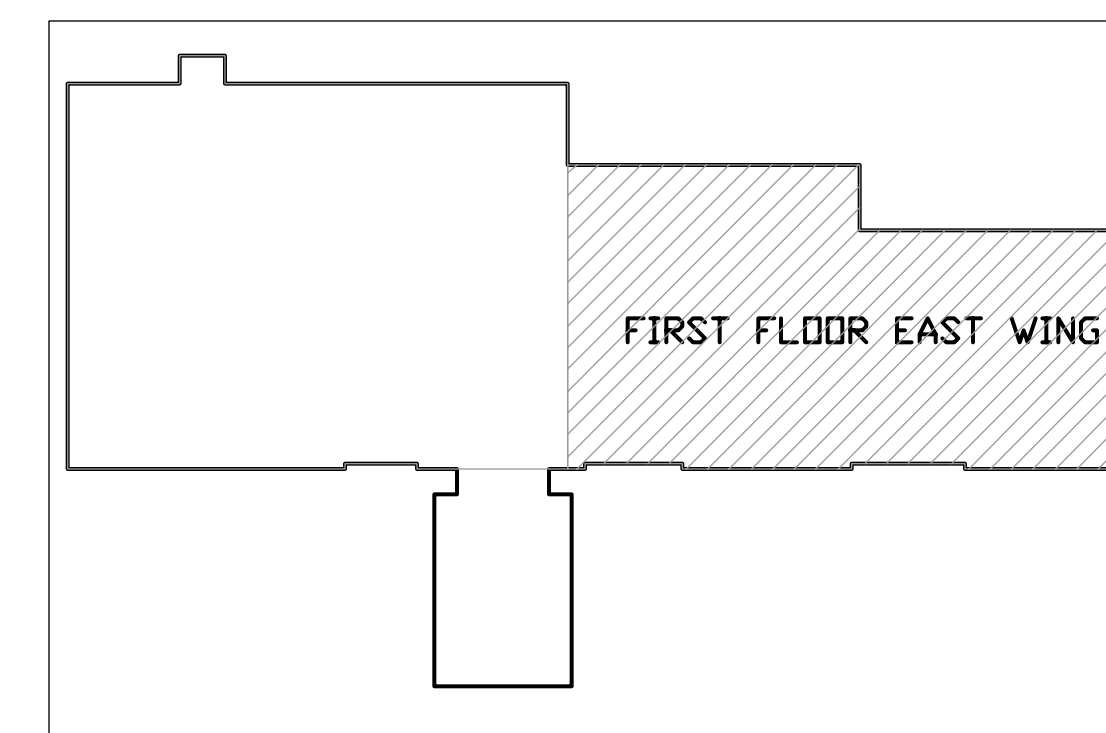SCALE: 1/8" = 1' - 0"



**KEY PLAN**

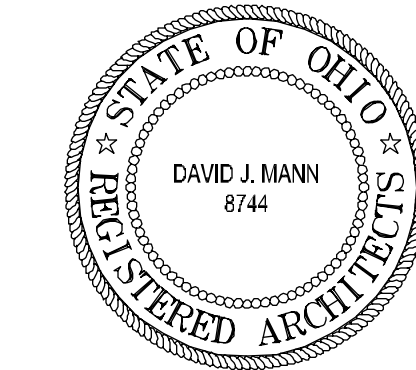N.T.S.




revisions
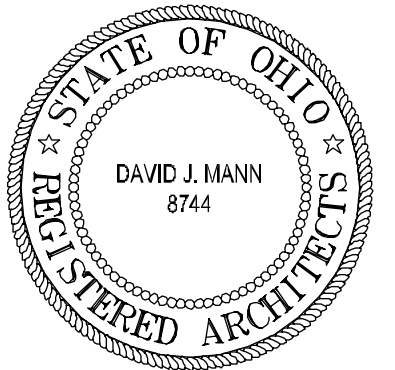
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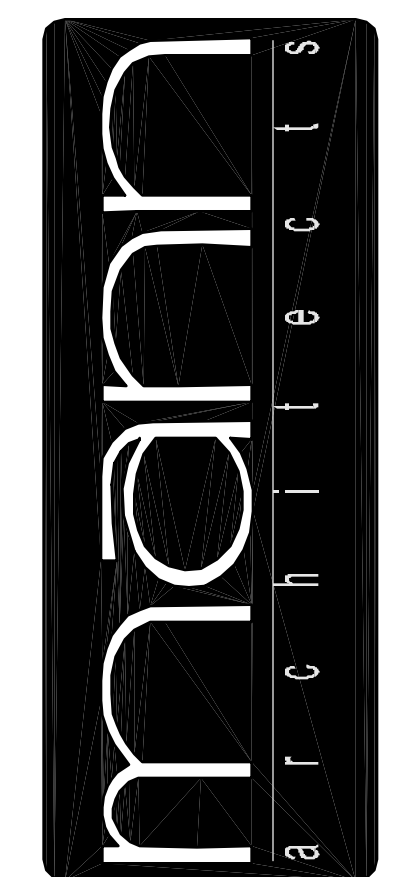
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DEMOLITION FIRST FLOOR - EAST  
project no. 11406  
date OCTOBER 23, 2001  
scale AS NOTED  
AS NOTED  
COLUMBUS ONCOLOGY  
JASONIAT PROFESSIONAL BUILDING  
810 JASONIAT AVENUE SUITE A  
COLUMBUS, OHIO 43214-2329  
project

**D.2**  
OF 3  
sheet no.



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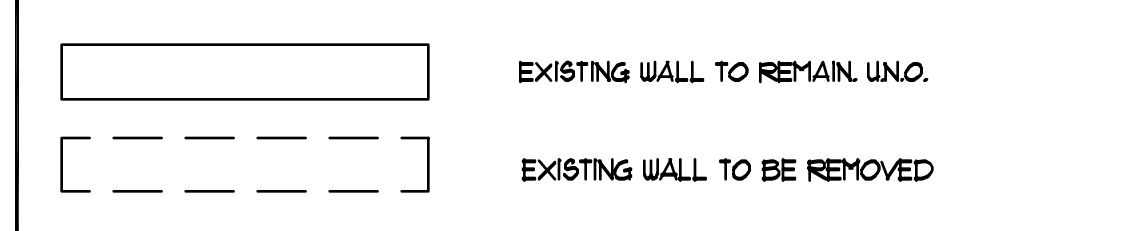
**GENERAL DEMOLITION NOTES:**

1. SOME NON-DEMO ITEMS MAY BE INDICATED ON THE DEMOLITION PLAN WHICH ARE INCLUDED TO DESCRIBE THE OVERALL SCOPE OF THE PROJECT AND TO AID IN THE CONTRACTOR'S COORDINATION. THE DEMOLITION CONTRACTOR IS RESPONSIBLE FOR ALL WORK REQUIRED TO COMPLETE THE INTENT OF THE CONTRACT DOCUMENTS.
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6. DEMOLITION CONTRACTOR SHALL BE RESPONSIBLE FOR OBTAINING ALL NECESSARY PERMITS AND FOLLOWING THE REQUIREMENTS FOR DEMOLITION WORK WITHIN THE GOVERNING MUNICIPALITY.

**DEMOLITION FLAG NOTES:**

- 1 EXISTING WALL TO BE REMOVED IN ITS ENTIRETY.
- 2 EXISTING DOORFRAME AND HARDWARE TO BE REMOVED.
- 3 EXISTING REFRIGERATOR/MICROWAVE TO BE RELOCATED.
- 4 REMOVE EXISTING KITCHEN MILLWORK, CABINETS, COUNTER FIXTURES. SALVAGE FOR REUSE - SEE SHT. A.6
- 5 EXISTING LAVS, COUNTER TOP, WATER CLOSET, MIRROR, ETC. TO BE REMOVED - SAVE FOR REUSE - SEE PLUMBING DUGS.
- 6 REMOVE EXISTING FLOORING FINISHES, ADHESIVES, BASE AND PATCH AS REQ'D. PREP FOR NEW FINISH FLOOR.
- 7 REMOVE EXISTING CEILING FINISHES, GRID AND ALL LIGHTING FIXTURES AS REQUIRED.
- 8 EXISTING COUNTERTOP AND BASE CABINETS TO BE REMOVED AND RELOCATED - SEE SHEET A.6.
- 9 EXISTING RESTROOMS TO REMAIN.
- 10 EXISTING CEILING AND LIGHT FIXTURES TO REMAIN.
- 11 EXISTING HEADER TO REMAIN.

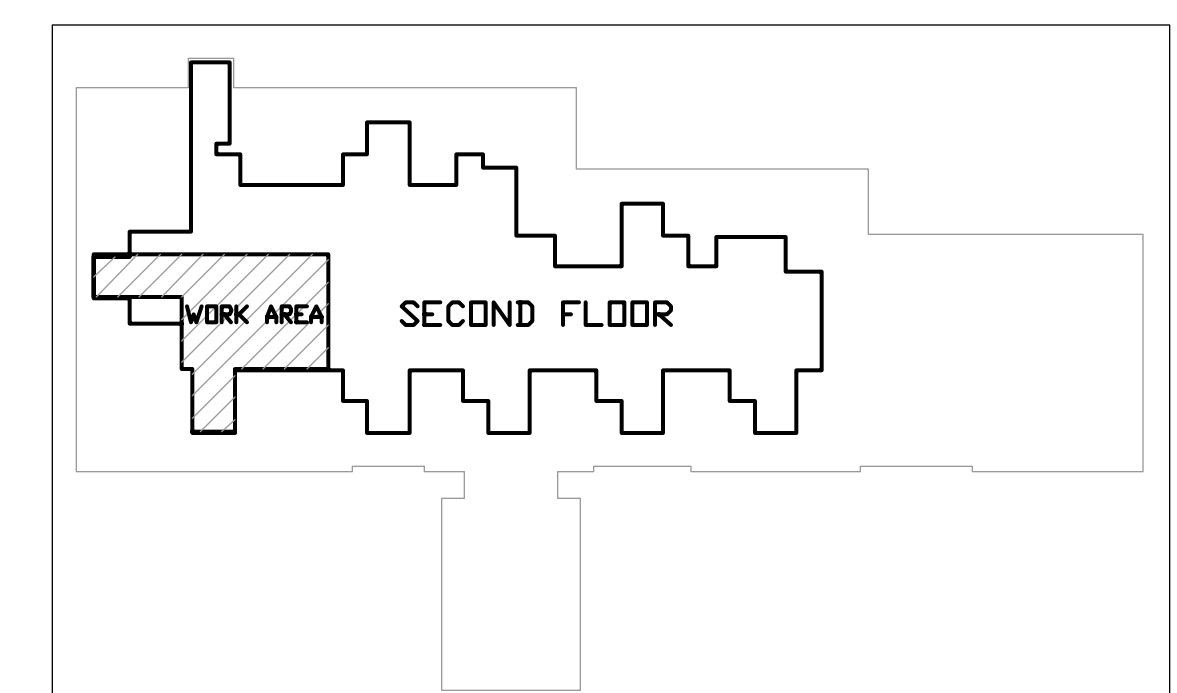
**WALL LEGEND**




**DOOR REUSE TABLE  
2ND FLOOR WEST WING (WU)**

EXISTING DOOR #	EXIST. ROOM NAME/NUMBER	NEW ROOM NAME/NUMBER
2	BILLING	SERVER 208

NOTE: CONTRACTOR TO SAVE UNUSED DOORS HARDWARE AND USE AS "STOCK" FOR REUSING RELOCATED DOORS AS NEEDED. SOME HARDWARE REUSING OR CHANGING MAY OCCUR TO ADDRESS EXISTING DOOR NEW LOCATION REQUIREMENT.



**KEY PLAN**  
NT.S

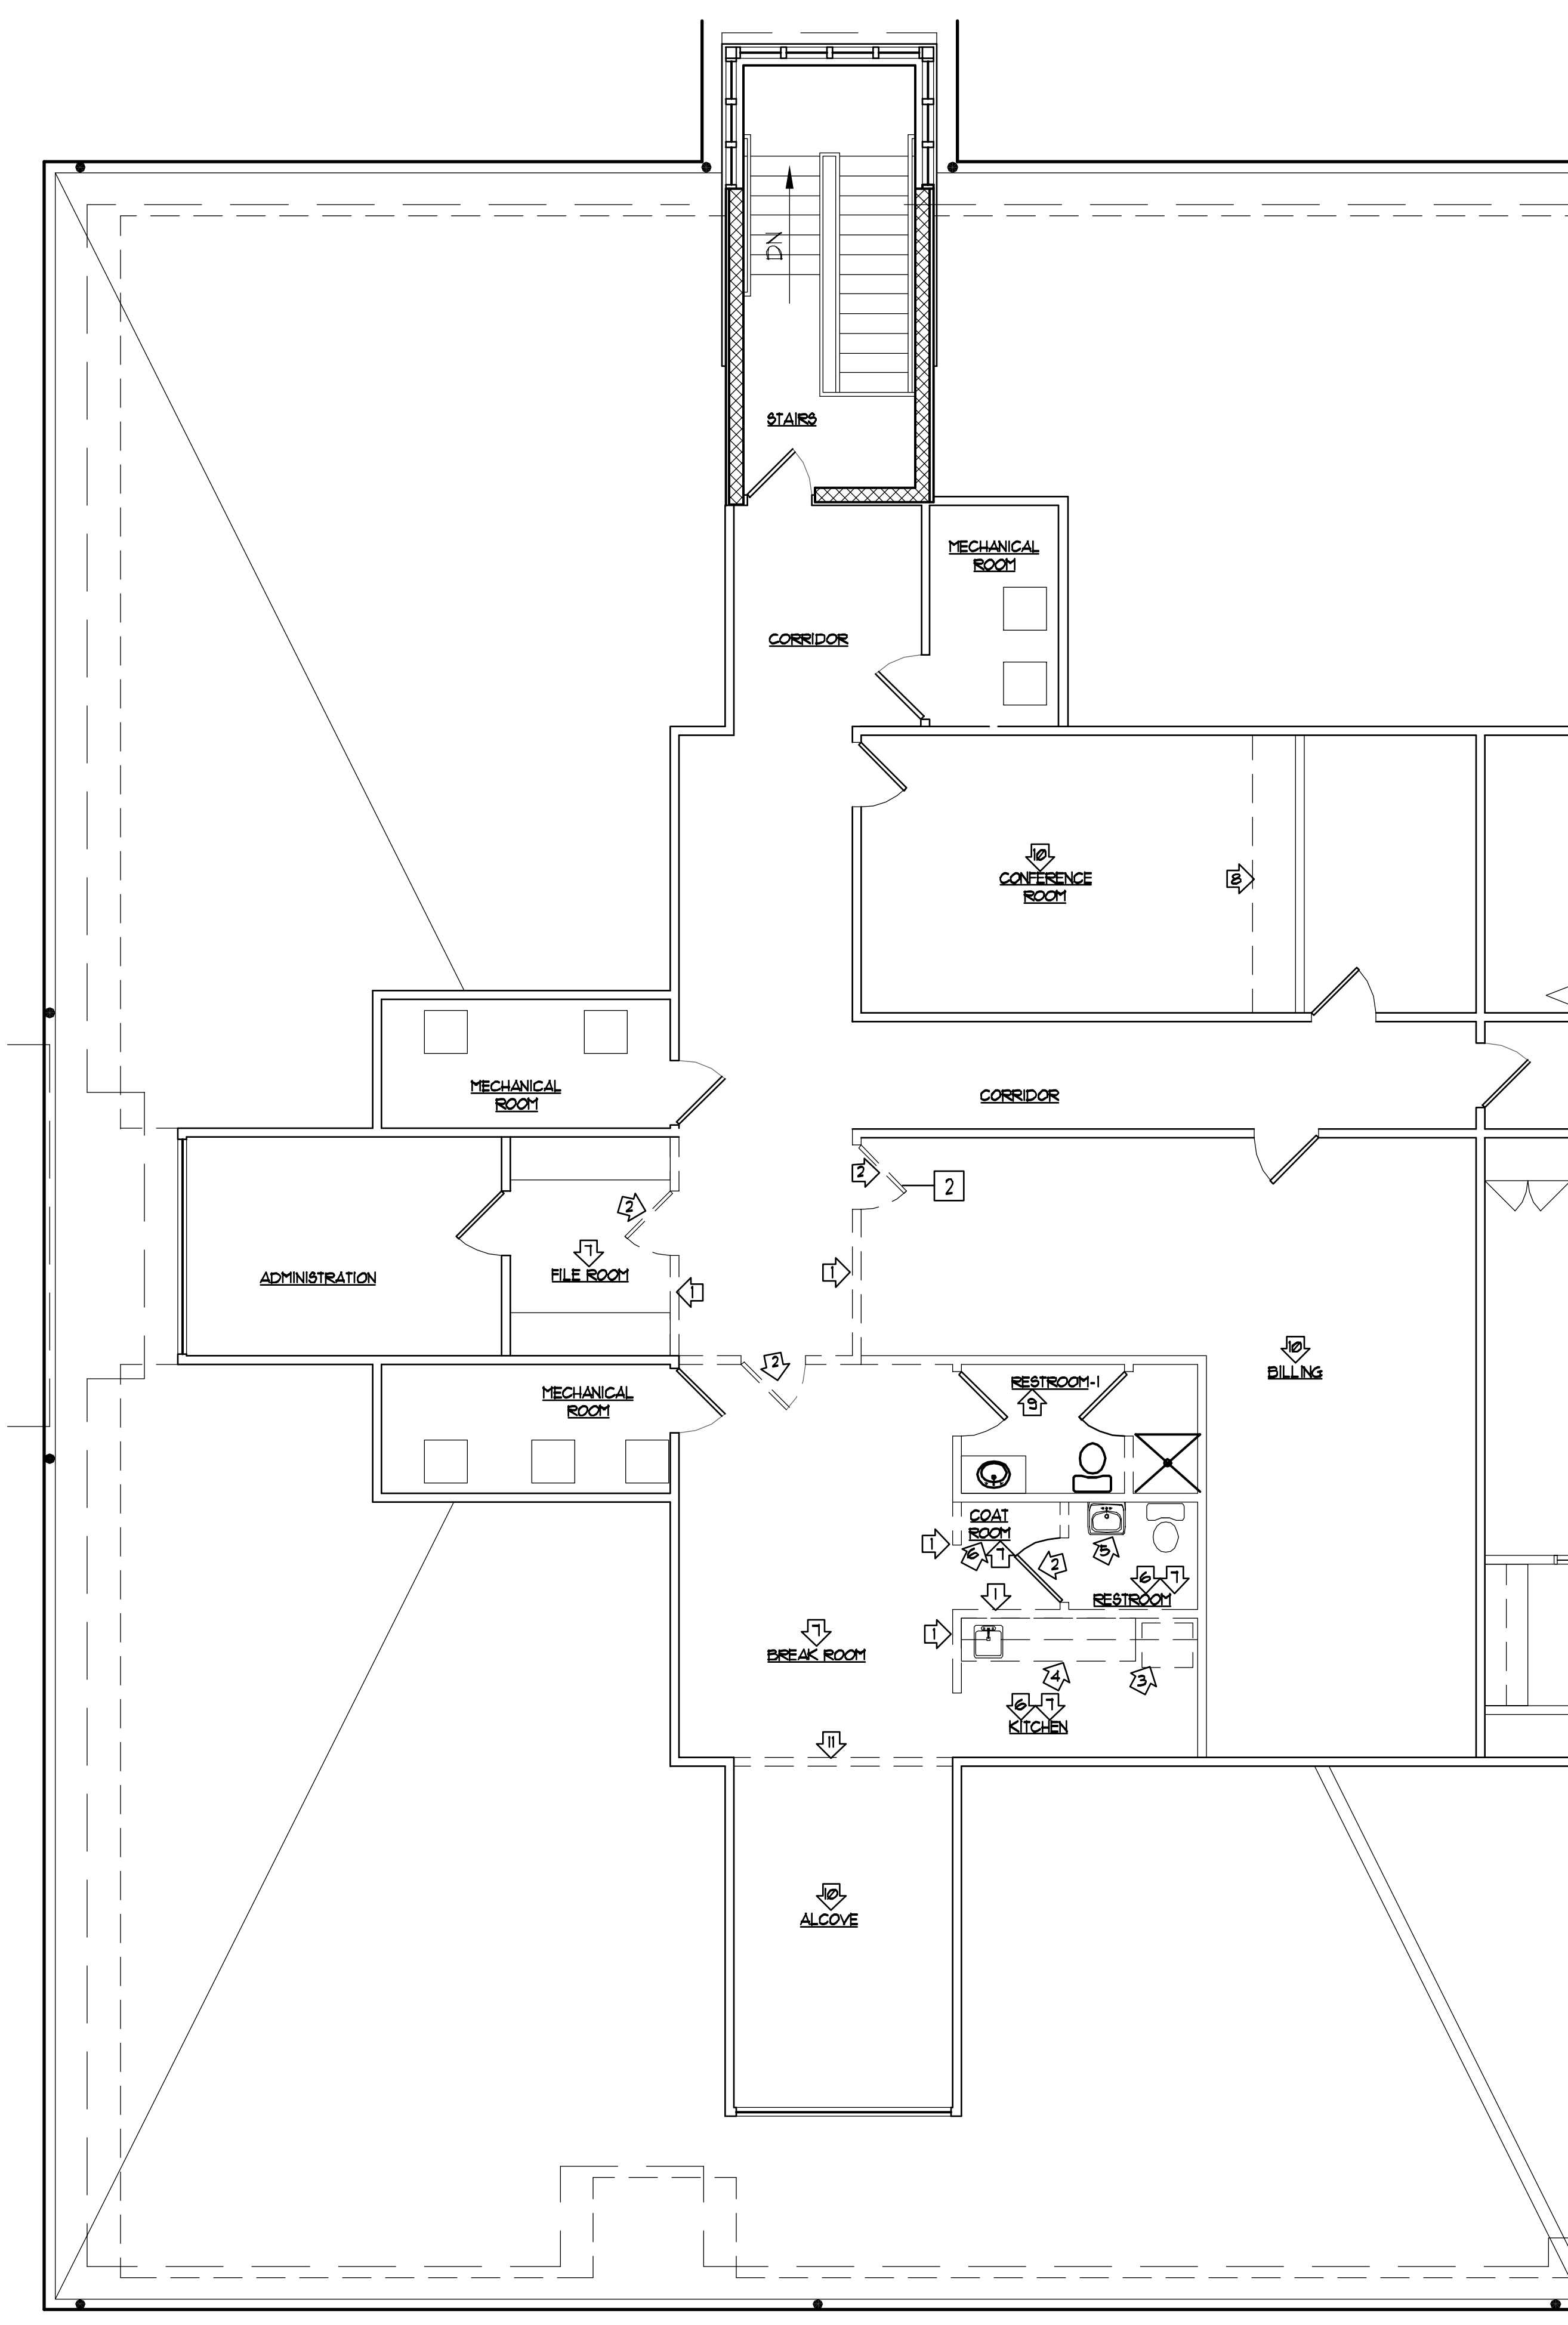






**DEMOLITION PARTIAL 2ND FLOOR**  
SCALE: 3/16" = 1' - 0"

**NOTE:**  
ALL DOORS, FRAME, HARDWARE, SINKS, FAUCETS, WATERCLOSETS TO BE SAVED AND REINSTALLED THROUGHOUT PROJECT. REFER TO DRAWINGS FOR LOCATION OF RE-INSTALLATION OF ITEMS.


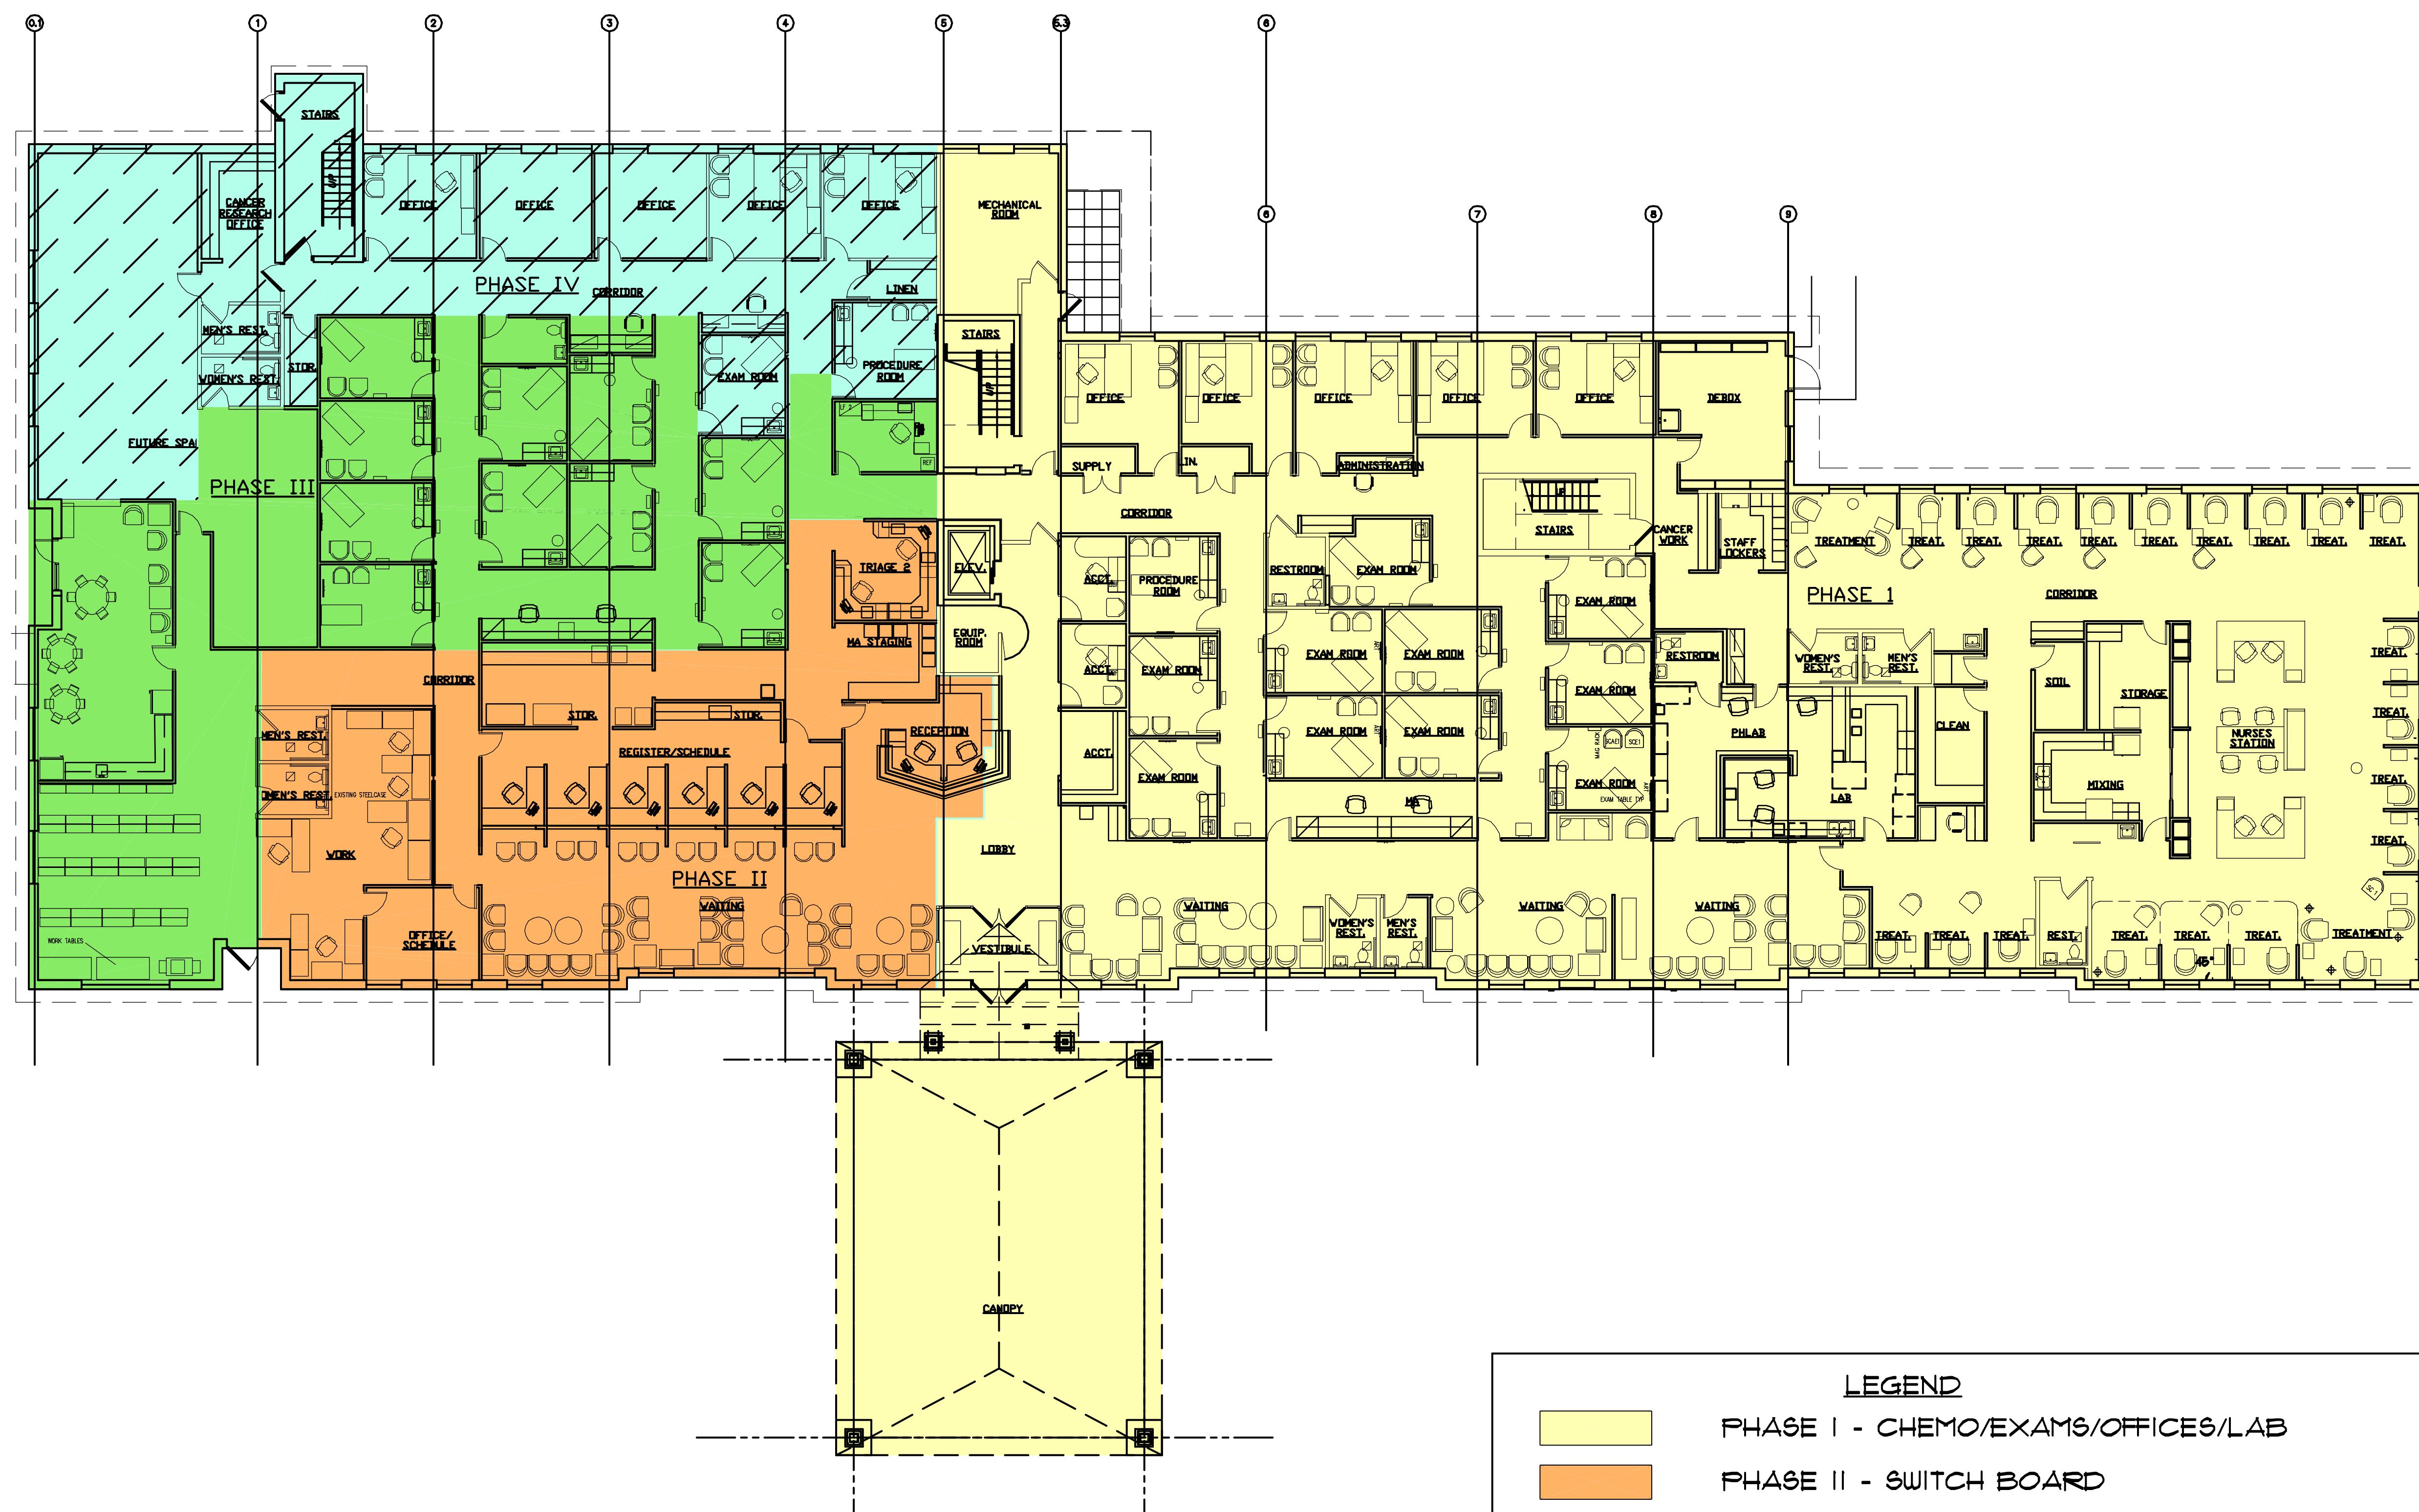
drawing  
**DEMOLITION PARTIAL 2ND FLOOR** scale  
 project no. 11406 date **OCTOBER 23, 2007** AS NOTED  
**COLUMBUS ONCOLOGY**  
 JASONIWAY PROFESSIONAL BUILDING  
 810 JASONIWAY AVENUE SUITE A  
 COLUMBUS, OHIO 43214-2329 project

**D.3**  
 OF 3  
 sheet no.


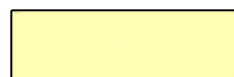


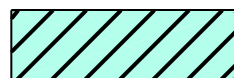LEGEND	
	PHASE I - CHEMO/EXAMS/OFFICES/LAB
	PHASE II - SWITCH BOARD
	PHASE III - RECEPTION/MA STAGING/TRIAGE
	PHASE IV - EXAMS/OFFICES/MEDICAL RECORDS

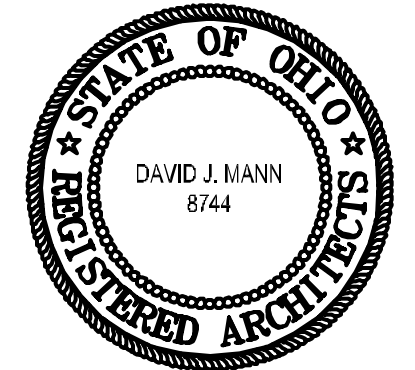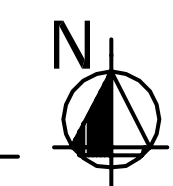
OVERALL FIRST FLOOR PHASING PLAN  
 SCALE: 3/32" = 1' - 0"



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OVERALL FIRST FLOOR PHASING PLAN  
 project no. 114-06  
 date: OCTOBER 23, 2007  
 scale: AS NOTED  
 AS NOTED  
**COLUMBUS ONCOLOGY**  
 JASONIJAY PROFESSIONAL BUILDING  
 810 JASONIJAY AVENUE, SUITE A  
 COLUMBUS, OHIO 43214-2329

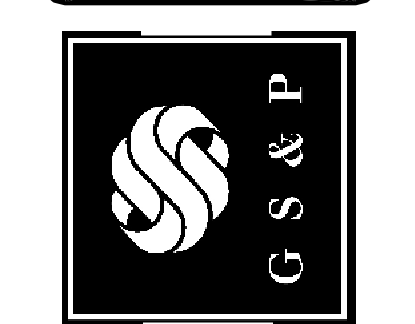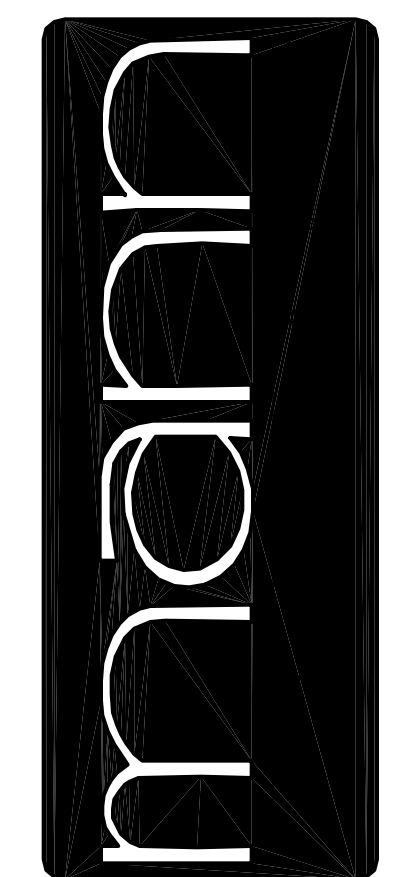

sheet no.

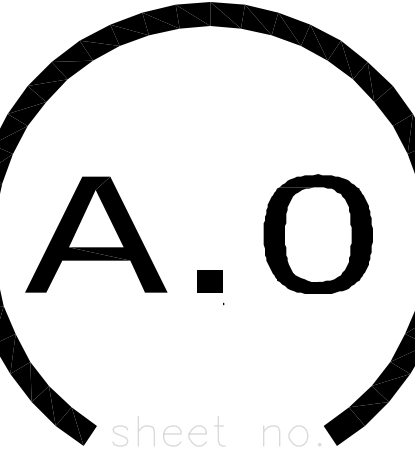**EXCAVATION NOTES**

**EXCAVATION**  
CONSISTS OF REMOVAL AND DISPOSAL OF ALL MATERIALS ENCOUNTERED TO OBTAIN REQUIRED SUBGRADE ELEVATIONS.

UNAUTHORIZED EXCAVATION CONSISTS OF REMOVAL OF MATERIALS BEYOND INDICATED SUBGRADE ELEVATIONS OR SIDE DIMENSIONS WITHOUT SPECIFIC DIRECTION OF THE OWNER. REPLACE UNAUTHORIZED EXCAVATION AS DIRECTED BY ARCHITECT.

**STABILITY OF SIDES:** PROVIDE MINIMUM REQUIREMENTS FOR TRENCH SHORING AND BRACING TO COMPLY WITH ANS A10.2 'SAFETY CODE FOR BUILDING CONSTRUCTION' AND WITH LOCAL CODES AND AUTHORITIES HAVING JURISDICTION.

**DEWATERING:** PERFORM EXCAVATION IN MANNER TO PREVENT SURFACE WATER AND SUBSURFACE OF GROUND WATER FROM FLOWING INTO EXCAVATIONS, AND TO PREVENT WATER FROM FLOODING PROJECT SITE AND SURROUNDING AREA.

DO NOT ALLOW WATER TO ACCUMULATE IN EXCAVATIONS. REMOVE WATER FROM EXCAVATIONS USING DEWATERING METHODS WHICH WILL PREVENT SOFTENING OF FOUNDATION BOTTOMS, UNDERCUTTING FOOTINGS, AND SOIL CHANGES DETRIMENTAL TO STABILITY OF SUBGRADES AND FOUNDATIONS. PROVIDE AND MAINTAIN PUMPS, SUMPS, SUCTION AND DISCHARGE LINES, AND ANY OTHER DEWATERING SYSTEM COMPONENTS NECESSARY TO CONVEY WATER AWAY FROM EXCAVATIONS.

IN EXCAVATION FOR FOOTINGS AND FOUNDATIONS, TAKE CARE NOT TO DISTURB BOTTOM OF EXCAVATION. EXCAVATE BY HAND TO FINAL GRADE JUST BEFORE CONCRETE IS PLACED. TRIM BOTTOMS TO REQUIRED LINES AND GRADES TO LEAVE A SOLID BASE TO RECEIVE CONCRETE.

**BACKFILL AND FILL**  
BACKFILL AND FILL MATERIALS: PROVIDE SATISFACTORY SOIL MATERIALS FOR BACKFILL AND FILL, FREE OF CLAY, ROCK AND GRAVEL LARGER THAN 2" IN ANY DIMENSION, DEBRIS, WASTE, FROZEN MATERIALS, VEGETABLE MATTER, AND OTHER DELETERIOUS MATTER.

**GRADING**  
UNIFORMLY GRADE ALL AREAS. SMOOTH FINISHED SURFACE WITHIN SPECIFIED TOLERANCES. COMPACT AND WITH UNIFORM LEVELS OR SLOPES BETWEEN POINTS WHERE ELEVATIONS ARE SHOWN, OR BETWEEN SUCH POINTS AND EXISTING GRADES.

GRADE SURFACE OF FILL UNDER CONCRETE SLABS SMOOTH AND EVEN, FREE OF VOIDS, COMPACTED AS SPECIFIED, TO REQUIRED ELEVATIONS.

AFTER GRADING, COMPACT SURFACES.

**GENERAL NOTES!!**

1. REBAR STEEL TO BE PROVIDED BY CONTRACTOR. USE GRADE 60 A.S.T.M. - A615. BEND BARS MIN. 2'-0" AROUND ALL CORNERS. ALL BARS TO BE CONTINUOUS AND SECURELY WIRED. ALL BAR LAP JOINTS TO BE 12" FOR 1/2" BARS, AND 15" FOR 3/8" BARS.
2. BOLTS AND TEMPLATES FURNISHED AND INSTALLED BY CONTRACTOR.
3. EXISTING CANOPY INCLUDING STL. COLUMNS, FASCIA, SOFFIT, LIGHTS, ETC. TO BE DISASSEMBLED AS REQUIRED TO ALLOW FOR NEW CANOPY CONSTRUCTION.
4. THE CONTRACTOR IS RESPONSIBLE FOR THE INSTALLATION OF ANY AND ALL TEMPORARY FENCING, BARRICADES, WARNING LIGHTS, SIGNAGE, ETC. IN ORDER TO INSURE THE SAFETY OF THE PUBLIC, VEHICLES AND WORKERS.
5. THE CONTRACTOR SHALL SECURE ALL NECESSARY PERMITS AND CALL FOR ALL REQUIRED INSPECTIONS FOR THIS WORK.
6. THE INTENT OF THIS DRAWING SHEET PREPARED BY REINBOLT, EVANS, AND MANN INC. ARCHITECTS IS TO INDICATE THE FOUNDATION SYSTEM FOR THE RELOCATION OF AN EXISTING CANOPY AT THIS SITE.

**NOTE (DISCLAIMER)**

THE OWNER (CLARK OIL) HAS REQUESTED THAT THE DOWN SPOUTS FOR THE RELOCATED CANOPY SHALL SPILL ONTO THE PAVEMENT. IT IS THE ARCHITECTS OPINION THAT THIS MAY PROVIDE AN UNNATURAL ACCUMULATION OF WATER AND ICE. THE ARCHITECT SHALL BE HELD HARMLESS FROM ANY CLAIM ASSOCIATED WITH THE OWNERS REQUEST.

**CONCRETE & FOUNDATION NOTES**

ALL CONCRETE FOR FOUNDATIONS SHALL HAVE A MINIMUM COMPRESSIVE STRENGTH OF 3,500 PSI AT 28 DAYS.

ALL STRUCTURAL SLABS AND SLABS ON GRADE SHALL HAVE A MINIMUM COMPRESSIVE STRENGTH OF 4,000 PSI AT 28 DAYS.


MAXIMUM DESIGN SOIL PRESSURE SHALL BE 2,000 PSF. TOP OF ALL EXTERIOR FOOTINGS TO BE MINIMUM 2'-8" BELOW FINISH FLOOR. BOTTOM OF ALL FOOTINGS TO BE MINIMUM 3'-6" BELOW FINISH GRADE. ALL FOOTINGS TO BEAR ON UNDISTURBED SOIL. TWO BARS SHALL BE PLACED CONTINUOUS IN BOTTOM OF ALL FOOTINGS UNLESS INDICATED OTHERWISE ON DRAWINGS. SEE FOUNDATION PLAN AND TYPICAL WALL SECTIONS FOR BAR SIZES AND PLACEMENT. OWNER / CONTRACTOR SHALL BE RESPONSIBLE FOR THE INVESTIGATION AND VERIFICATION OF SOIL BEARING CONDITIONS AND CAPACITIES PRIOR TO THE PLACEMENT OF FOOTINGS. NOTIFY ARCHITECT OF ANY ADVERSE CONDITIONS.

WHERE FOOTINGS CHANGE ELEVATION, STEP FOOTINGS AT A RATE OF TWO HORIZONTAL TO ONE VERTICAL.


FOOTING ELEVATIONS SHOWN ON DRAWINGS ARE TO TOP OF FOOTING UNLESS OTHERWISE NOTED.

ALL REINFORCING BARS ARE TO BE DEFORMED TYPE, 60 KSI GRADE STEEL.


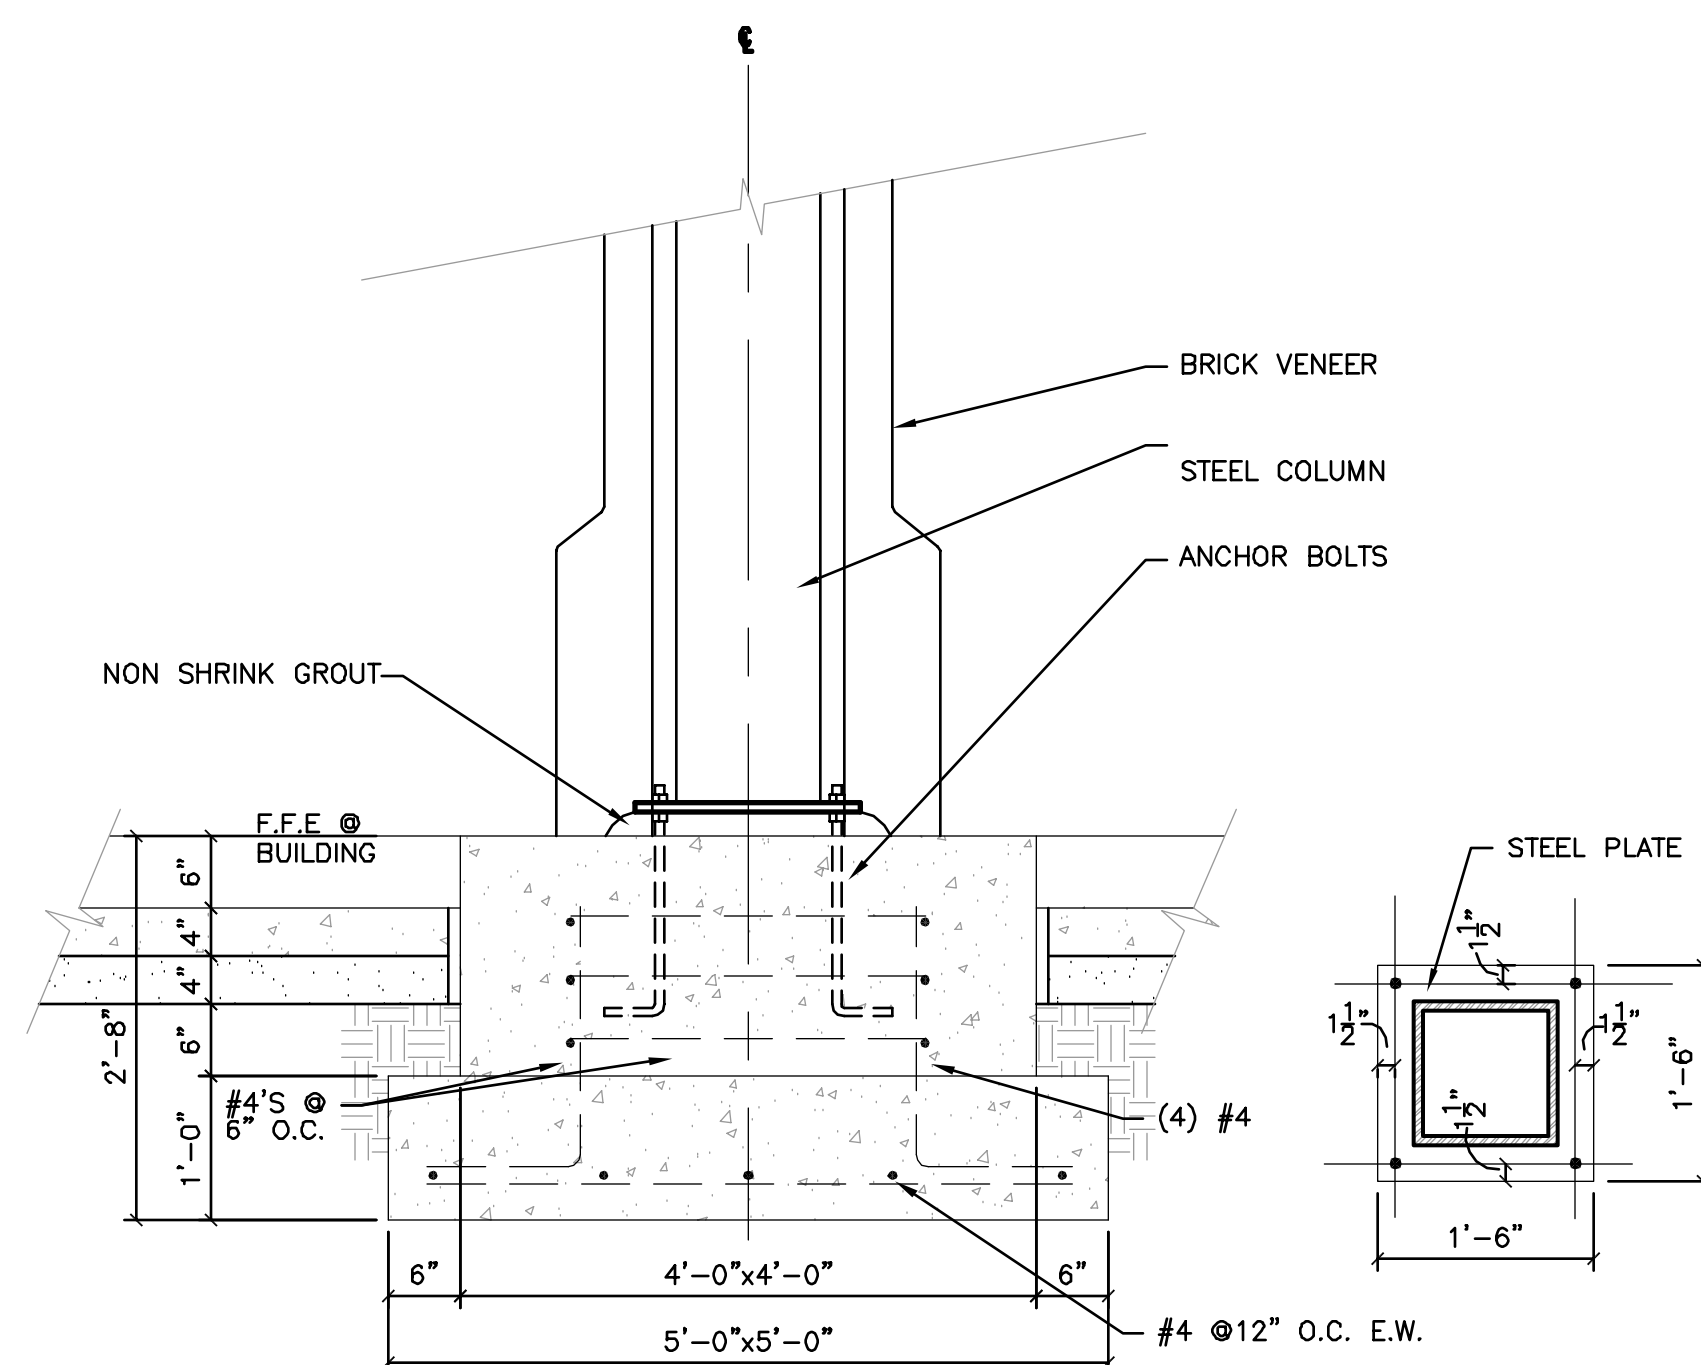
ALL DETAILING, FABRICATION AND ERECTION OF REINFORCING BARS SHALL CONFORM WITH ACI MANUAL OF STANDARD PRACTICE FOR DETAILING REINFORCED CONCRETE STRUCTURES (ACI 318-95).



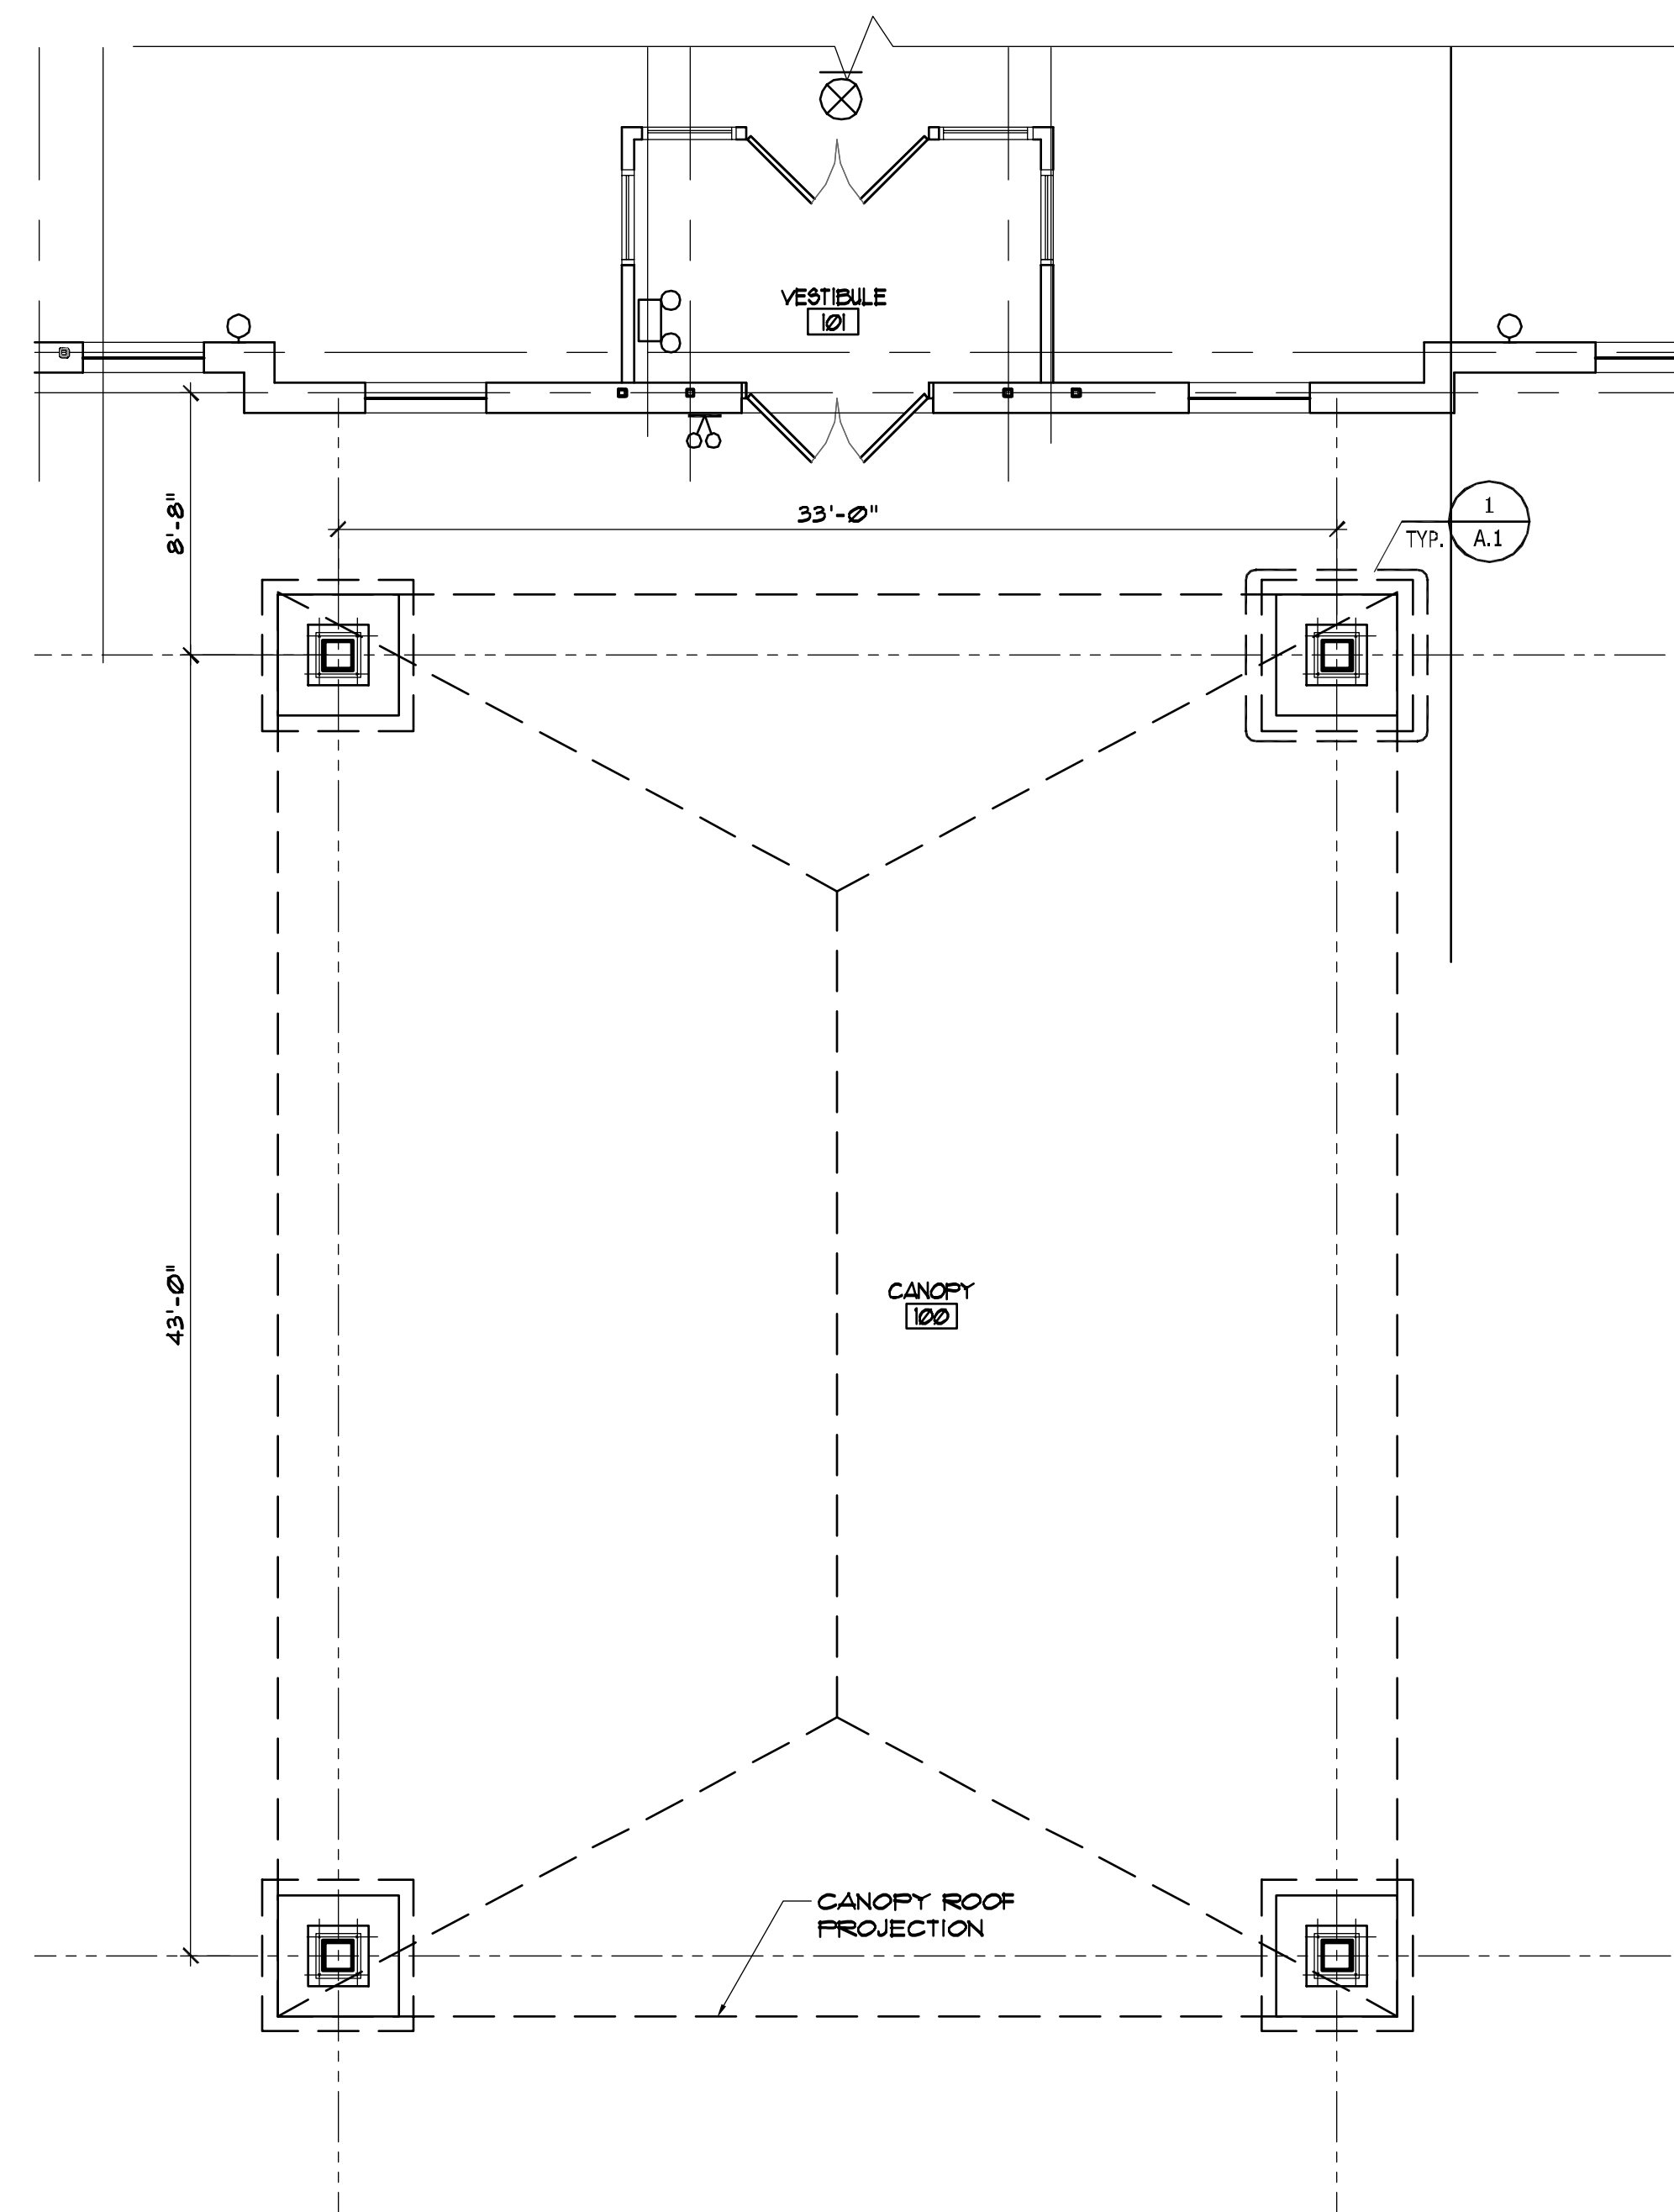1 TYP. FOUNDATION AT COLUMNS  
SCALE: 3/4" = 1'-0"




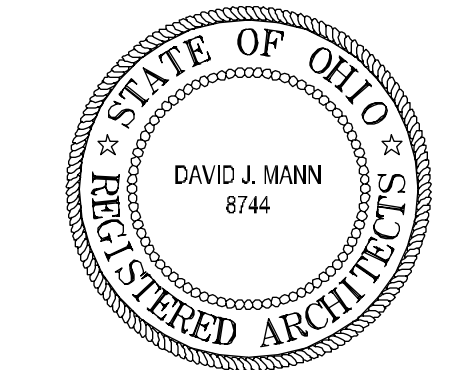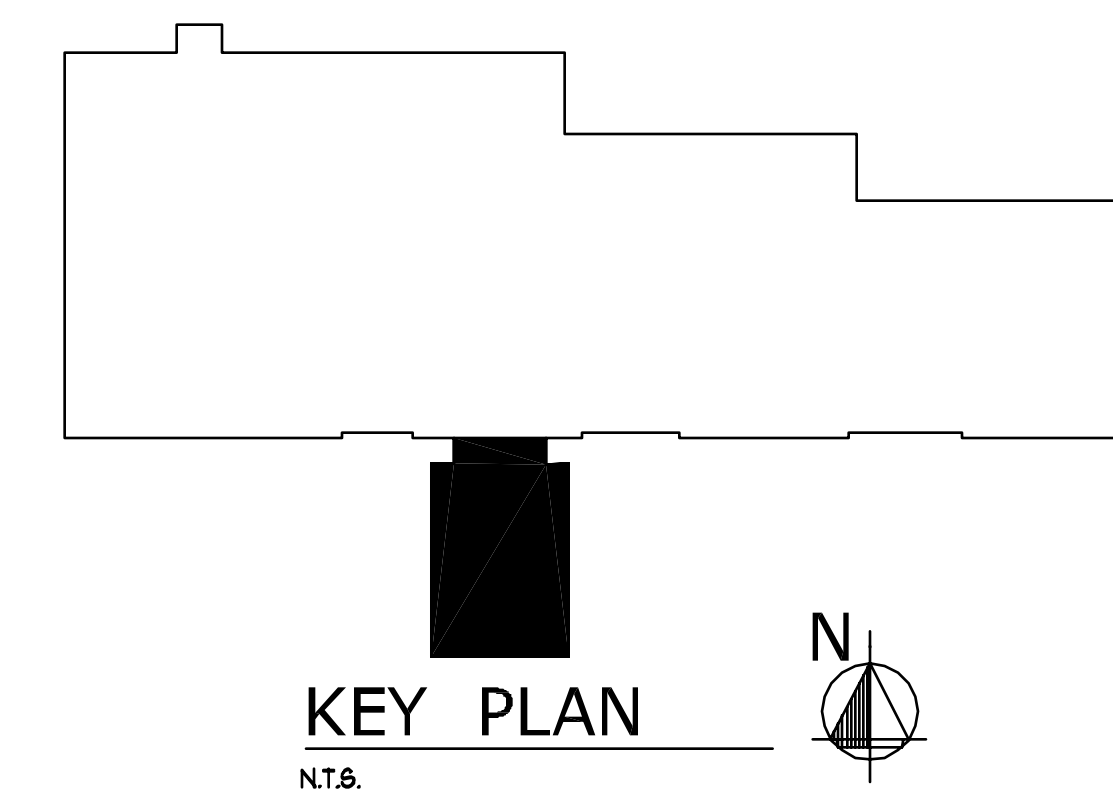CANOPY FOUNDATION PLAN  
SCALE: 3/16" = 1'-0"




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drawing  
CANOPY FOUND PLAN  
project no. 11406  
date OCTOBER 23, 2001  
scale AS NOTED  
AS NOTED  
COLUMBUS ONCOLOGY  
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810 JASONIWAY AVENUE SUITE A  
COLUMBUS, OHIO 43214-2329  
project

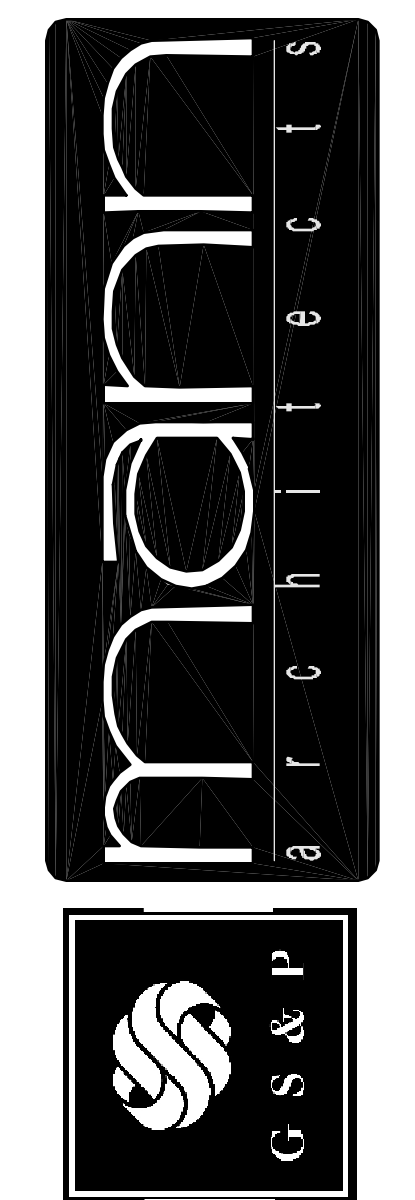A.1  
OF 18  
sheet no.



**NOTES**

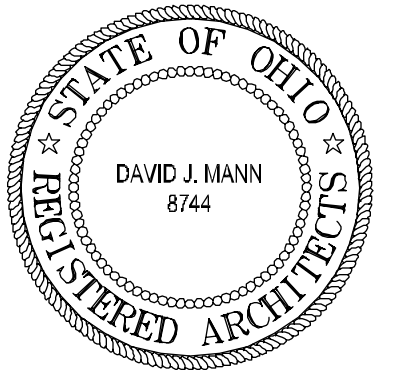FE REFER TO FIRE EXTINGUISHER CABINET LOCATIONS ON PLAN. LARSEN'S MODEL C2409-R RECEBERED CABINET WITH CLEAR BUBBLE DOOR, METAL FRAME WHITE, WITH MP10, 10 LB. EXTINGUISHER.


\* DENOTES EXISTING EXITS (7) TOTAL FROM EXISTING BUILDING.

**FLAG NOTES**

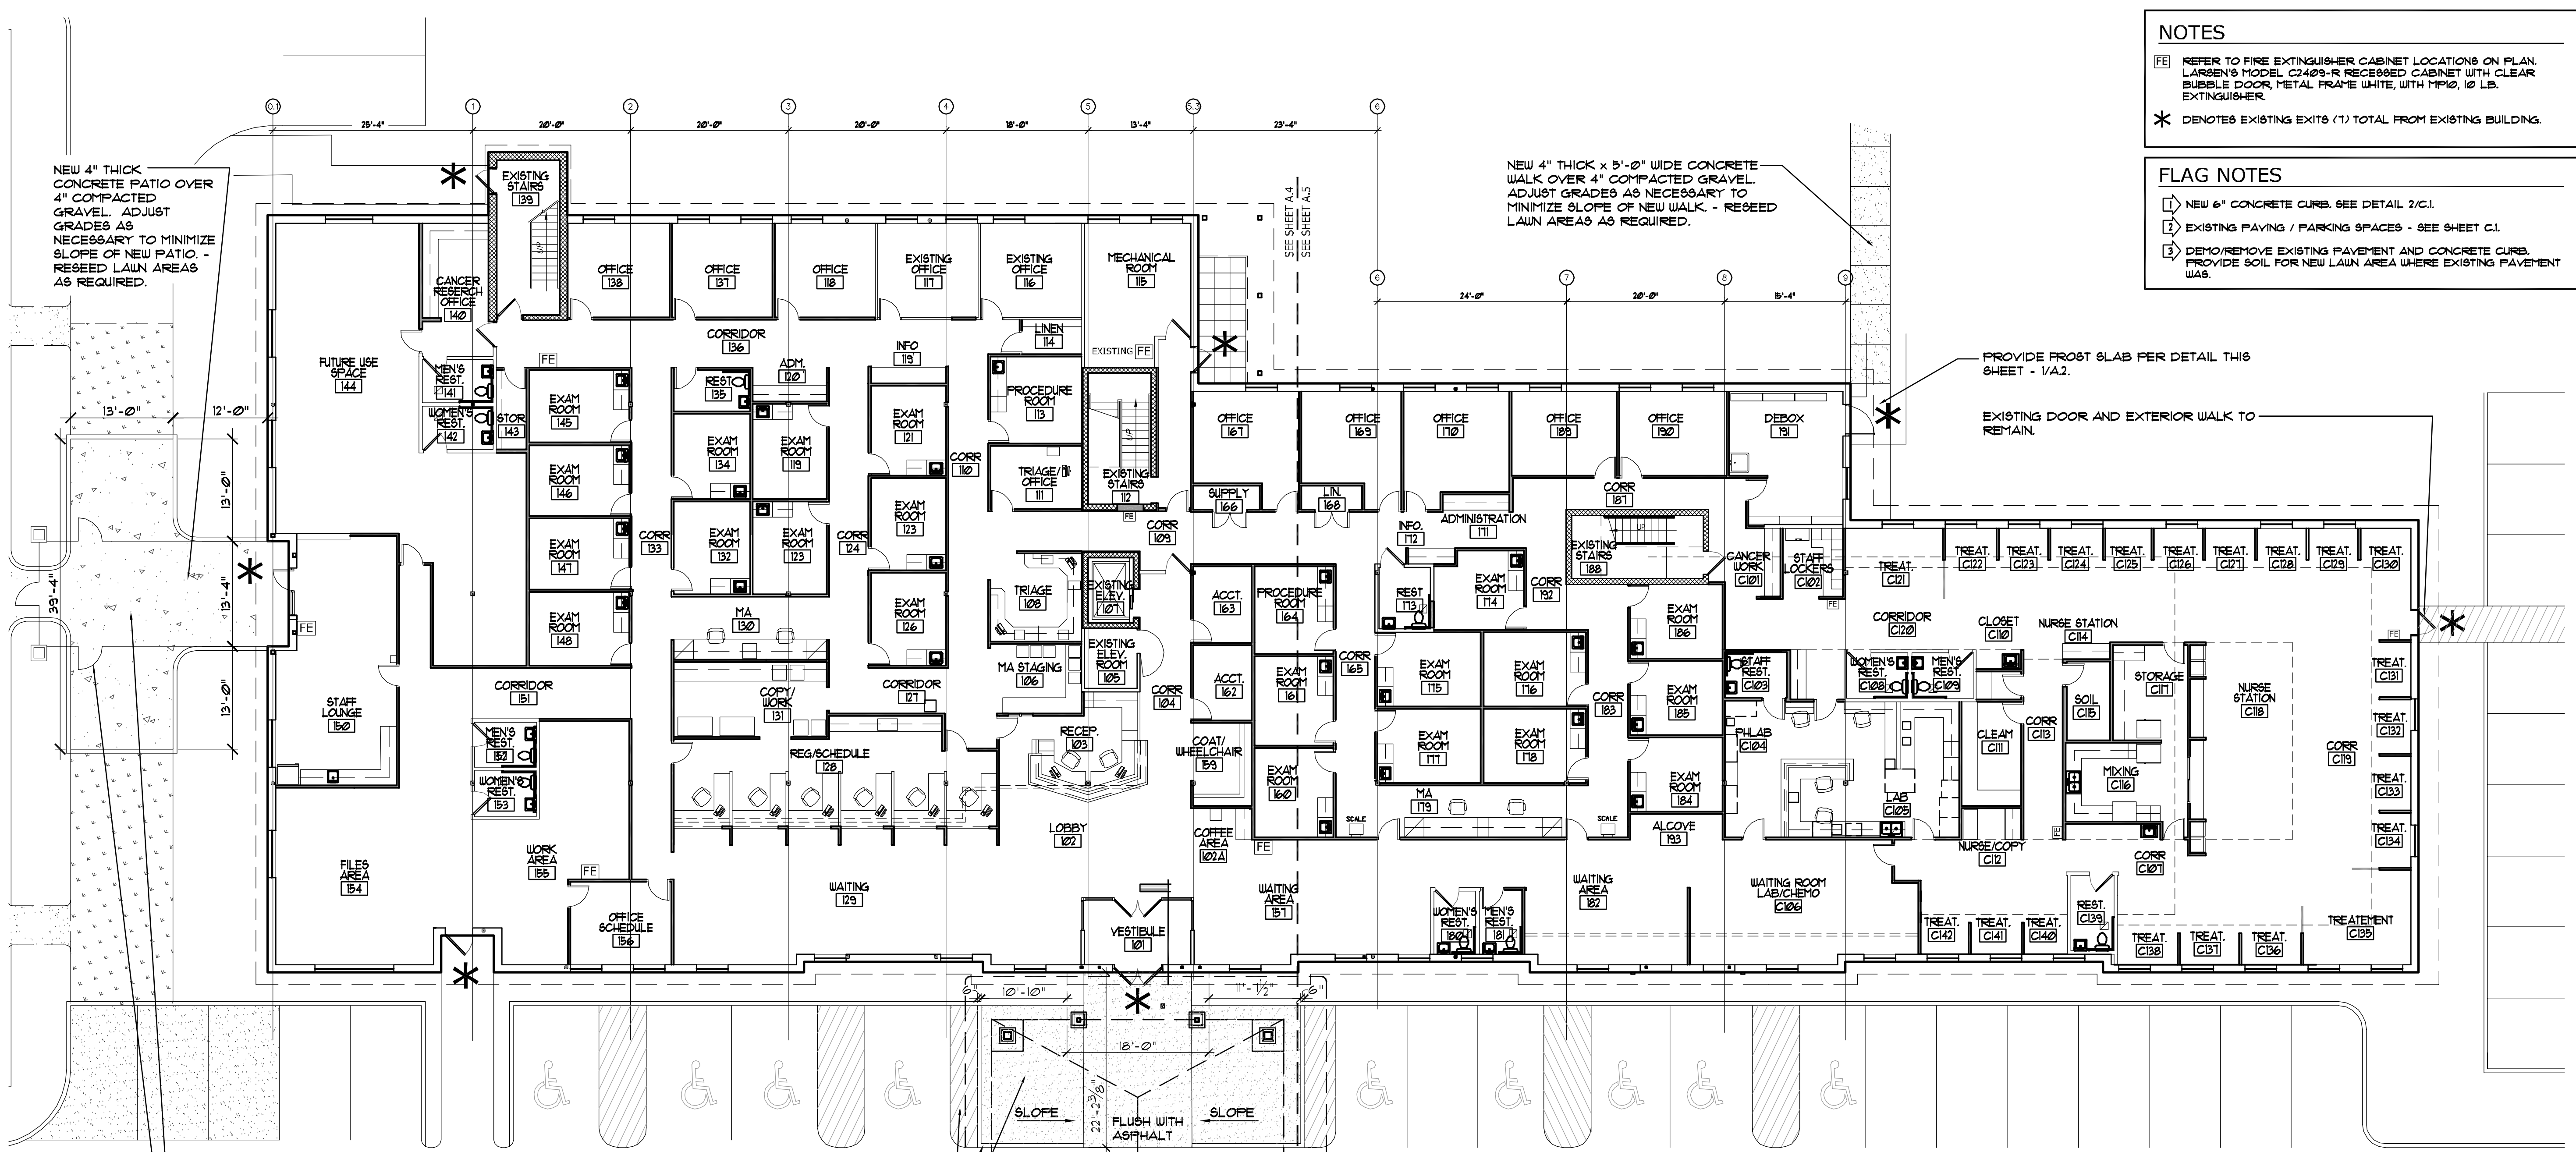1 NEW 6" CONCRETE CURB. SEE DETAIL 2/C.1.


2 EXISTING PAVING / PARKING SPACES - SEE SHEET C.1.

3 DEMO/REMOVE EXISTING PAVEMENT AND CONCRETE CURB. PROVIDE SOIL FOR NEW LAWN AREA WHERE EXISTING PAVEMENT WAS.



**FIRST FLOOR PLAN / LIFE SAFETY PLAN**

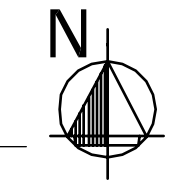SCALE: 3/32" = 1' - 0"





EXISTING CANVAS CANOPY & LINING FRAMEWORK TO BE REMOVED. NEW PRE-ENGINEERED WOOD ROOF TRUSSES WITH 3/4" EXTERIOR GRADE O.S.B. OR 4-PLY PLYWOOD. ADD 30 LB. FELT AND DIMENSIONAL ROOF SHINGLES ON TOP. MATCH EXISTING ROOF COLOR.

NEW 4'-2 1/2' FT ALUM. POOL FENCE WITH VERTICAL PICKETS AND SUPPORT POSTS AS REQ'D. COLOR SELECTION BY OWNER.

STRIPING WITHIN ASPHALT, COORDINATE WITH CIVIL DRAWINGS, BOTH SIDES.

6" HIGH CONCRETE CURB, PAINT FACE CAUTION YELLOW. GRADATE DOWN TO FLUSH WITH ASPHALT AT CENTER OF WALK.

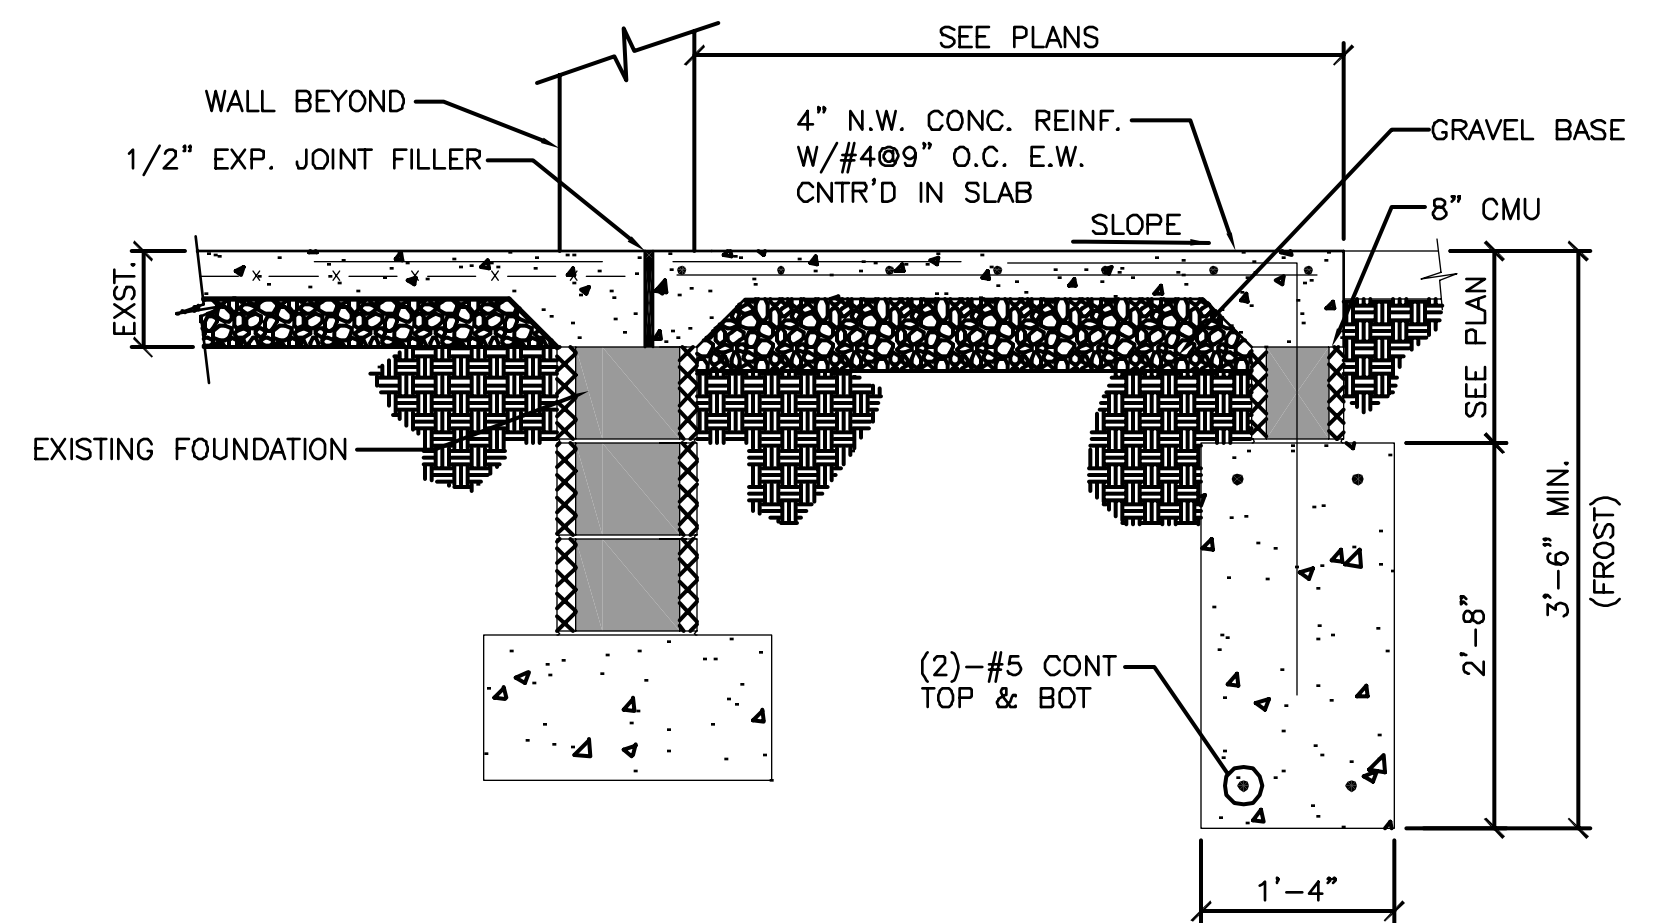
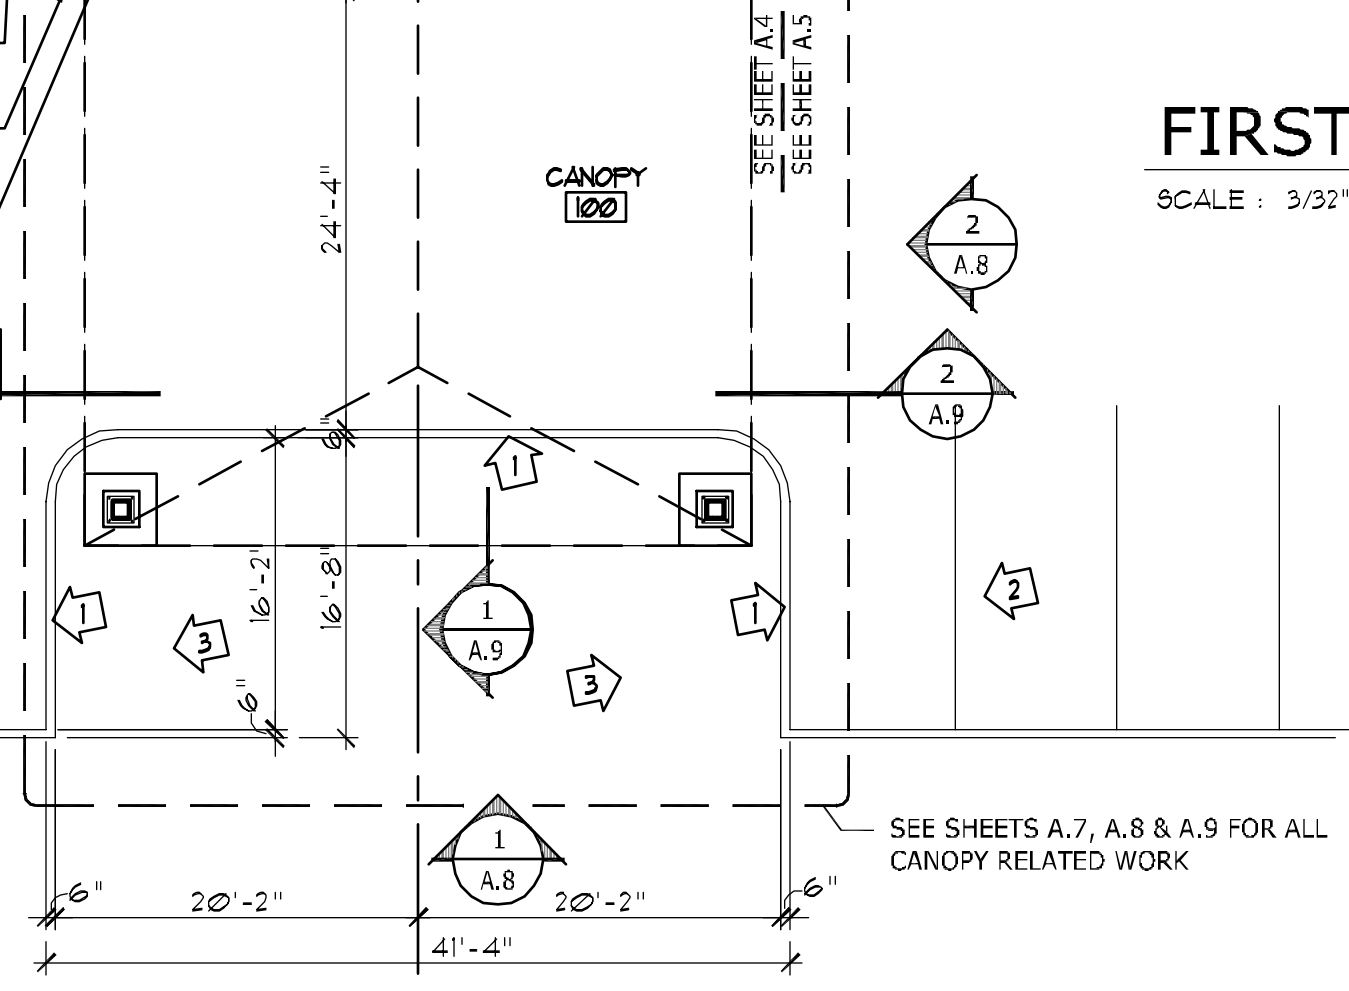
NEW 4" THICK CONCRETE WALK OVER 4" COMPACTED GRAVEL. ADJUST GRADES AS NECESSARY TO MINIMIZE SLOPE OF NEW WALK. RESEED LAWN AREAS AS REQUIRED.



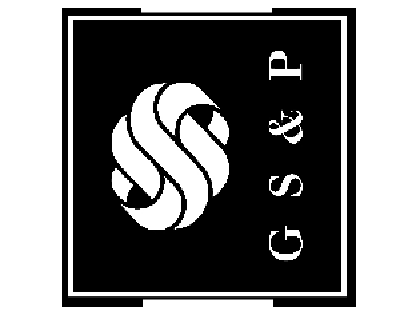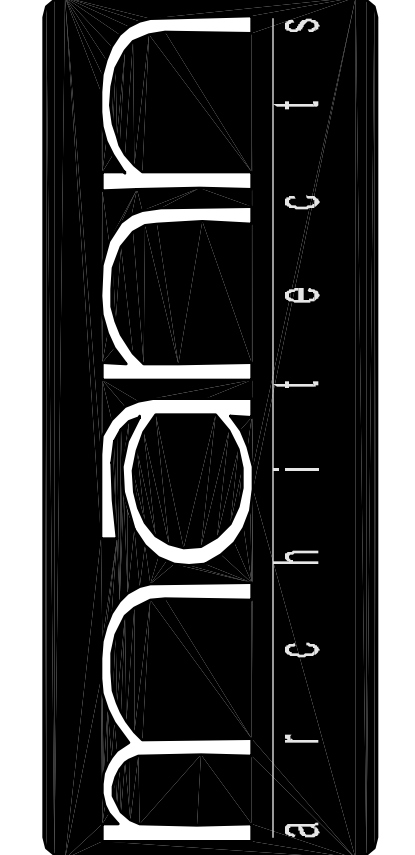1 FROST SLAB DETAIL  
A.2 SCALE: 3/4" = 1' - 0"

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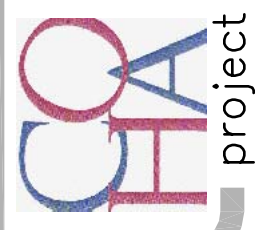


drawing  
FIRST FLOOR / LIFE SAFETY PLAN

project no. 11406  
date OCTOBER 23, 2007  
AS NOTED

COLUMBUS ONCOLOGY

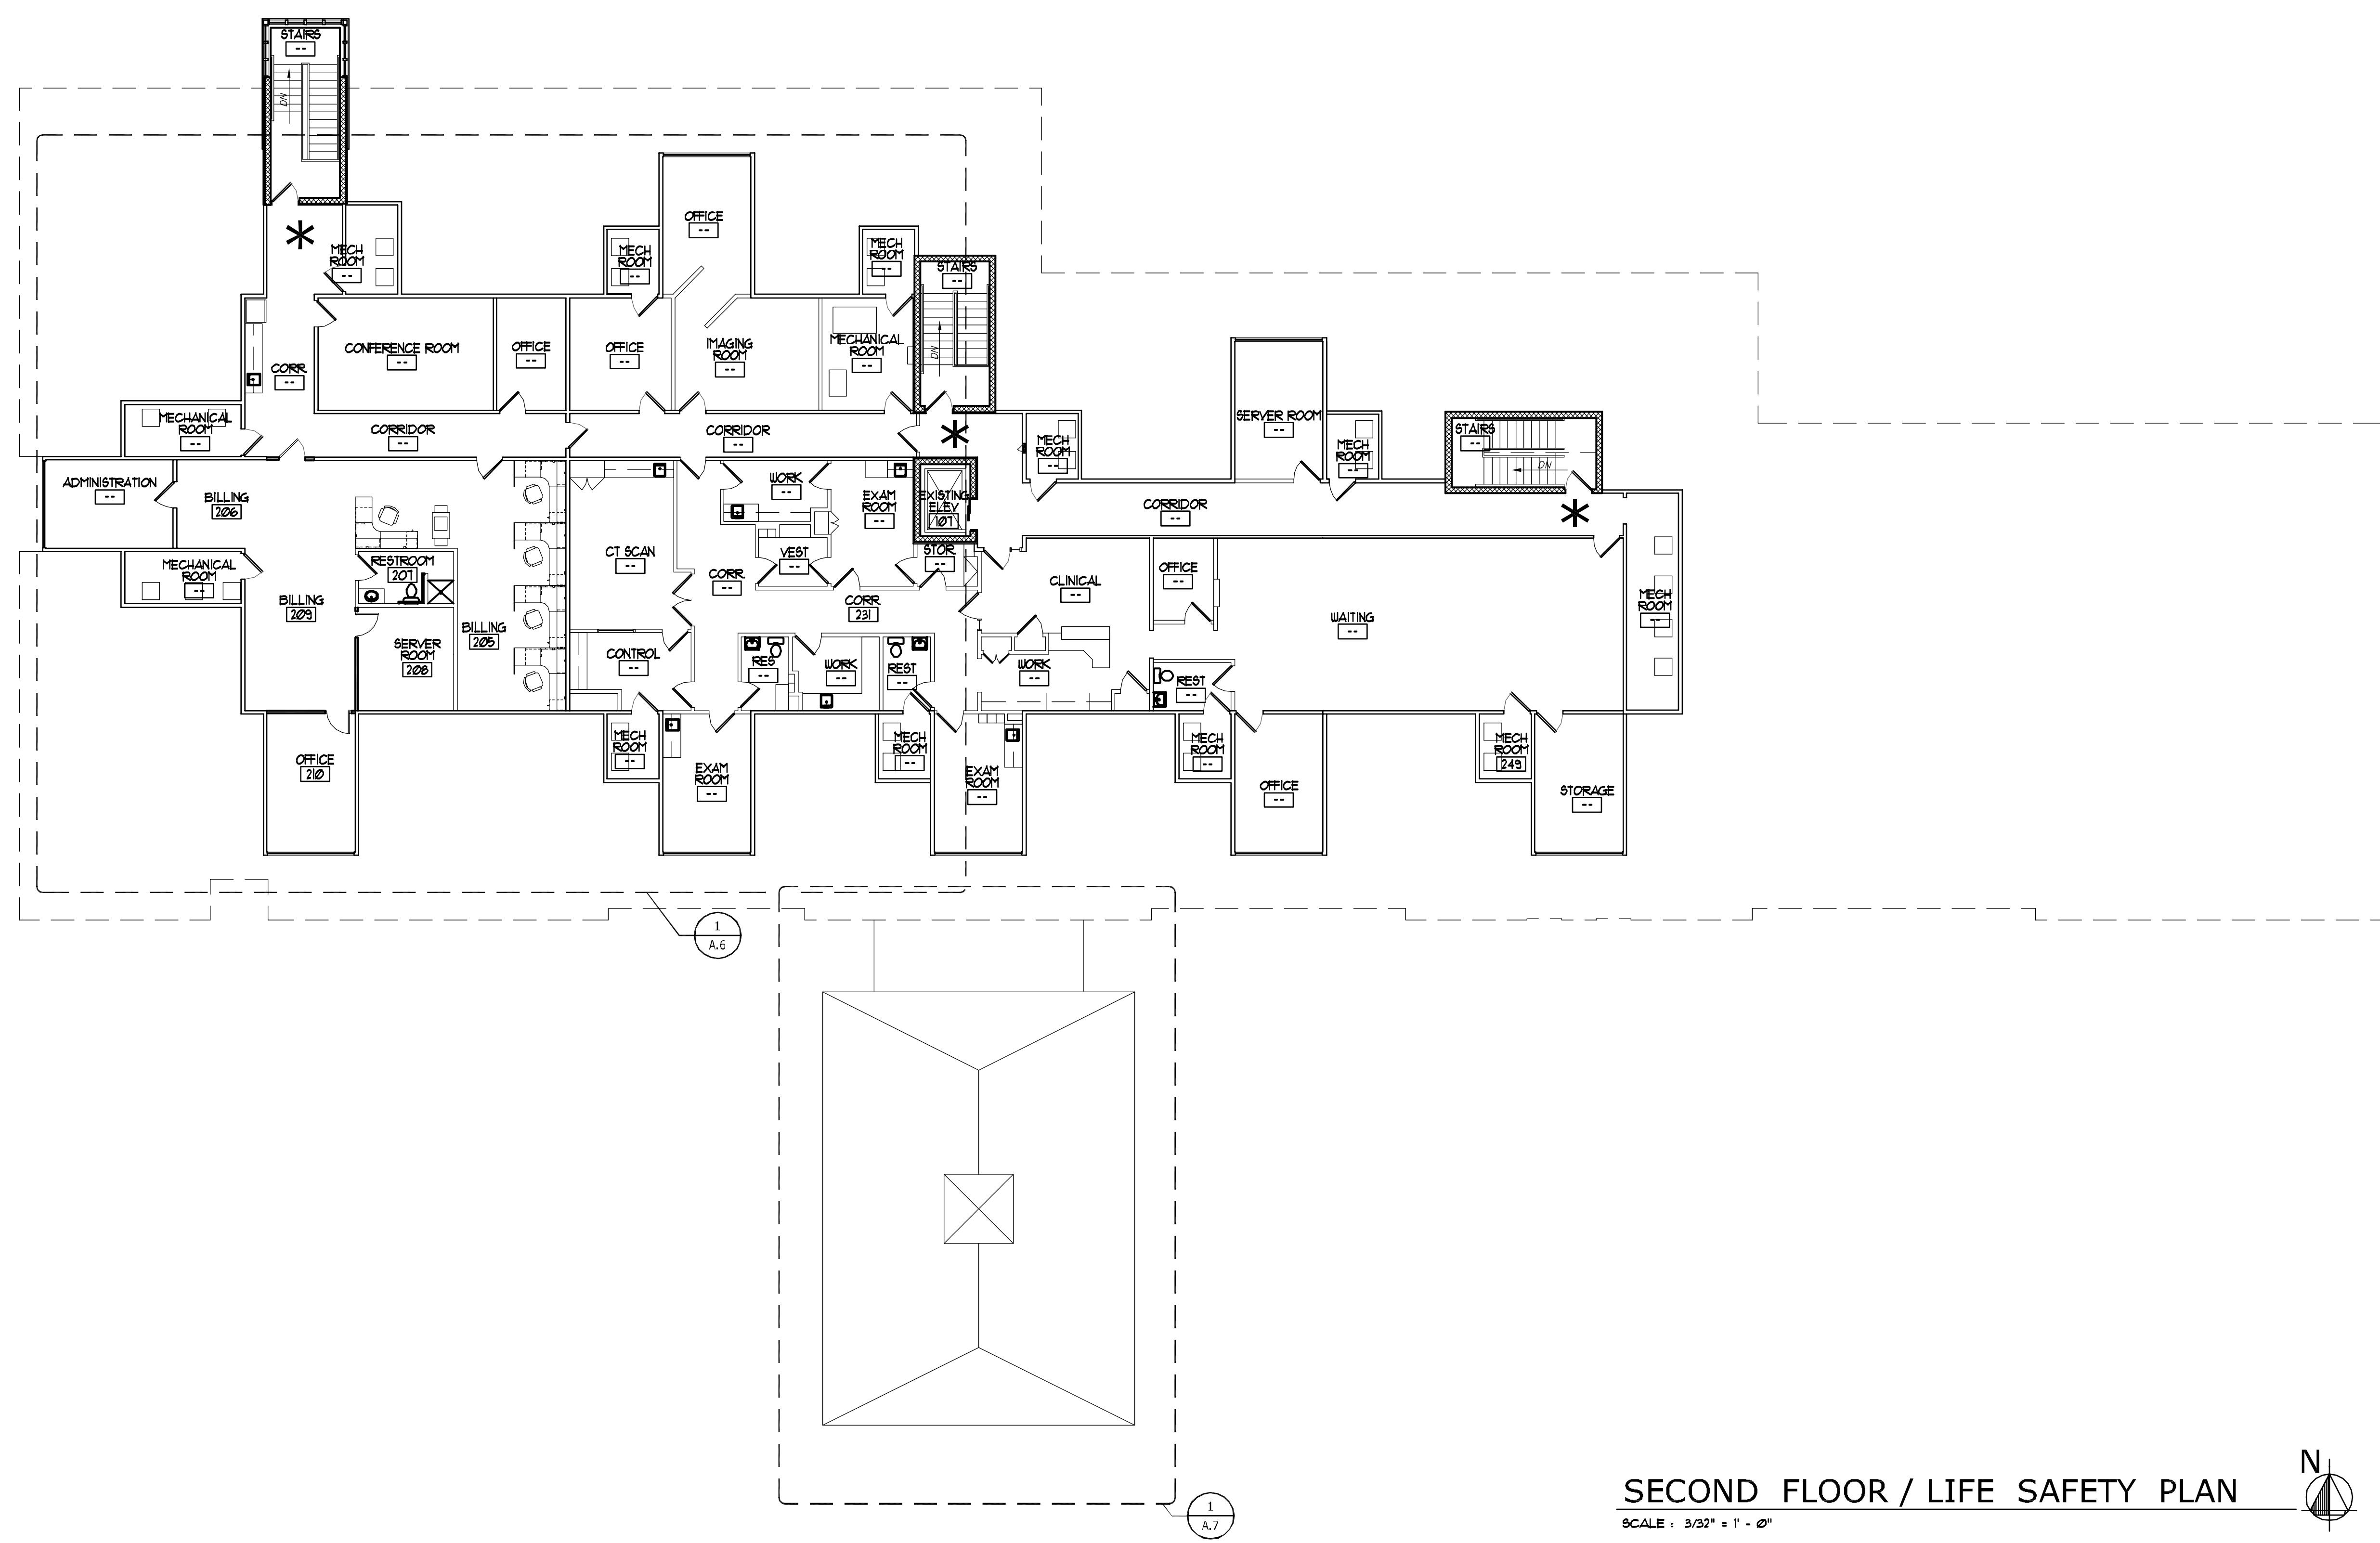
JASONWAY PROFESSIONAL BUILDING  
810 JASONWAY AVENUE, SUITE A  
COLUMBUS, OHIO 43214-2329




A.2  
sheet no.



**NOTES**  
 FIRE EXTINGUISHER CABINETS AND FIRE EXTINGUISHERS ARE ALREADY INSTALLED AND OPERATIONAL ON THIS EXISTING FLOOR.  
 \* DENOTES EXISTING EXITS (3) TOTAL FROM THE SECOND FLOOR.





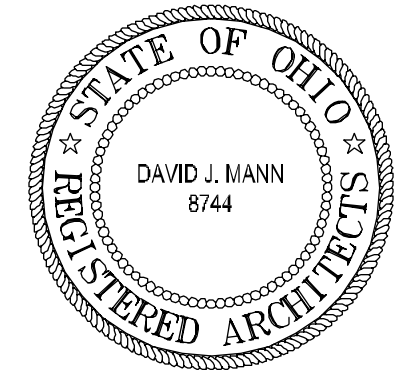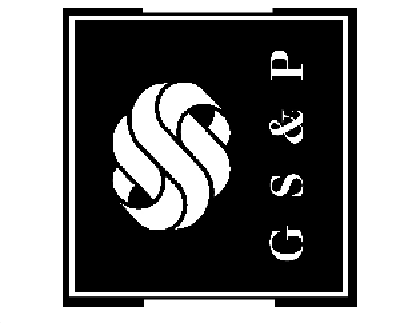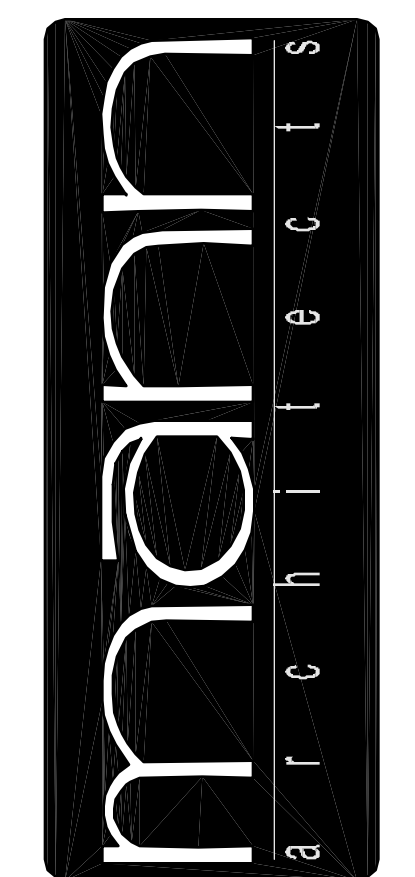**SECOND FLOOR / LIFE SAFETY PLAN**   
 SCALE: 3/32" = 1' - 0"



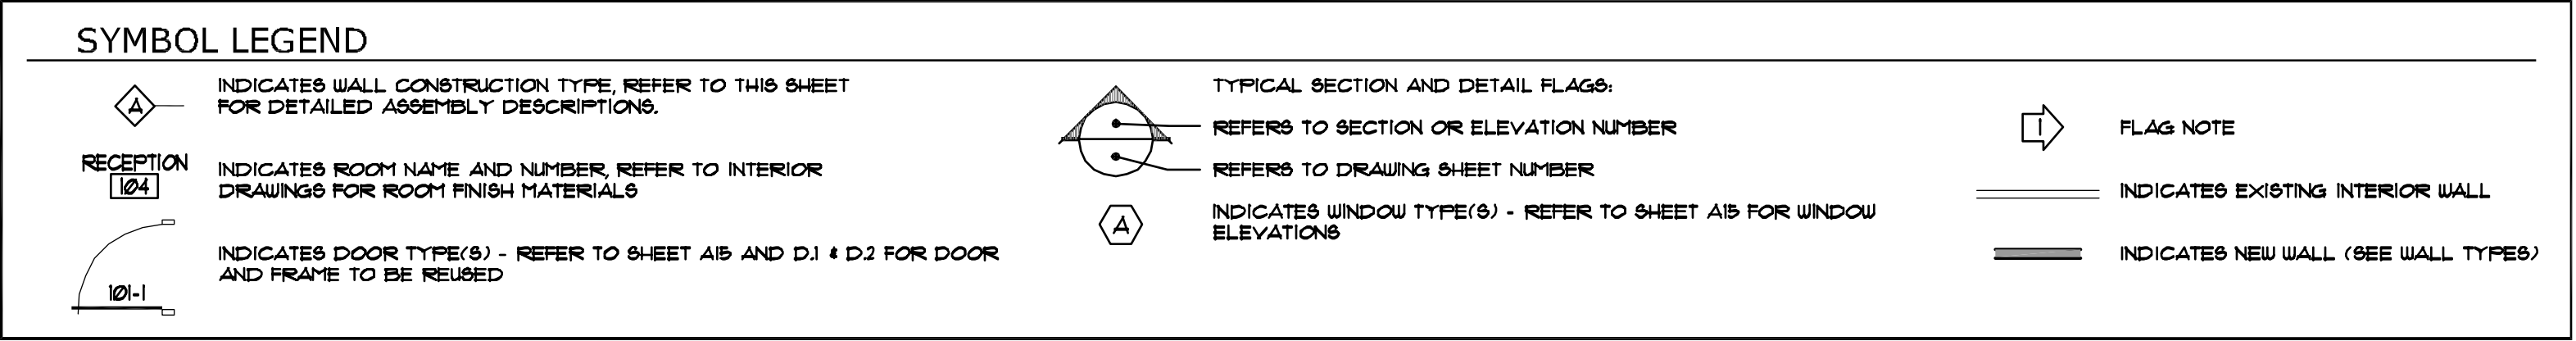
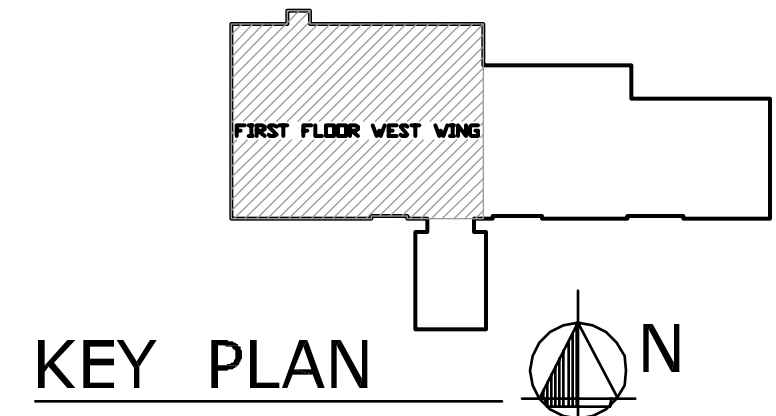
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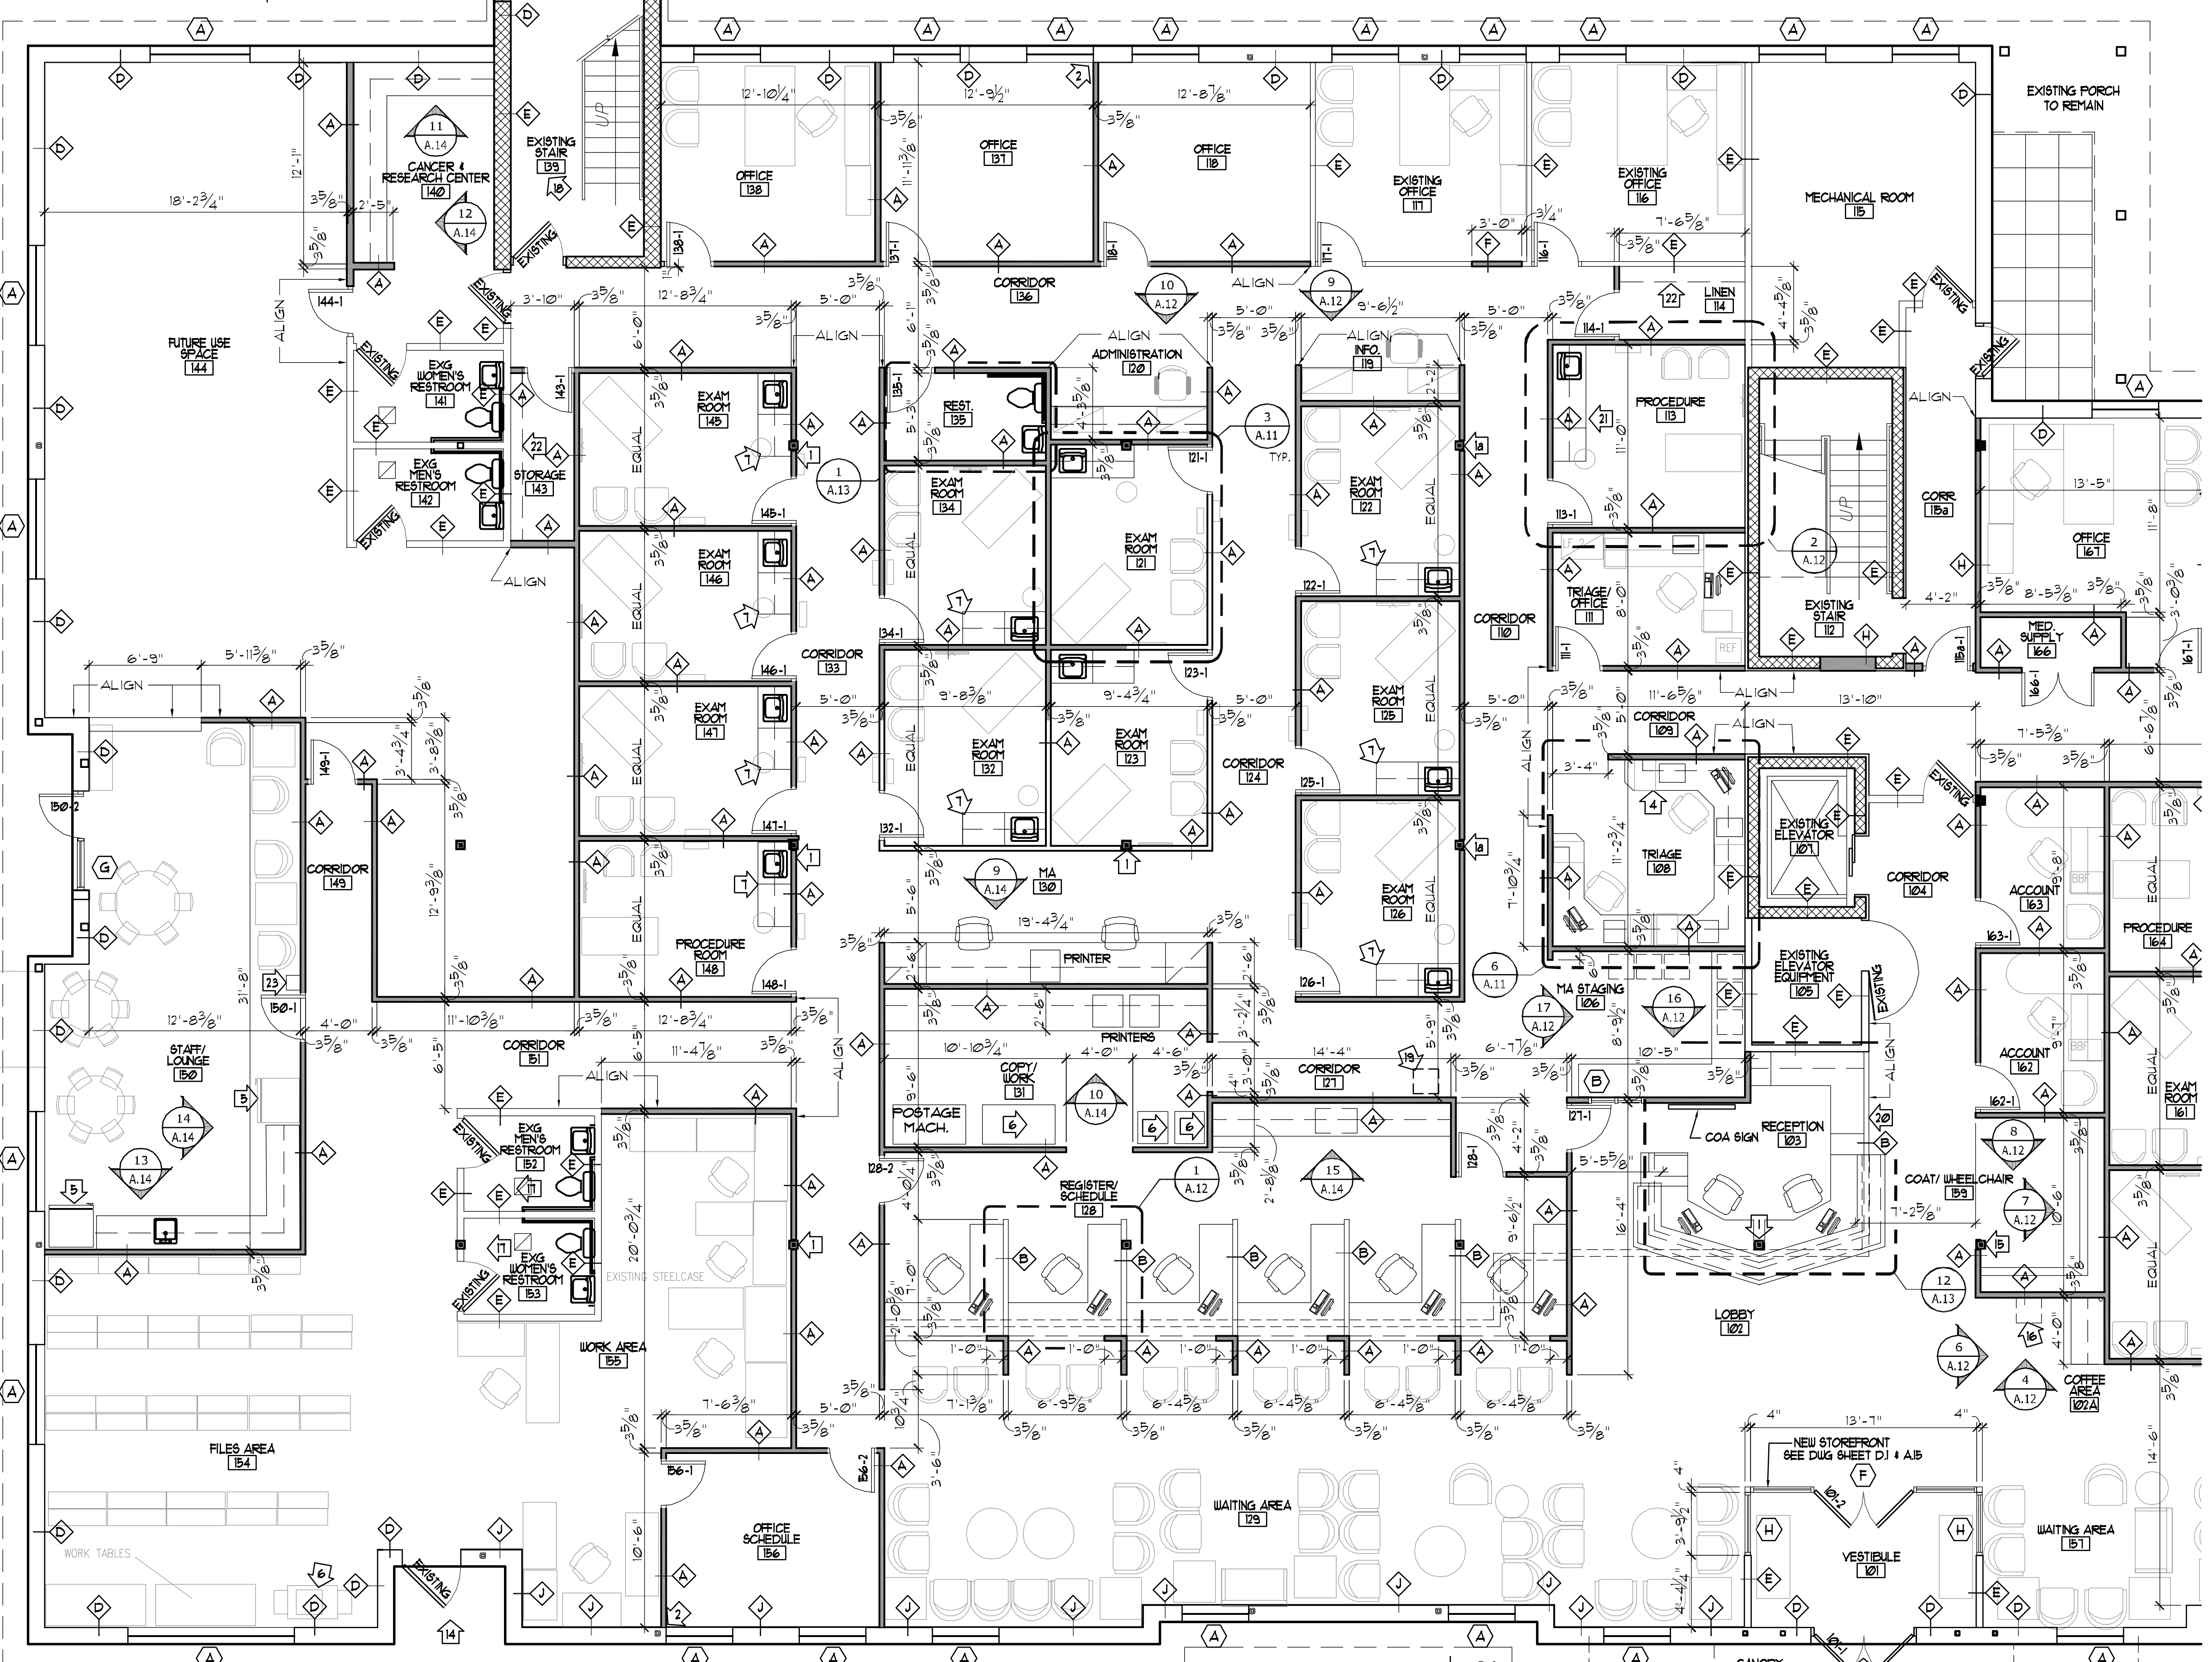


drawing  
**SECOND FLOOR / LIFE SAFETY PLAN** scale  
 project no. 11406 date OCTOBER 23, 2007 AS NOTED  
**COLUMBUS ONCOLOGY**  
 JASONIWAY PROFESSIONAL BUILDING  
 810 JASONIWAY AVENUE SUITE A  
 COLUMBUS, OHIO 43214-2329 project

**A.3**  
 OF 18  
 sheet no.



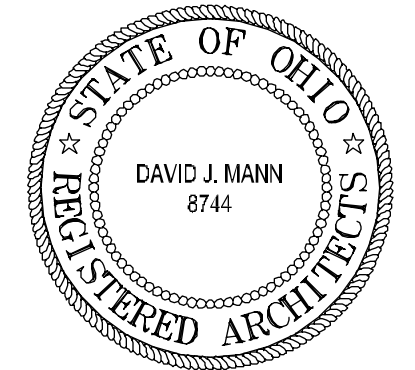
- ### GENERAL PLAN NOTES
- ALL INTERIOR PARTITION DIMENSIONS ARE FROM THE FACE OF FINISHED GYPSUM BOARD TO FACE OF FINISHED GYPSUM BOARD. AND FACE OF EXISTING WALLS, UNLESS NOTED OTHERWISE.
  - VERIFY ALL DIMENSIONED CONDITIONS IN THE FIELD. WHEN DIMENSIONS AND/OR CONDITIONS AS INDICATED ON THE DRAWINGS CONFLICT WITH ACTUAL, CONTACT THE ARCHITECT FOR CLARIFICATION.
  - ALL METAL STUDS SHALL BE 3/8" DEPTH, UNO, BRACE AS REQUIRED FOR LATERAL SUPPORT.
  - WALL THICKNESS INDICATED ON FLOOR PLAN(S) SHALL BE CONSTANT FOR THE ENTIRE LENGTH OF WALL (UNO).
  - PROVIDE BEHIND WALL REINFORCING AND BLOCKING AS REQUIRED FOR BEHIND DOOR STOPS, ATTACHMENT OF MILLWORK, CABEWORK, TOILET ACCESSORIES, ETC. - WOOD BLOCKING MUST BE FRU.
  - ALL EXTERIOR CORNERS THROUGHOUT SPACE TO HAVE METAL CORNER BEADS.



- ### WALL TYPE LEGEND
- INTERIOR PARTITION - 3/8" METAL STUDS (22 GAGE) AT 16" O.C. WITH 1/2" TYPE 'X' GYP. BOARD ON EACH SIDE OF WALL W/ 3/4" SOUND ATTENUATION. EXTEND WALL 6" ABOVE CEILING AND BRACE TO STRUCTURE ABOVE.
  - INTERIOR PARTITION - 54" HIGH (VERIFY WITH OWNER BEFORE CONSTRUCTION) - 3/8" METAL STUDS WITH 1/2" GYPSUM BOARD EACH SIDE WITH 1x6 OAK CAP AND 1/2"x3" OAK TRIM.
  - INTERIOR PARTITION - 6" METAL STUDS (22 GAGE) AT 16" O.C. WITH 1/2" TYPE 'X' GYP. BOARD ON EACH SIDE OF WALL W/ 3/4" SOUND ATTENUATION. EXTEND WALL 6" ABOVE CEILING AND BRACE TO STRUCTURE ABOVE.
  - EXISTING EXTERIOR WALL - TO REMAIN - REMOVE PAINT, DEBRIS, ABANDONED COMPONENTS AND HARDWARE, PATCH AND REPAIR AS REQUIRED. WHERE EXISTING PERPENDICULAR WALLS ARE REMOVED.
  - EXISTING INTERIOR WALL - TO REMAIN - REMOVE PAINT, DEBRIS, ABANDONED COMPONENTS AND HARDWARE, PATCH AND REPAIR AS REQ.
  - INTERIOR PARTITION - INFILL EXISTING DOOR OPENING WITH METAL STUDS AND GYPSUM BOARD ON BOTH SIDES TO MATCH WALL THICKNESS.
  - EXTERIOR WALL - FACE BRICK WITH 6" METAL STUD 22 GA AT 16" O.C BATT INSULATION 1/2" GYPSUM BOARD. BRICK VENEER TO MATCH EXISTING.
  - INTERIOR PARTITION (1 HOUR RATED) - 3/8" METAL STUDS (22 GAGE) AT 16" O.C. WITH 1/2" TYPE 'X' ON BOTH SIDES W/ 3/4" SOUND ATTENUATION. 1 HR WALL PER GA 1200. MATCH EXISTING WALL THICKNESS.
  - INTERIOR PARTITION - INSTALL NEW LAYER OF 1/2" TYPE 'X' GYP. BOARD FROM FLOOR TO UNDER SIDE OF STRUCTURE ABOVE. OVER EXISTING EXTERIOR WALL STUDS.
- NOTE 1: FIREBLOCKING SHALL BE PROVIDED IN CONCEALED SPACES OF STUD WALLS AND PARTITIONS, INCLUDING FURRING SPACES, AT THE CEILING AND THE FLOOR LEVEL. PER OBC 1112.2



- ### FLAG NOTES
- PARTITION IS TO BE CENTERED ON COLUMN CENTERLINE.
  - PARTITION IS TO BE FLUSHED WITH ONE SIDE OF COLUMN.
  - ALIGN FACE OF FINISHED WALL WITH FINISHED SURFACE OF WINDOW RECESS RETURN.
  - FIRE EXTINGUISHER IN RECESSED CABINET.
  - WORKSTATIONS, FURNISHED AND INSTALLED BY OWNER UNDER SEPARATE CONTRACT.
  - REFRIGERATOR, FURNISHED AND INSTALLED BY OWNER.
  - COPIER, FAX AND SHREDDER, FURNISHED AND INSTALLED BY OWNER.
  - RELOCATED/REINSTALLED MILLWORK AND COUNTERTOP/BACKSPLASH FOR EXAM ROOMS - SEE 3/A11.
  - FILE CABINETS, FURNISHED AND INSTALLED BY OWNER.
  - CART, FURNISHED BY OWNER.
  - TESTING EQUIPMENT RACK, FURNISHED AND INSTALLED BY OWNER.
  - CABINET, FURNISHED BY OWNER, INSTALLED BY CONTRACTOR.
  - CEILING-MOUNTED CURTAIN TRACK.
  - EXISTING AUTOMATIC DOOR OPENING ADA BUTTON.
  - ELECTRIC CODE ACCESS - SEE ELECTRICAL DRAWINGS.
  - WRAP EXISTING COLUMN WITH 1/2" GYPSUM BOARD.
  - COFFEE MACHINE SUPPLY BY OWNER.
  - EXISTING RESTROOM - SEE ROOM FINISH SCHEDULE.
  - FOAM INSULATION TO BE INSTALLED IN ALL (4) EXISTING WALLS (BLOCK CELL'S) FROM FLOOR TO ROOF BEARING HEIGHT OF 2ND FLOOR, BY CONTRACTOR.
  - PHYSICIAN ELECTRIC SCALE.
  - GC TO SUPPLY 3 FORM WALL PANEL AND INSTALL - COORDINATE SPEC AND SIZE WITH INTERIOR DESIGNER.
  - RELOCATED/REINSTALLED MILLWORK AND COUNTERTOP/BACKSPLASH FOR PROCEDURE ROOM. FROM EXISTING PROCEDURE ROOM.
  - REUSE EXISTING SHELVES. INSTALL AS REQUIRED. PROVIDE NEW BRACKETS AS REQ'D.
  - TIME CLOCK BY OWNER - PROVIDE WOOD BLOCKING WITHIN WALL.

**FIRST FLOOR PLAN - WEST**  
SCALE: 3/16" = 1' - 0"



revisions

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drawing  
**FIRST FLOOR PLAN - WEST**  
project no. 11406  
date OCTOBER 23, 2001  
scale AS NOTED

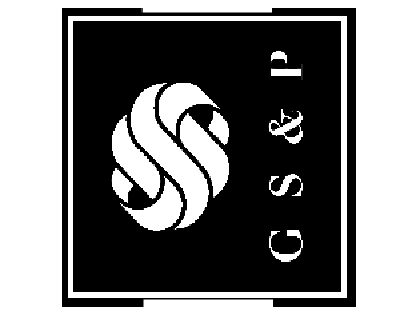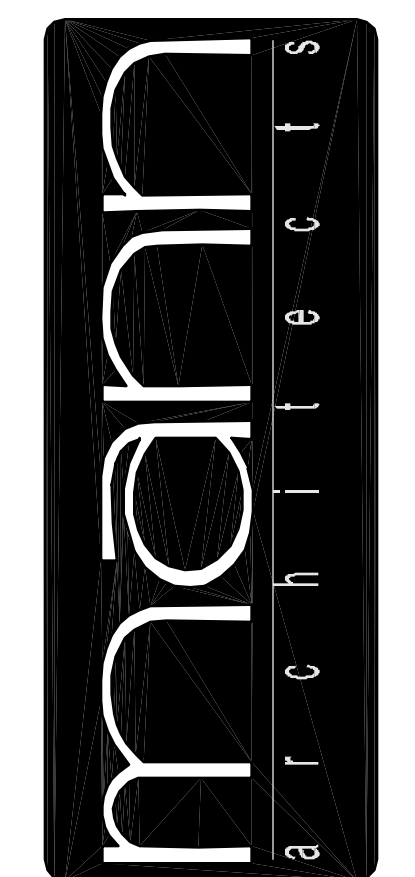**COLUMBUS ONCOLOGY**  
JASONIAT PROFESSIONAL BUILDING  
810 JASONIAT AVENUE, SUITE A  
COLUMBUS, OHIO 43214-2329

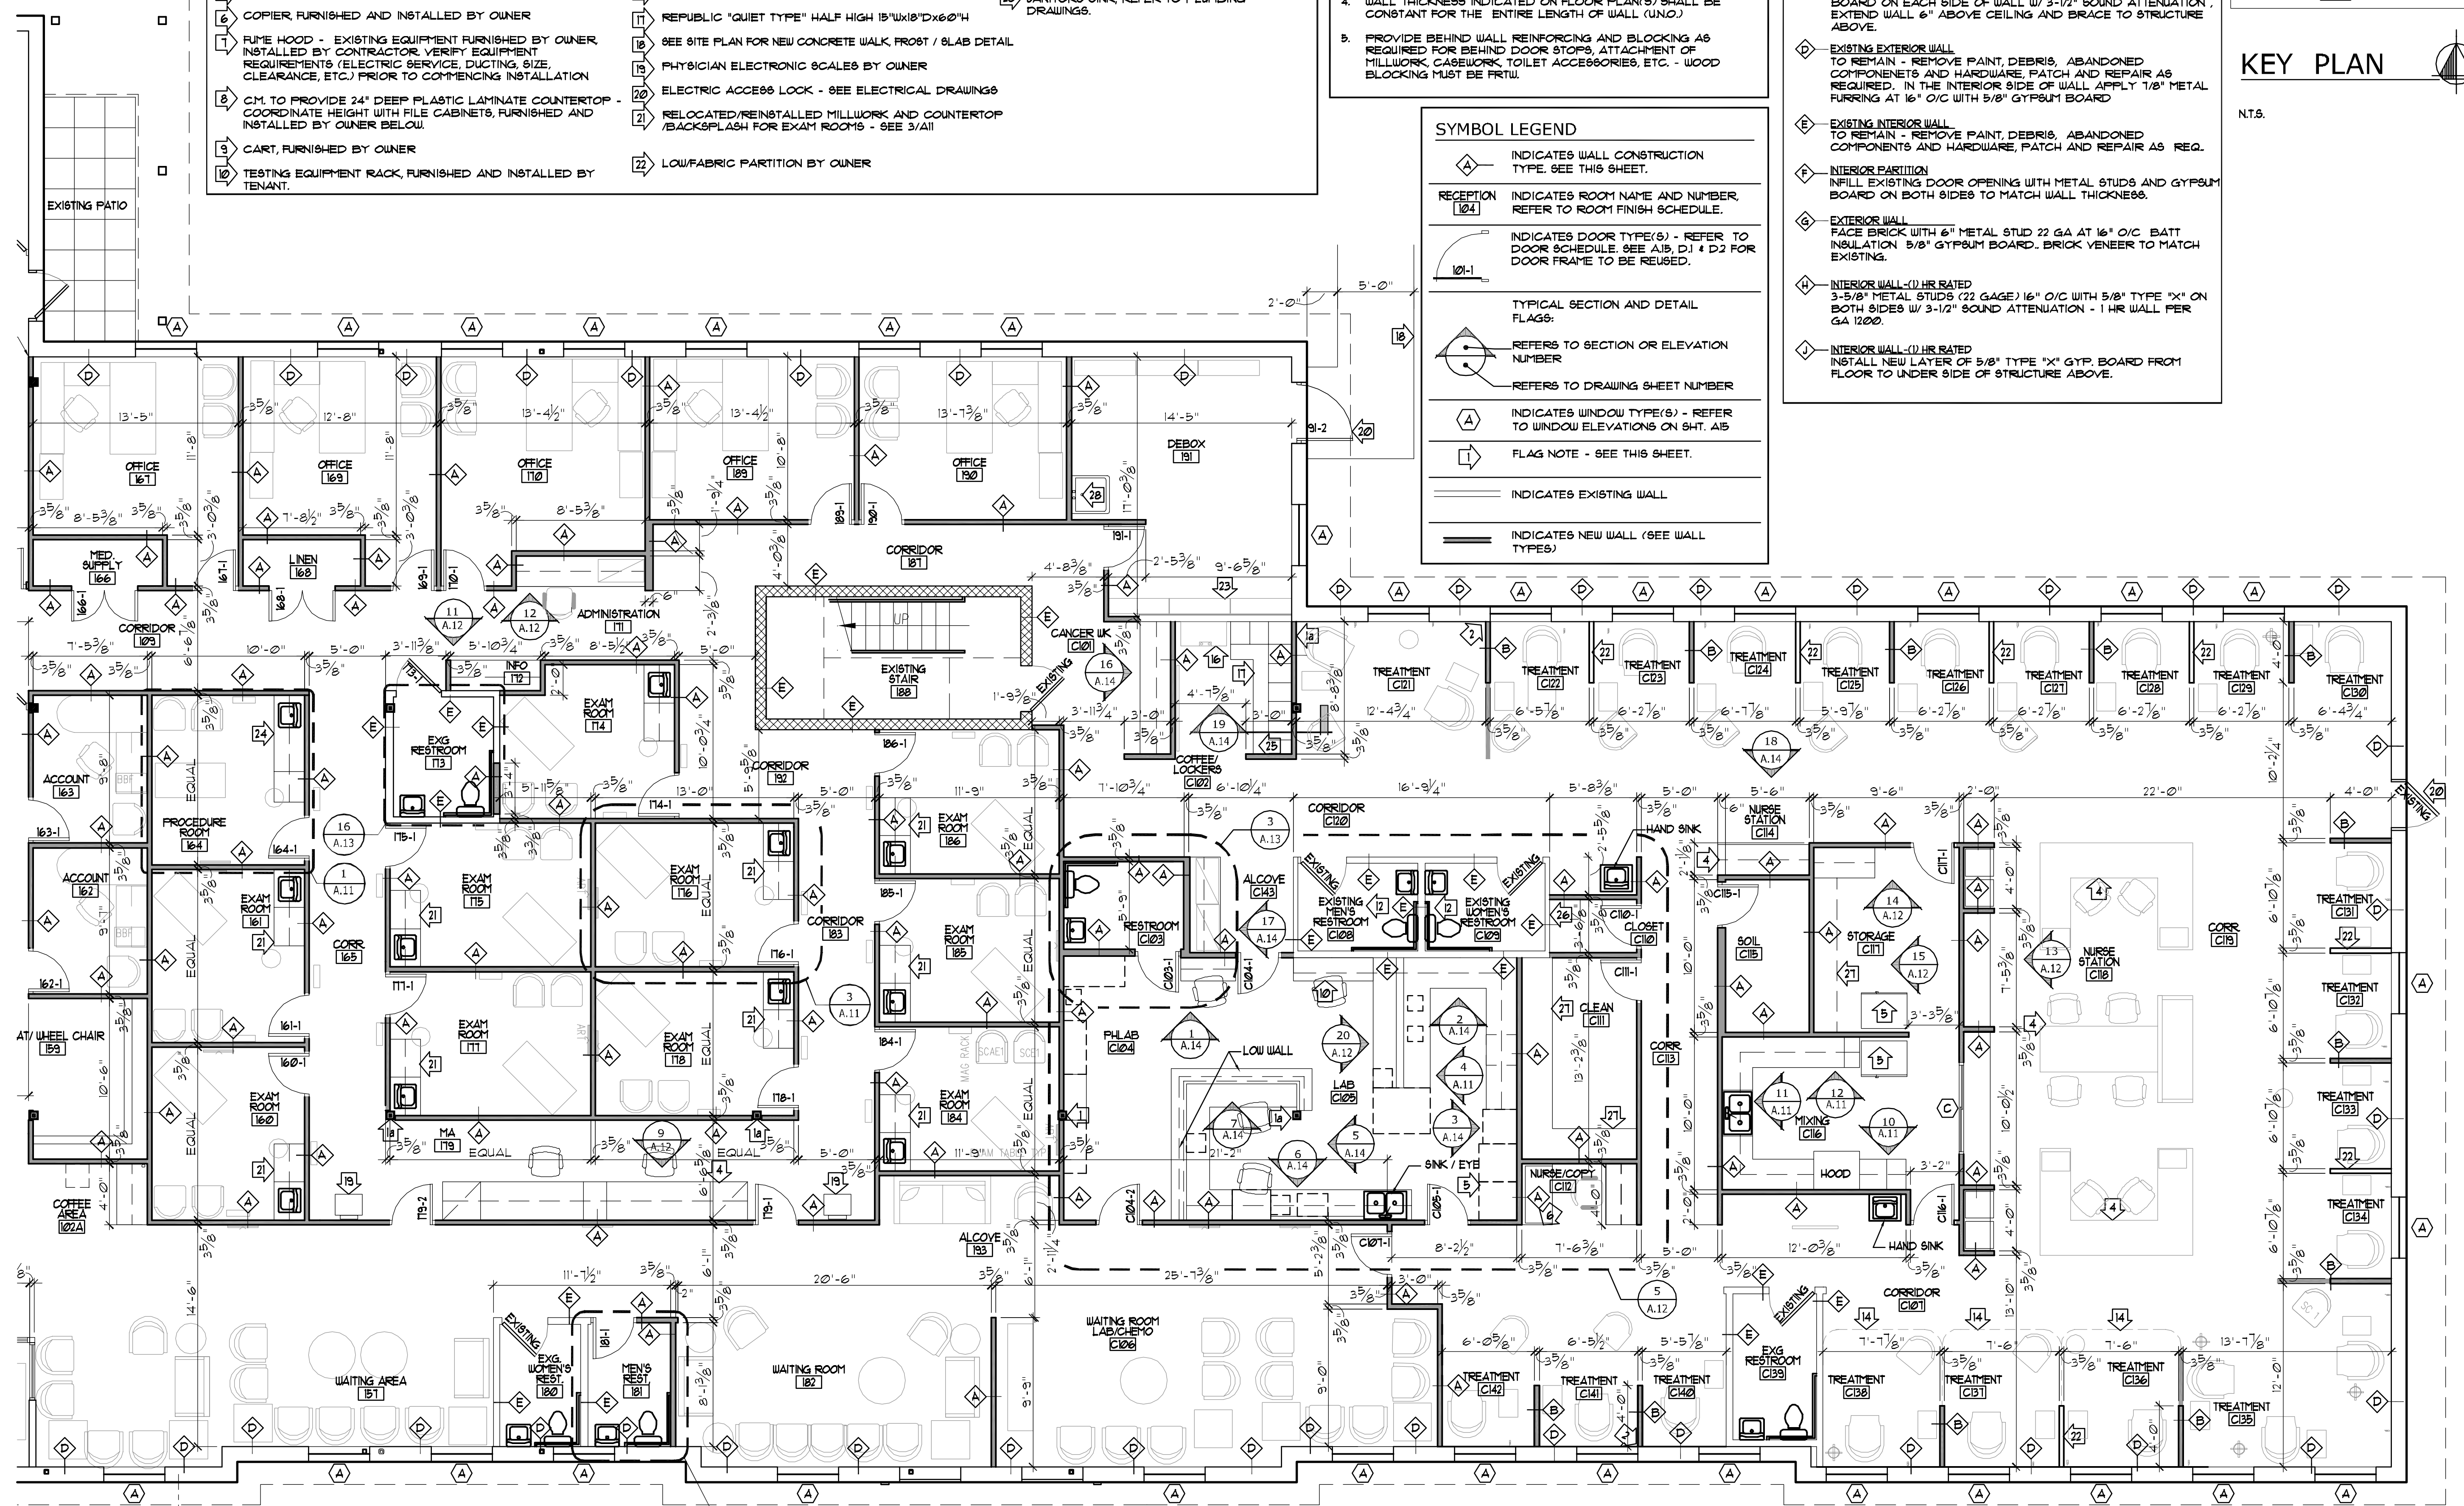
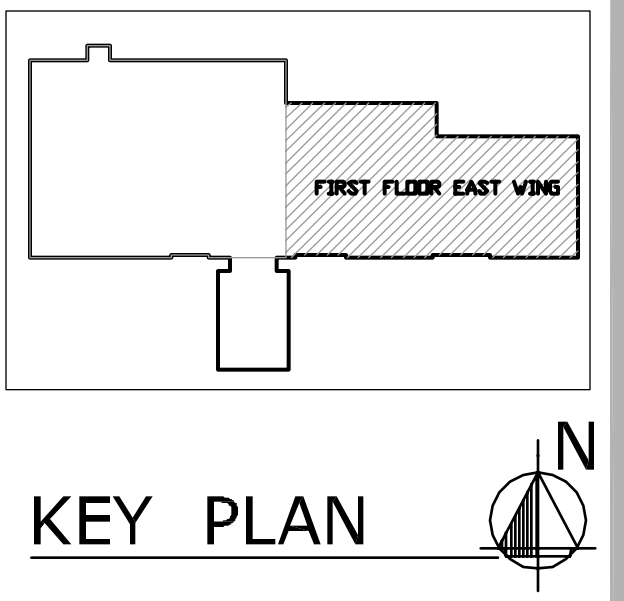
**A.4**  
OF 18  
sheet no.

- CODED NOTES:**
- 1 PARTITION IS TO BE CENTERED ON COLUMN CENTERLINE
  - 2 PARTITION IS TO BE FLUSHED WITH ONE SIDE OF COLUMN
  - 3 ALIGN FACE OF FINISHED WALL WITH FINISHED SURFACE OF WINDOW RECESS RETURN, REFER TO DETAIL 6/A-1
  - 4 FIRE EXTINGUISHER IN RECESSED CABINET
  - 5 WORKSTATIONS, FURNISHED AND INSTALLED BY OWNER UNDER SEPARATE CONTRACT.
  - 6 REFRIGERATOR, FURNISHED AND INSTALLED BY OWNER
  - 7 COPIER, FURNISHED AND INSTALLED BY OWNER
  - 8 FUME HOOD - EXISTING EQUIPMENT FURNISHED BY OWNER, INSTALLED BY CONTRACTOR. VERIFY EQUIPMENT REQUIREMENTS (ELECTRIC SERVICE, DUCTING, SIZE, CLEARANCE, ETC.) PRIOR TO COMMENCING INSTALLATION
  - 9 C.M. TO PROVIDE 24" DEEP PLASTIC LAMINATE COUNTERTOP - COORDINATE HEIGHT WITH FILE CABINETS, FURNISHED AND INSTALLED BY OWNER BELOW.
  - 10 CART, FURNISHED BY OWNER
  - 11 TESTING EQUIPMENT RACK, FURNISHED AND INSTALLED BY TENANT.
  - 12 CABINET, FURNISHED BY OWNER, INSTALLED BY C.M.
  - 13 EXISTING RESTROOM, SEE ROOM FINISH SCHEDULE
  - 14 NOT USED
  - 15 CUBICAL CURTAINS - REFER TO REFLECTED CEILING DRAWINGS
  - 16 WRAP EXISTING COLUMN WITH 5/8" GYPSUM BOARD
  - 17 FURNITURE BY OWNER
  - 18 REPUBLIC "QUIET TYPE" HALF HIGH 15"Wx18"Dx60"H
  - 19 SEE SITE PLAN FOR NEW CONCRETE WALK, FROST / SLAB DETAIL
  - 20 PHYSICIAN ELECTRONIC SCALES BY OWNER
  - 21 ELECTRIC ACCESS LOCK - SEE ELECTRICAL DRAWINGS
  - 22 RELOCATED/REINSTALLED MILLWORK AND COUNTERTOP /BACKSPLASH FOR EXAM ROOMS - SEE 3/A11
  - 23 LAB STORAGE SHELVES BY OWNER
  - 24 RELOCATED / REINSTALLED MILLWORK / COUNTERTOP / BACKSPLASH FOR PROCEDURE ROOM. FROM EXISTING PROCEDURE ROOM. SEE 1/A11
  - 25 TIME CLOCK BY OWNER
  - 26 RELOCATED EXISTING SHELVES
  - 27 STORAGE SHELVES BY OWNER, C.M. TO PROVIDE WOOD BLOCKING WITHIN WALL, SEE 12.A.12.
  - 28 JANITORS SINK, REFER TO PLUMBING DRAWINGS.
  - 29 LOW/FABRIC PARTITION BY OWNER


- GENERAL PLAN NOTES**
- ALL INTERIOR PARTITION DIMENSIONS ARE FROM THE FACE OF STUD TO FACE OF STUD, AND FACE OF EXISTING WALLS, UNLESS NOTED OTHERWISE.
  - VERIFY ALL DIMENSIONED CONDITIONS IN THE FIELD. WHEN DIMENSIONS AND/OR CONDITIONS AS INDICATED ON THE DRAWINGS CONFLICT WITH ACTUAL, CONTACT THE ARCHITECT FOR CLARIFICATION.
  - ALL METAL STUDS SHALL BE 3 3/8" DEPTH, UNO, BRACE AS REQUIRED FOR LATERAL SUPPORT.
  - WALL THICKNESS INDICATED ON FLOOR PLAN(S) SHALL BE CONSTANT FOR THE ENTIRE LENGTH OF WALL (UNO.)
  - PROVIDE BEHIND WALL REINFORCING AND BLOCKING AS REQUIRED FOR BEHIND DOOR STOPS, ATTACHMENT OF MILLWORK, CASEWORK, TOILET ACCESSORIES, ETC. - WOOD BLOCKING MUST BE FRT.W.

- WALL TYPE LEGEND**
- ◇ INTERIOR PARTITION  
3-3/8" METAL STUDS (22 GAGE) AT 16" O.C. WITH 3/4" TYPE 'X' GYP. BOARD ON EACH SIDE OF WALL W/ 3-1/2" SOUND ATTENUATION. EXTEND WALL 6" ABOVE CEILING AND BRACE TO STRUCTURE ABOVE.
  - ◇ INTERIOR PARTITION  
42" HIGH - 3-5/8" METAL STUDS WITH 5/8" GYPSUM BOARD EACH SIDE WITH 2x6 WOOD CAP FINISH
  - ◇ INTERIOR PARTITION  
6" METAL STUDS (22 GAGE) AT 16" O.C. WITH 5/8" TYPE 'X' GYP. BOARD ON EACH SIDE OF WALL W/ 3-1/2" SOUND ATTENUATION. EXTEND WALL 6" ABOVE CEILING AND BRACE TO STRUCTURE ABOVE.
  - ◇ EXISTING EXTERIOR WALL  
TO REMAIN - REMOVE PAINT, DEBRIS, ABANDONED COMPONENTS AND HARDWARE, PATCH AND REPAIR AS REQ.
  - ◇ EXISTING INTERIOR WALL  
TO REMAIN - REMOVE PAINT, DEBRIS, ABANDONED COMPONENTS AND HARDWARE, PATCH AND REPAIR AS REQ.
  - ◇ INTERIOR PARTITION  
INFILL EXISTING DOOR OPENING WITH METAL STUDS AND GYPSUM BOARD ON BOTH SIDES TO MATCH WALL THICKNESS.
  - ◇ EXTERIOR WALL  
FACE BRICK WITH 6" METAL STUD 22 GA AT 16" O/C BATT INSULATION 5/8" GYPSUM BOARD. BRICK VENEER TO MATCH EXISTING.
  - ◇ INTERIOR WALL (1 HR RATED)  
3-5/8" METAL STUDS (22 GAGE) 16" O/C WITH 5/8" TYPE 'X' ON BOTH SIDES W/ 3-1/2" SOUND ATTENUATION - 1 HR WALL PER GA 1200.
  - ◇ INTERIOR WALL (1 HR RATED)  
INSTALL NEW LAYER OF 5/8" TYPE 'X' GYP. BOARD FROM FLOOR TO UNDER SIDE OF STRUCTURE ABOVE.


- SYMBOL LEGEND**
- ◇ INDICATES WALL CONSTRUCTION TYPE. SEE THIS SHEET.
  - RECEPTION [104] INDICATES ROOM NAME AND NUMBER. REFER TO ROOM FINISH SCHEDULE.
  - 104-1 INDICATES DOOR TYPE(S) - REFER TO DOOR SCHEDULE. SEE A15, D1 & D2 FOR DOOR FRAME TO BE REUSED.
  - TYPICAL SECTION AND DETAIL FLAGS:  
REFERS TO SECTION OR ELEVATION NUMBER
  - REFERS TO DRAWING SHEET NUMBER
  - ◇ INDICATES WINDOW TYPE(S) - REFER TO WINDOW ELEVATIONS ON SHT. A15
  - 1 INDICATES FLAG NOTE - SEE THIS SHEET.
  - INDICATES EXISTING WALL
  - INDICATES NEW WALL (SEE WALL TYPES)



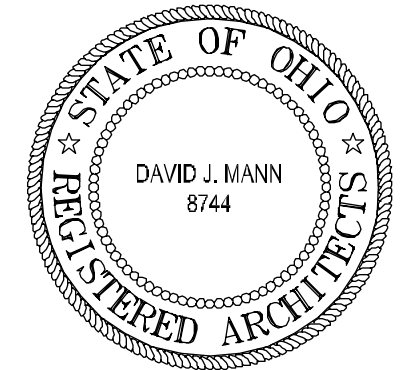
**FIRST FLOOR PLAN - EAST**  
SCALE: 3/16" = 1' - 0"



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drawing  
**FIRST FLOOR PLAN - EAST**  
project no. 11406  
date OCTOBER 23, 2001  
scale AS NOTED

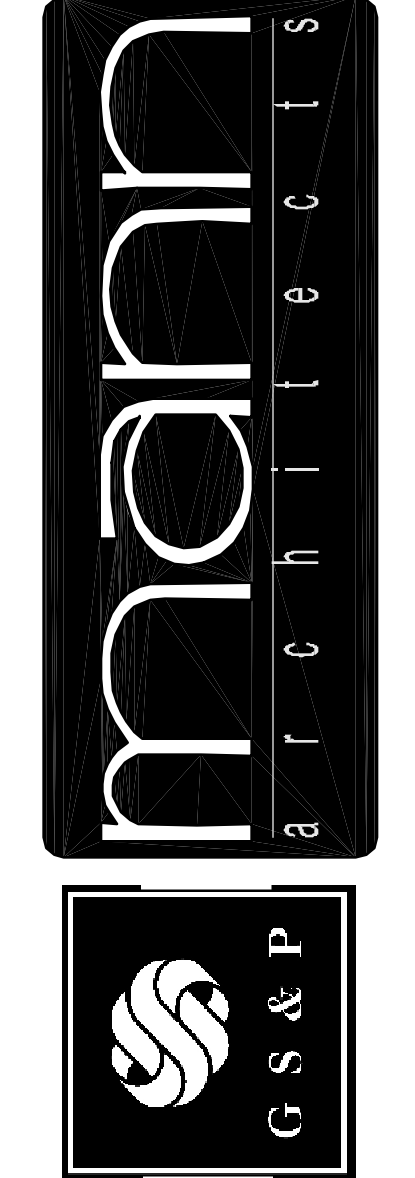

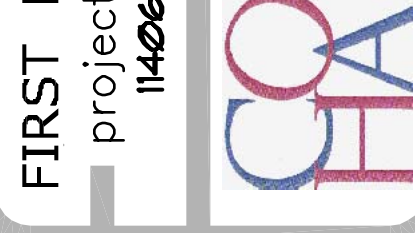**COLUMBUS ONCOLOGY**  
JASONWAY PROFESSIONAL BUILDING  
810 JASONWAY AVENUE, SUITE A  
COLUMBUS, OHIO 43214-2329

SYMBOL LEGEND		TYPICAL SECTION AND DETAIL FLAGS:	
	INDICATES WALL CONSTRUCTION TYPE, REFER TO THIS SHEET FOR DETAILED ASSEMBLY DESCRIPTIONS		REFERS TO SECTION OR ELEVATION NUMBER
	INDICATES ROOM NAME AND NUMBER, REFER TO ROOM FINISH SCHEDULE		REFERS TO DRAWING SHEET NUMBER
	INDICATES DOOR TYPE(S) - REFER TO DOOR SCHEDULE		INDICATES WINDOW TYPE(S) - REFER TO SHEET A15 FOR WINDOW ELEVATIONS
			FLAG NOTE
			INDICATES EXISTING INTERIOR WALL
			INDICATES NEW WALL (SEE WALL TYPES)



- ### GENERAL PLAN NOTES
- ALL INTERIOR PARTITION DIMENSIONS ARE FROM THE FACE OF FINISHED GYPSUM BOARD TO FACE OF FINISHED GYPSUM BOARD AND FACE OF EXISTING WALLS, UNLESS NOTED OTHERWISE.
  - VERIFY ALL DIMENSIONED CONDITIONS IN THE FIELD. WHEN DIMENSIONS AND/OR CONDITIONS AS INDICATED ON THE DRAWINGS CONFLICT WITH ACTUAL, CONTACT THE ARCHITECT FOR CLARIFICATION.
  - ALL METAL STUDS SHALL BE 3/4" DEPTH, UNO, BRACE AS REQUIRED FOR LATERAL SUPPORT.
  - WALL THICKNESS INDICATED ON FLOOR PLAN(S) SHALL BE CONSTANT FOR THE ENTIRE LENGTH OF WALL (UNO).
  - PROVIDE BEHIND WALL REINFORCING AND BLOCKING AS REQUIRED FOR BEHIND DOOR STOPS, ATTACHMENT OF MILLWORK, CASEWORK, TOILET ACCESSORIES, ETC. - WOOD BLOCKING MUST BE FRTU.
  - ALL EXTERIOR CORNERS THROUGHOUT SPACE TO HAVE METAL CORNER BEADS.

- ### WALL TYPE LEGEND
- INTERIOR PARTITION - 3/4" METAL STUDS (22 GAGE) AT 16" O.C. WITH 1/2" TYPE 'X' GYP. BOARD ON EACH SIDE OF WALL, EXTEND WALL TIGHT TO DECK ABOVE.
  - INTERIOR PARTITION - 48" HIGH - 3/4" METAL STUDS WITH 5/8" GYPSUM BOARD EACH SIDE WITH 2x6 WOOD CAP FINISH.
  - INTERIOR PARTITION - 6" METAL STUDS (22 GAGE) AT 16" O.C. WITH 1/2" TYPE 'X' GYP. BOARD ON EACH SIDE OF WALL, EXTEND WALL TIGHT TO DECK ABOVE.
  - EXISTING EXTERIOR WALL - TO REMAIN - REMOVE PAINT, DEBRIS, ABANDONED COMPONENTS AND HARDWARE, PATCH AND REPAIR AS REQUIRED. IN THE INTERIOR SIDE OF WALL, APPLY 1/2" METAL FURRING AT 16" O.C. WITH 5/8" GYPSUM BOARD.
  - EXISTING INTERIOR WALL - TO REMAIN - REMOVE PAINT, DEBRIS, ABANDONED COMPONENTS AND HARDWARE, PATCH AND REPAIR AS REQ.
- NOTE 1: FIREBLOCKING SHALL BE PROVIDED IN CONCEALED SPACES OF STUD WALLS AND PARTITIONS, INCLUDING FURRING SPACES, AT THE CEILING AND THE FLOOR LEVEL. PER OBC 11122

### ROOM TAG NOTE

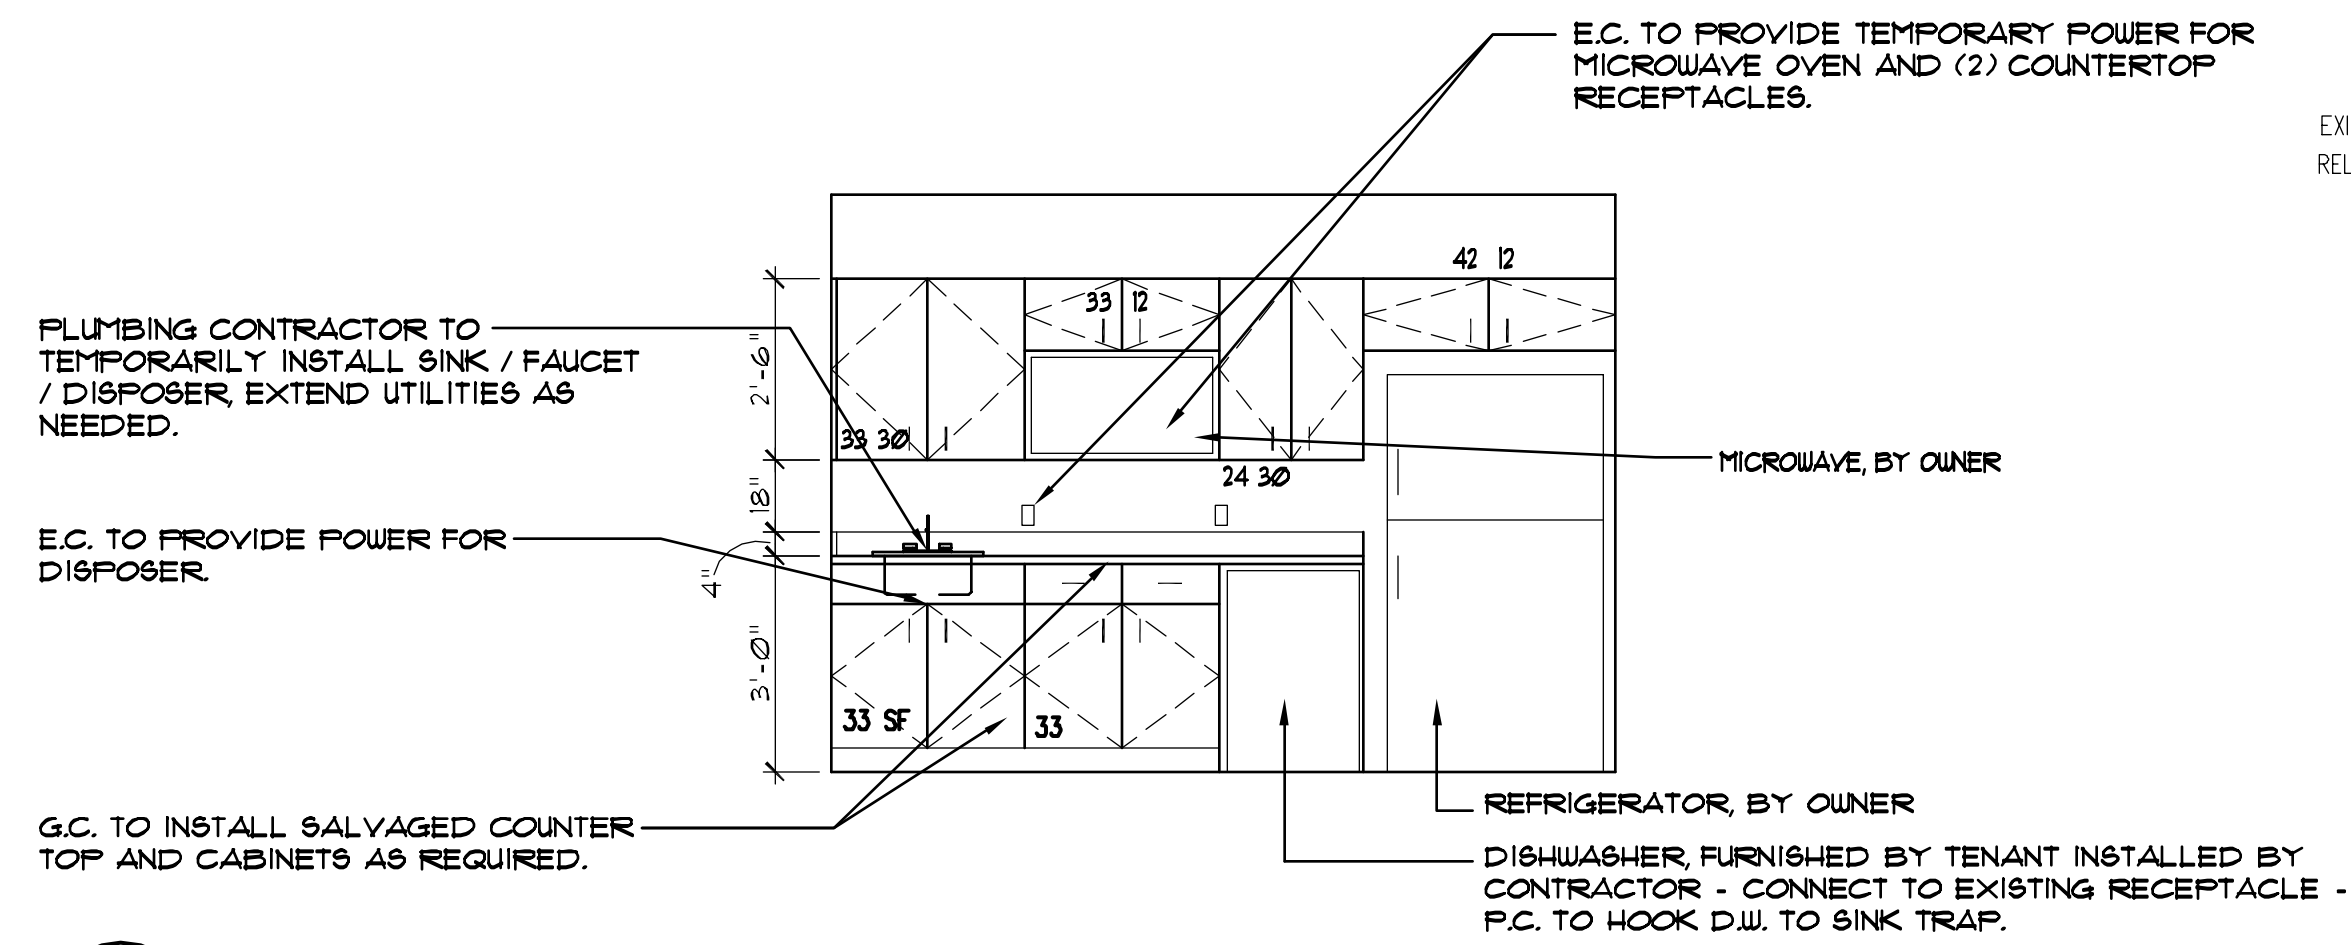
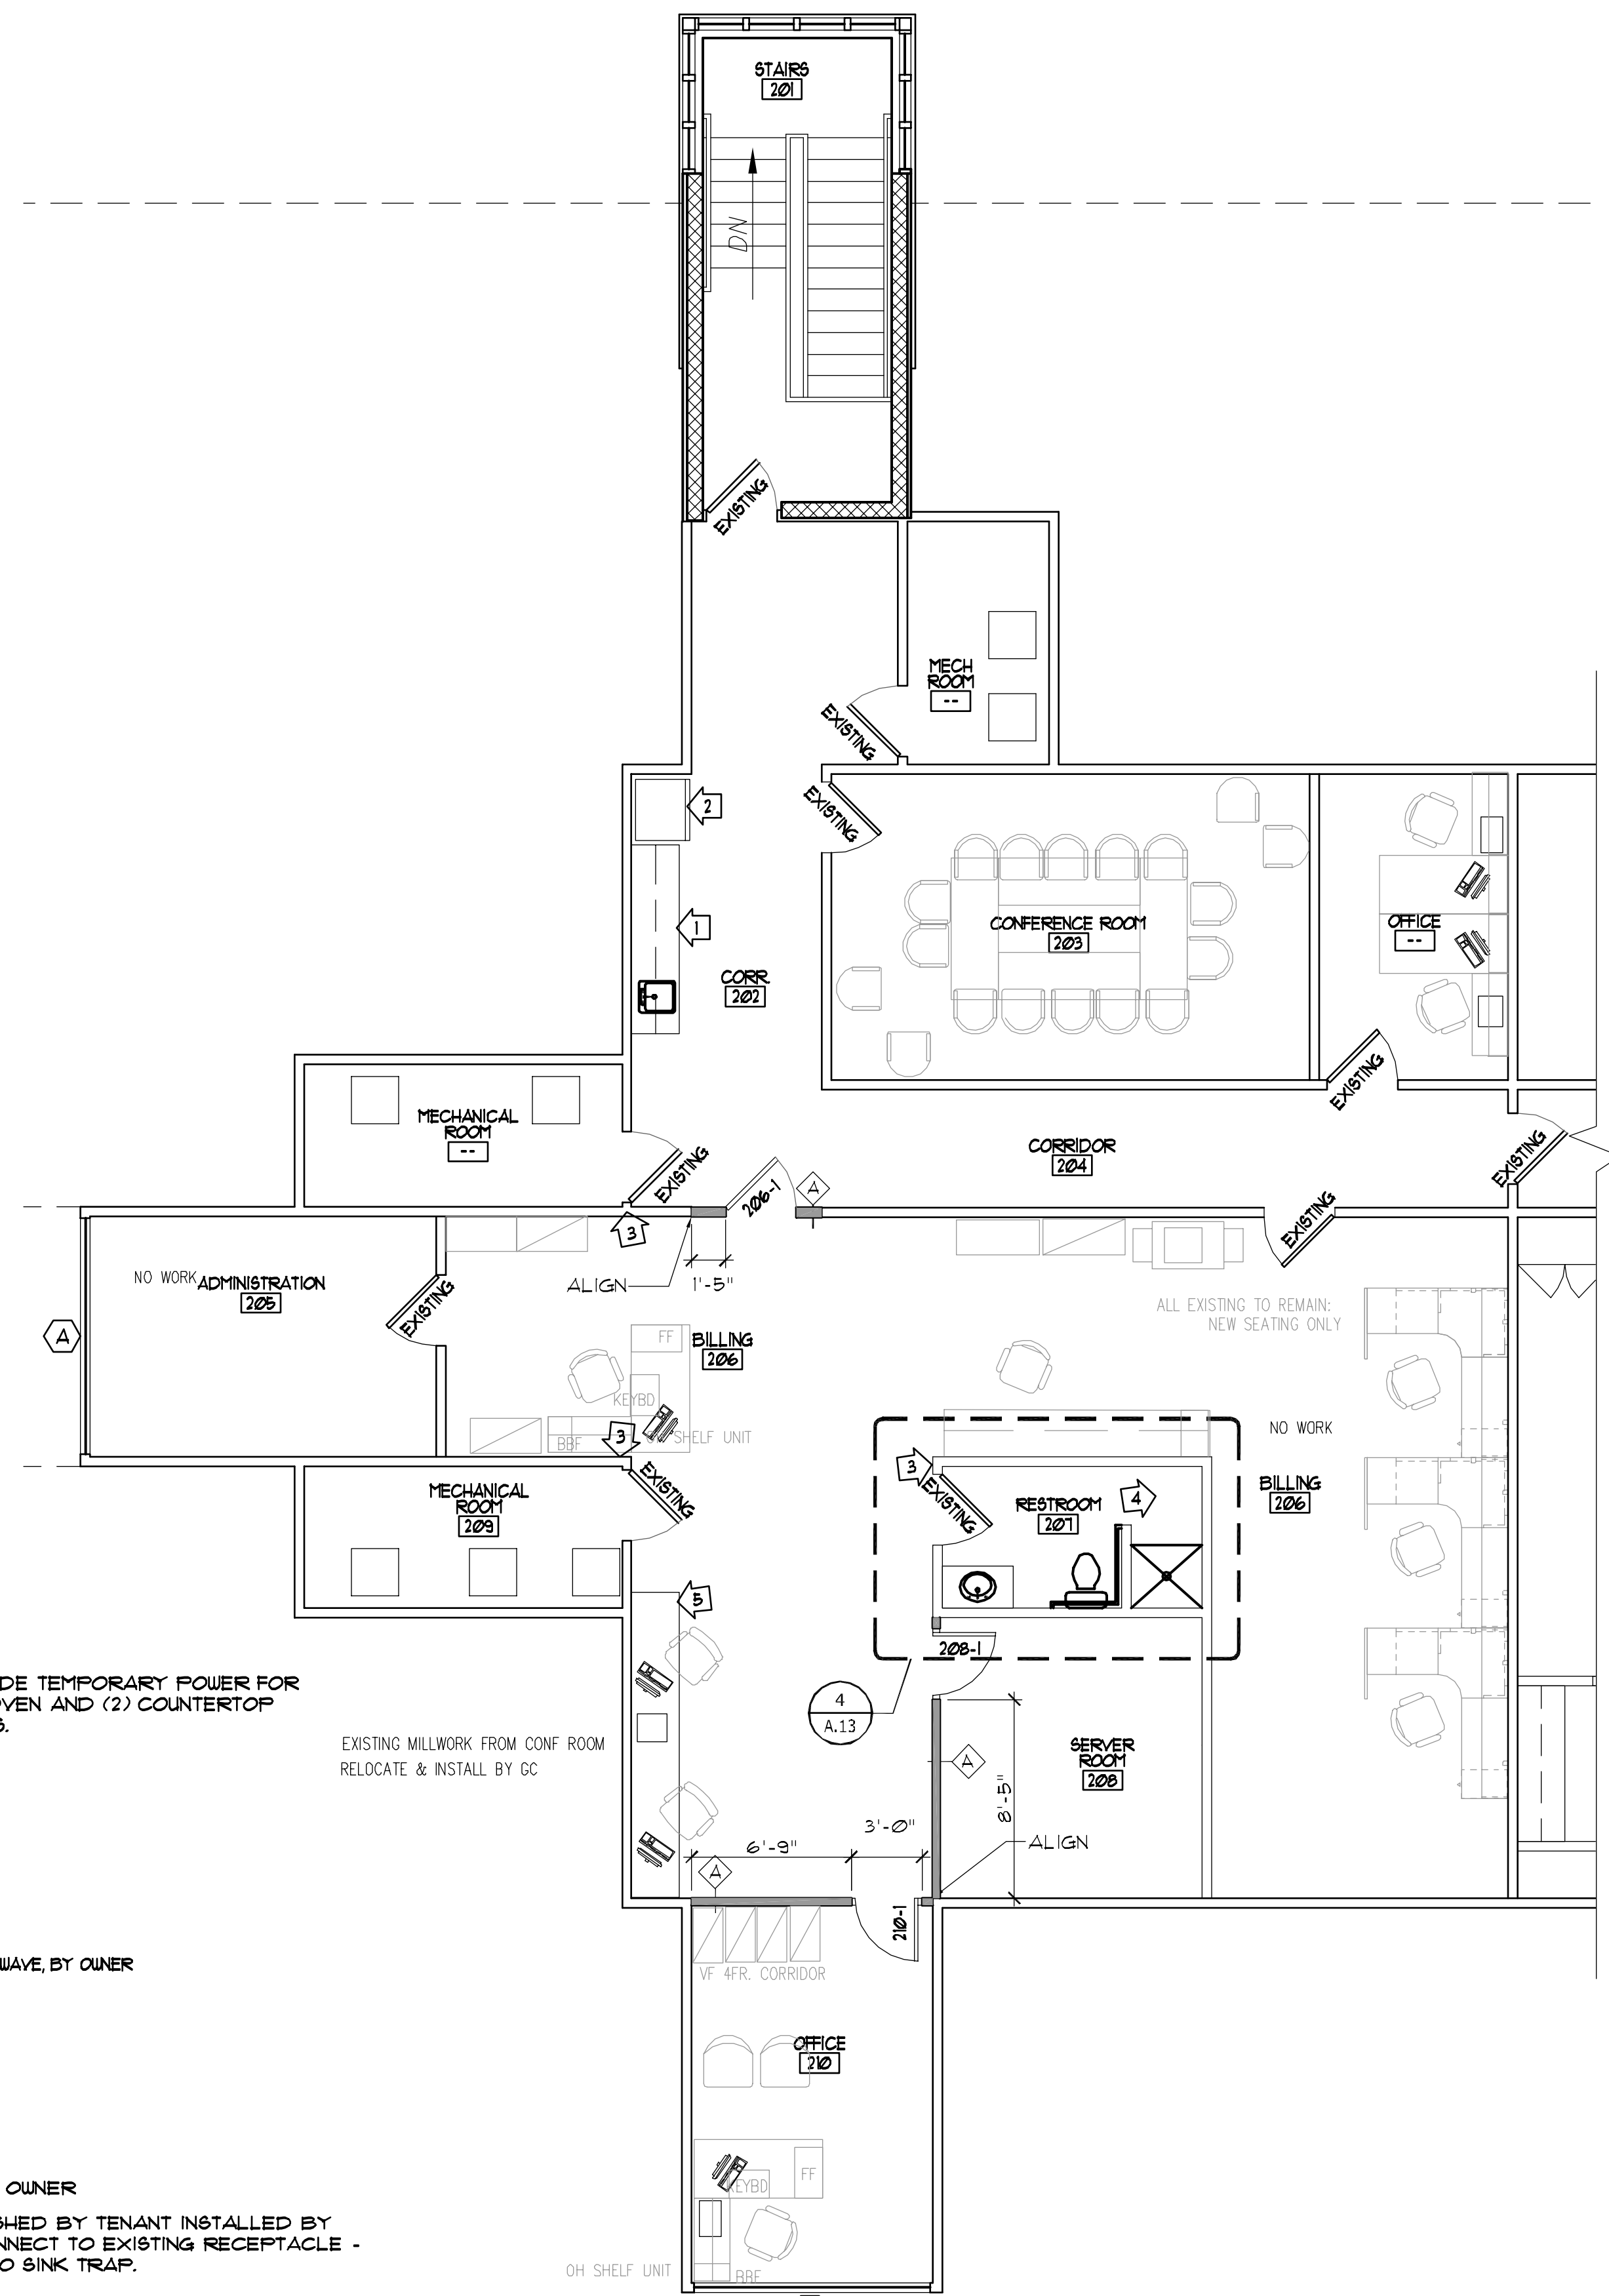
ROOM TAGS WITHOUT NUMBERS DENOTED THAT THESE ROOMS ARE TO REMAIN UNCHANGED.

- ### FLAG NOTES
- C.M. TO REINSTALL EXISTING KITCHENETTE & SALVAGED FROM BREAK ROOM. PLUMBING/ELECTRIC CONNECTION WORK REQUIRED - SEE DETAIL 1/A.6.
  - RELOCATED EXISTING REFRIGERATOR FROM FORMER KITCHENETTE.
  - REPAIR WALL WHERE PERPENDICULAR WALL WAS REMOVED.
  - EXISTING RESTROOM - REFER TO ROOM FINISH SCHEDULE.
  - COUNTERTOP AND CABINETS RELOCATED FROM CONFERENCE ROOM - SEE SHEET D.3.




**1 BREAK ROOM**  
A.6 SCALE: 3/16" = 1' - 0" 210

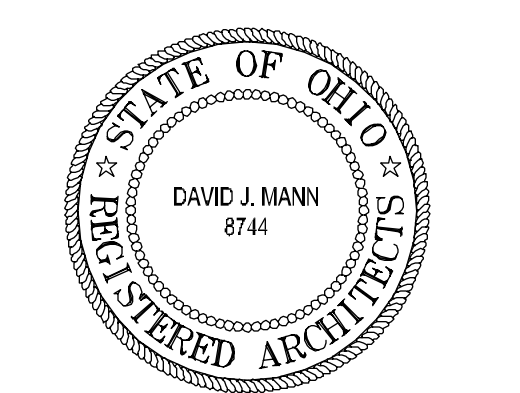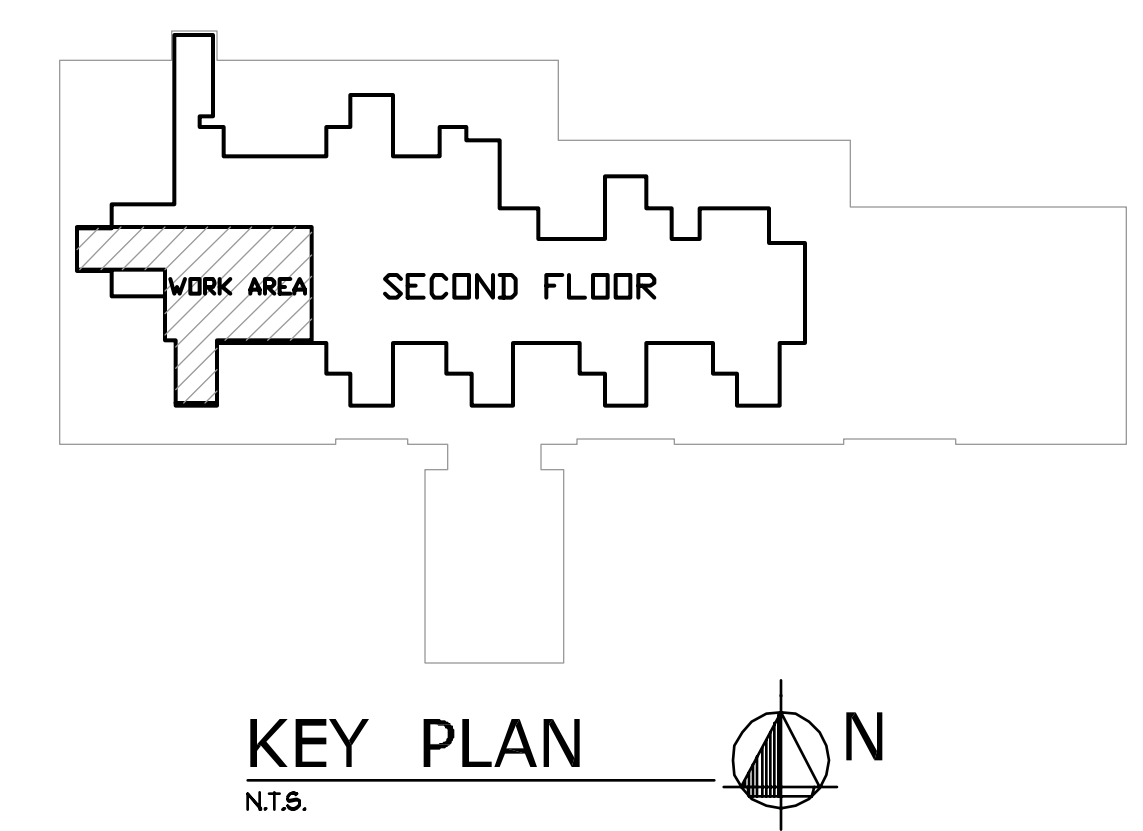**PARTIAL SECOND FLOOR PLAN**  
SCALE: 3/16" = 1' - 0"



revisions

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drawing  
**PARTIAL SECOND FLOOR PLAN**  
project no. 11406  
date OCTOBER 23, 2007  
scale AS NOTED  
project  
**COLUMBUS ONCOLOGY**  
JASONIWAY PROFESSIONAL BUILDING  
810 JASONIWAY AVENUE, SUITE A  
COLUMBUS, OHIO 43214-2329

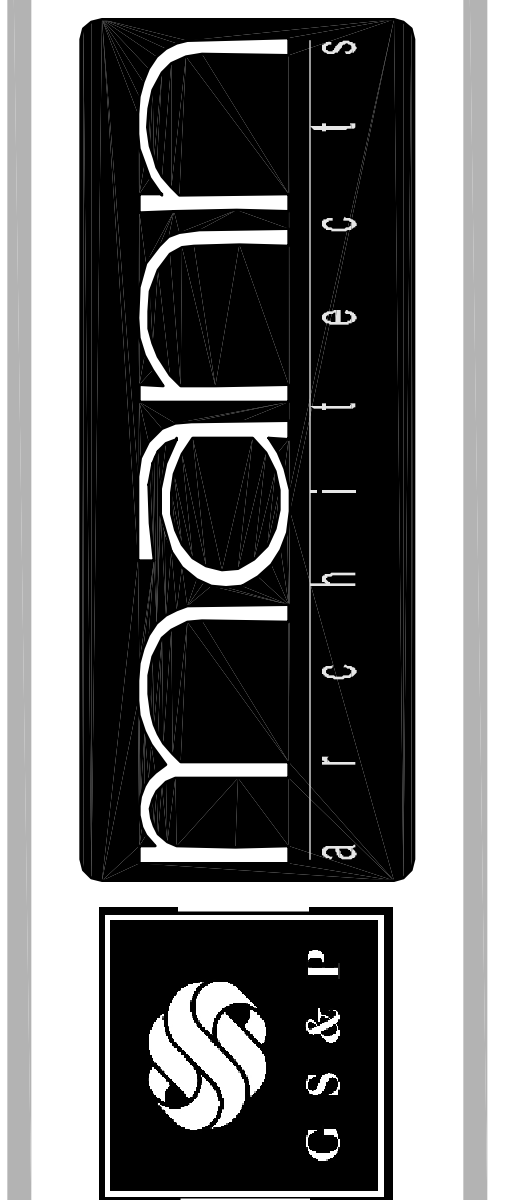**A.6**  
OF 18  
sheet no.

**ROOF TRUSSES**

ROOF TRUSSES SHALL BE FABRICATED AND PROPERLY STAMPED WITH IDENTIFICATION BY A TRUSS FABRICATOR APPROVED BY LOCAL MUNICIPAL BOARD OF BUILDING APPEALS OR OTHER GOVERNING AUTHORITIES.

DESIGN AND FABRICATION CRITERIA OF WOOD TRUSSES SHALL MEET NATIONAL DESIGN SPECIFICATIONS FOR STRESS GRADE LUMBER AND ITS FASTENINGS BY NATIONAL FOREST PRODUCTS ASSOCIATION, TIMBER CONSTRUCTION STANDARDS AND DESIGN SPECIFICATIONS FOR LIGHT METAL PLATE CONNECTED WOOD TRUSSES.

LUMBER USED FOR TRUSS MEMBERS SHALL CONFORM TO PUBLISHED STRESS RATINGS FOR SPECIES AND GRADES AS SET OUT IN THE OFFICIAL GRADING RULES OF APPROPRIATE LUMBER CONSTRUCTION.

TRUSS CONNECTOR PLATES SHALL BE MANUFACTURED FROM ONLY PRIME COMMERCIAL QUALITY GALVANIZED SHEET STEEL OF NO LESS THAN 20 GAUGE THICKNESS WHICH HAS A MINIMUM YIELD OF 33,000 PSI.

TRUSS MANUFACTURER SHALL PROVIDE THREE COPIES OF TRUSS DESIGNS, SEALED BY A PROFESSIONAL ENGINEER LICENSED IN THE STATE OF OHIO, TO THE LOCAL BUILDING DEPT. FOR REVIEW AND APPROVAL PRIOR TO FABRICATION.

FABRICATED TRUSSES AND SUBASSEMBLIES SHALL BE HANDLED WITH CARE SO THAT THEY ARE NOT SUBJECT TO DAMAGE. IF THE TRUSSES ARE TO BE STOCKPILED OR SORTED PRIOR TO ERECTION, THEY SHALL BE SET IN VERTICAL POSITIONS, RESTING UPON TEMPORARY BEARING SUPPORTS AND BRACED SO THAT THEY WILL BE SUBJECTED TO NO UNUSUAL BENDING OR TIPPING OVER.

ALL TRUSS MEMBERS SHALL BE ACCURATELY CUT TO KEEP HORIZONTAL BENDING OF TRUSSES TO A MINIMUM.

TO ENSURE THE OVERALL RIGIDITY OF THE ROOF SYSTEM, THE PERMANENT STRUCTURAL CROSS-BRACING SHALL BE IN ACCORDANCE WITH THE TRUSS MANUFACTURER SPECIFICATIONS.

PROPER ERECTION BRACING SHALL BE INSTALLED TO HOLD THE TRUSSES TRUE AND PLUMB AND IN SAFE CONDITION UNTIL PERMANENT TRUSS BRACING AND BRIDGING CAN BE SOLIDLY NAILED IN PLACE TO FORM A STRUCTURALLY SOUND ROOF FRAMING SYSTEM. ALL ERECTION AND PERMANENT BRACING SHALL BE INSTALLED AND ALL COMPONENTS PERMANENTLY FASTENED BEFORE APPLICATION OF ANY LOADS.

FIELD ERECTION OF TRUSSES, INCLUDING ITEMS SUCH AS PROPER HANDLING, SAFETY PRECAUTIONS, TEMPORARY BRACING TO PREVENT TOPPLING OR DOWNING OF TRUSSES DURING ERECTION, AND ANY OTHER SAFEGUARDS OR PROCEDURES CONSISTENT WITH GOOD WORKMANSHIP AND GOOD BUILDING PRACTICES SHALL BE THE RESPONSIBILITY OF THE ERECTION CONTRACTOR.

ALL HANDLING, INSTALLATION AND BRACING SHALL BE IN ACCORDANCE WITH CURRENT TPI (TRUSS PLATE INSTITUTE) RECOMMENDATIONS.

DURING THE ENTIRE CONSTRUCTION PERIOD, ALL CONTRACTORS SHALL PROVIDE MEANS FOR ADEQUATE DISTRIBUTION OF CONCENTRATED LOADS SO THAT THE CARRYING CAPACITY OF ANY ONE TRUSS AND / OR OTHER COMPONENT IS NOT EXCEEDED.

**TRUSS BRACING**  
PROVIDE PERMANENT AND TEMPORARY BRIDGING / BRACING AS REQUIRED BY TRUSS MANUFACTURER SPECIFICATIONS.

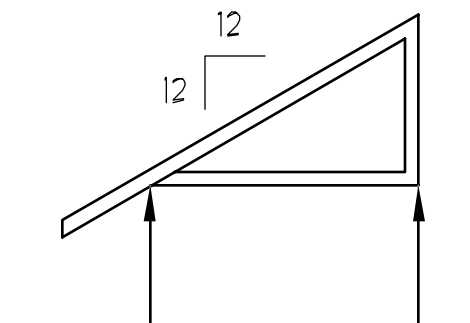
**DRAFT STOPPING**  
PROVIDE SOFFIT DRAFT STOPPING AND FIRE STOPPING EVERY 20' O.C.

**ROOF TRUSS NOTE:**


TRUSS MANUFACTURER SHALL PROVIDE AND SUBMIT ENGINEER SEALED DRAWINGS IN SHOP DUG FORMAT TO THE GOVERNING BUILDING DEPARTMENT FOR REVIEW AND APPROVAL.

**ROOF DESIGN LOADS:**


LIVE LOAD	25 P.S.F.
DEAD LOAD	10 P.S.F.
TOP CHORD	10 P.S.F.
BOT. CHORD	10 P.S.F.
TOTAL LOAD	45 P.S.F.




TRUSS TYPE - T4

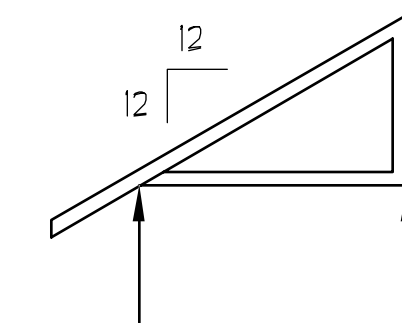


TRUSS GIRDER - TG5

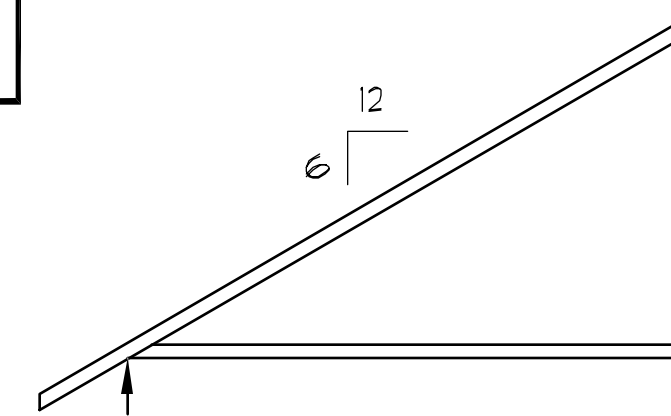


TRUSS TYPE - T3

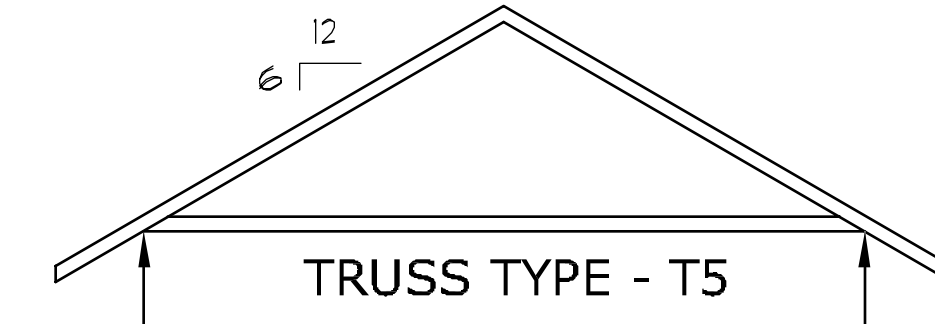

TRUSS TYPE - T5

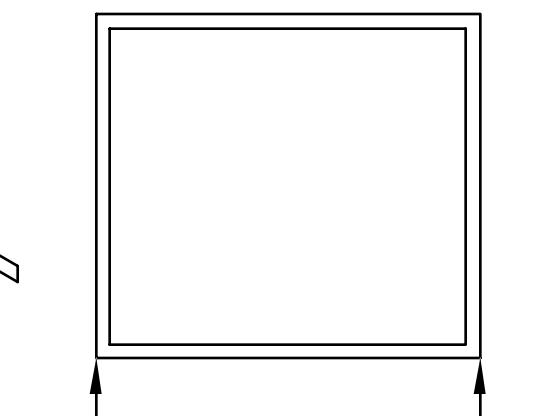


TRUSS GIRDER - TG2

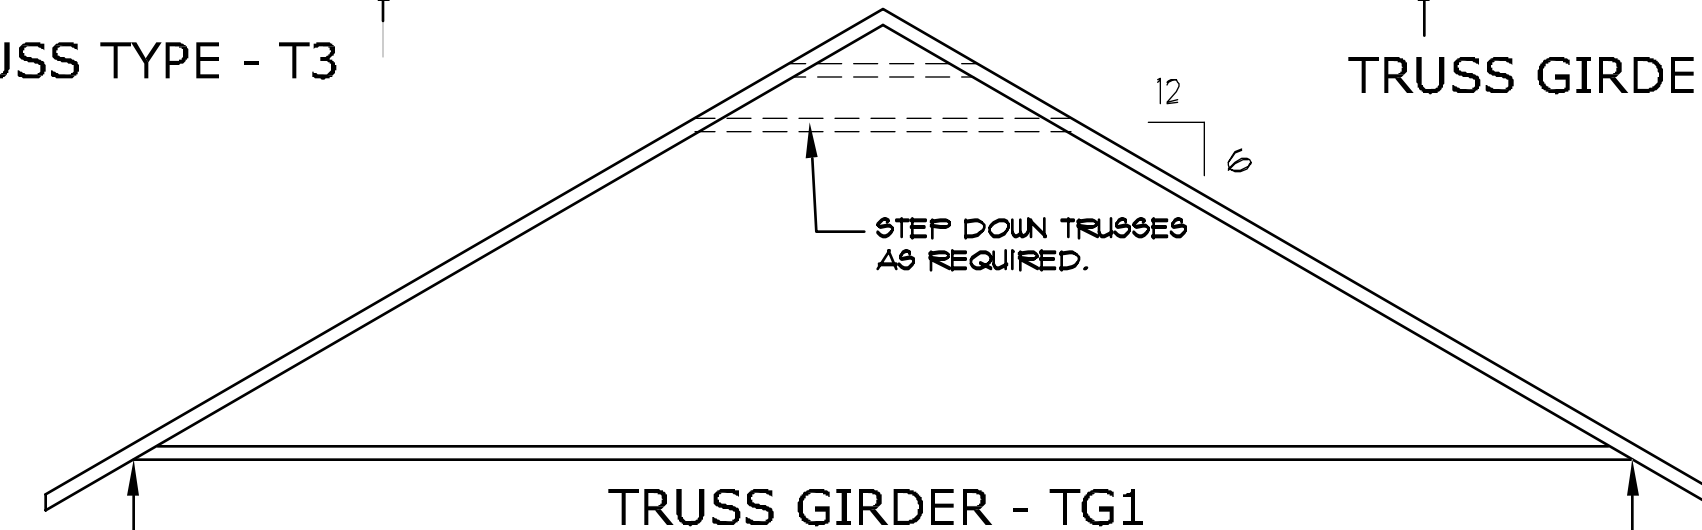


TRUSS GIRDER - TG1

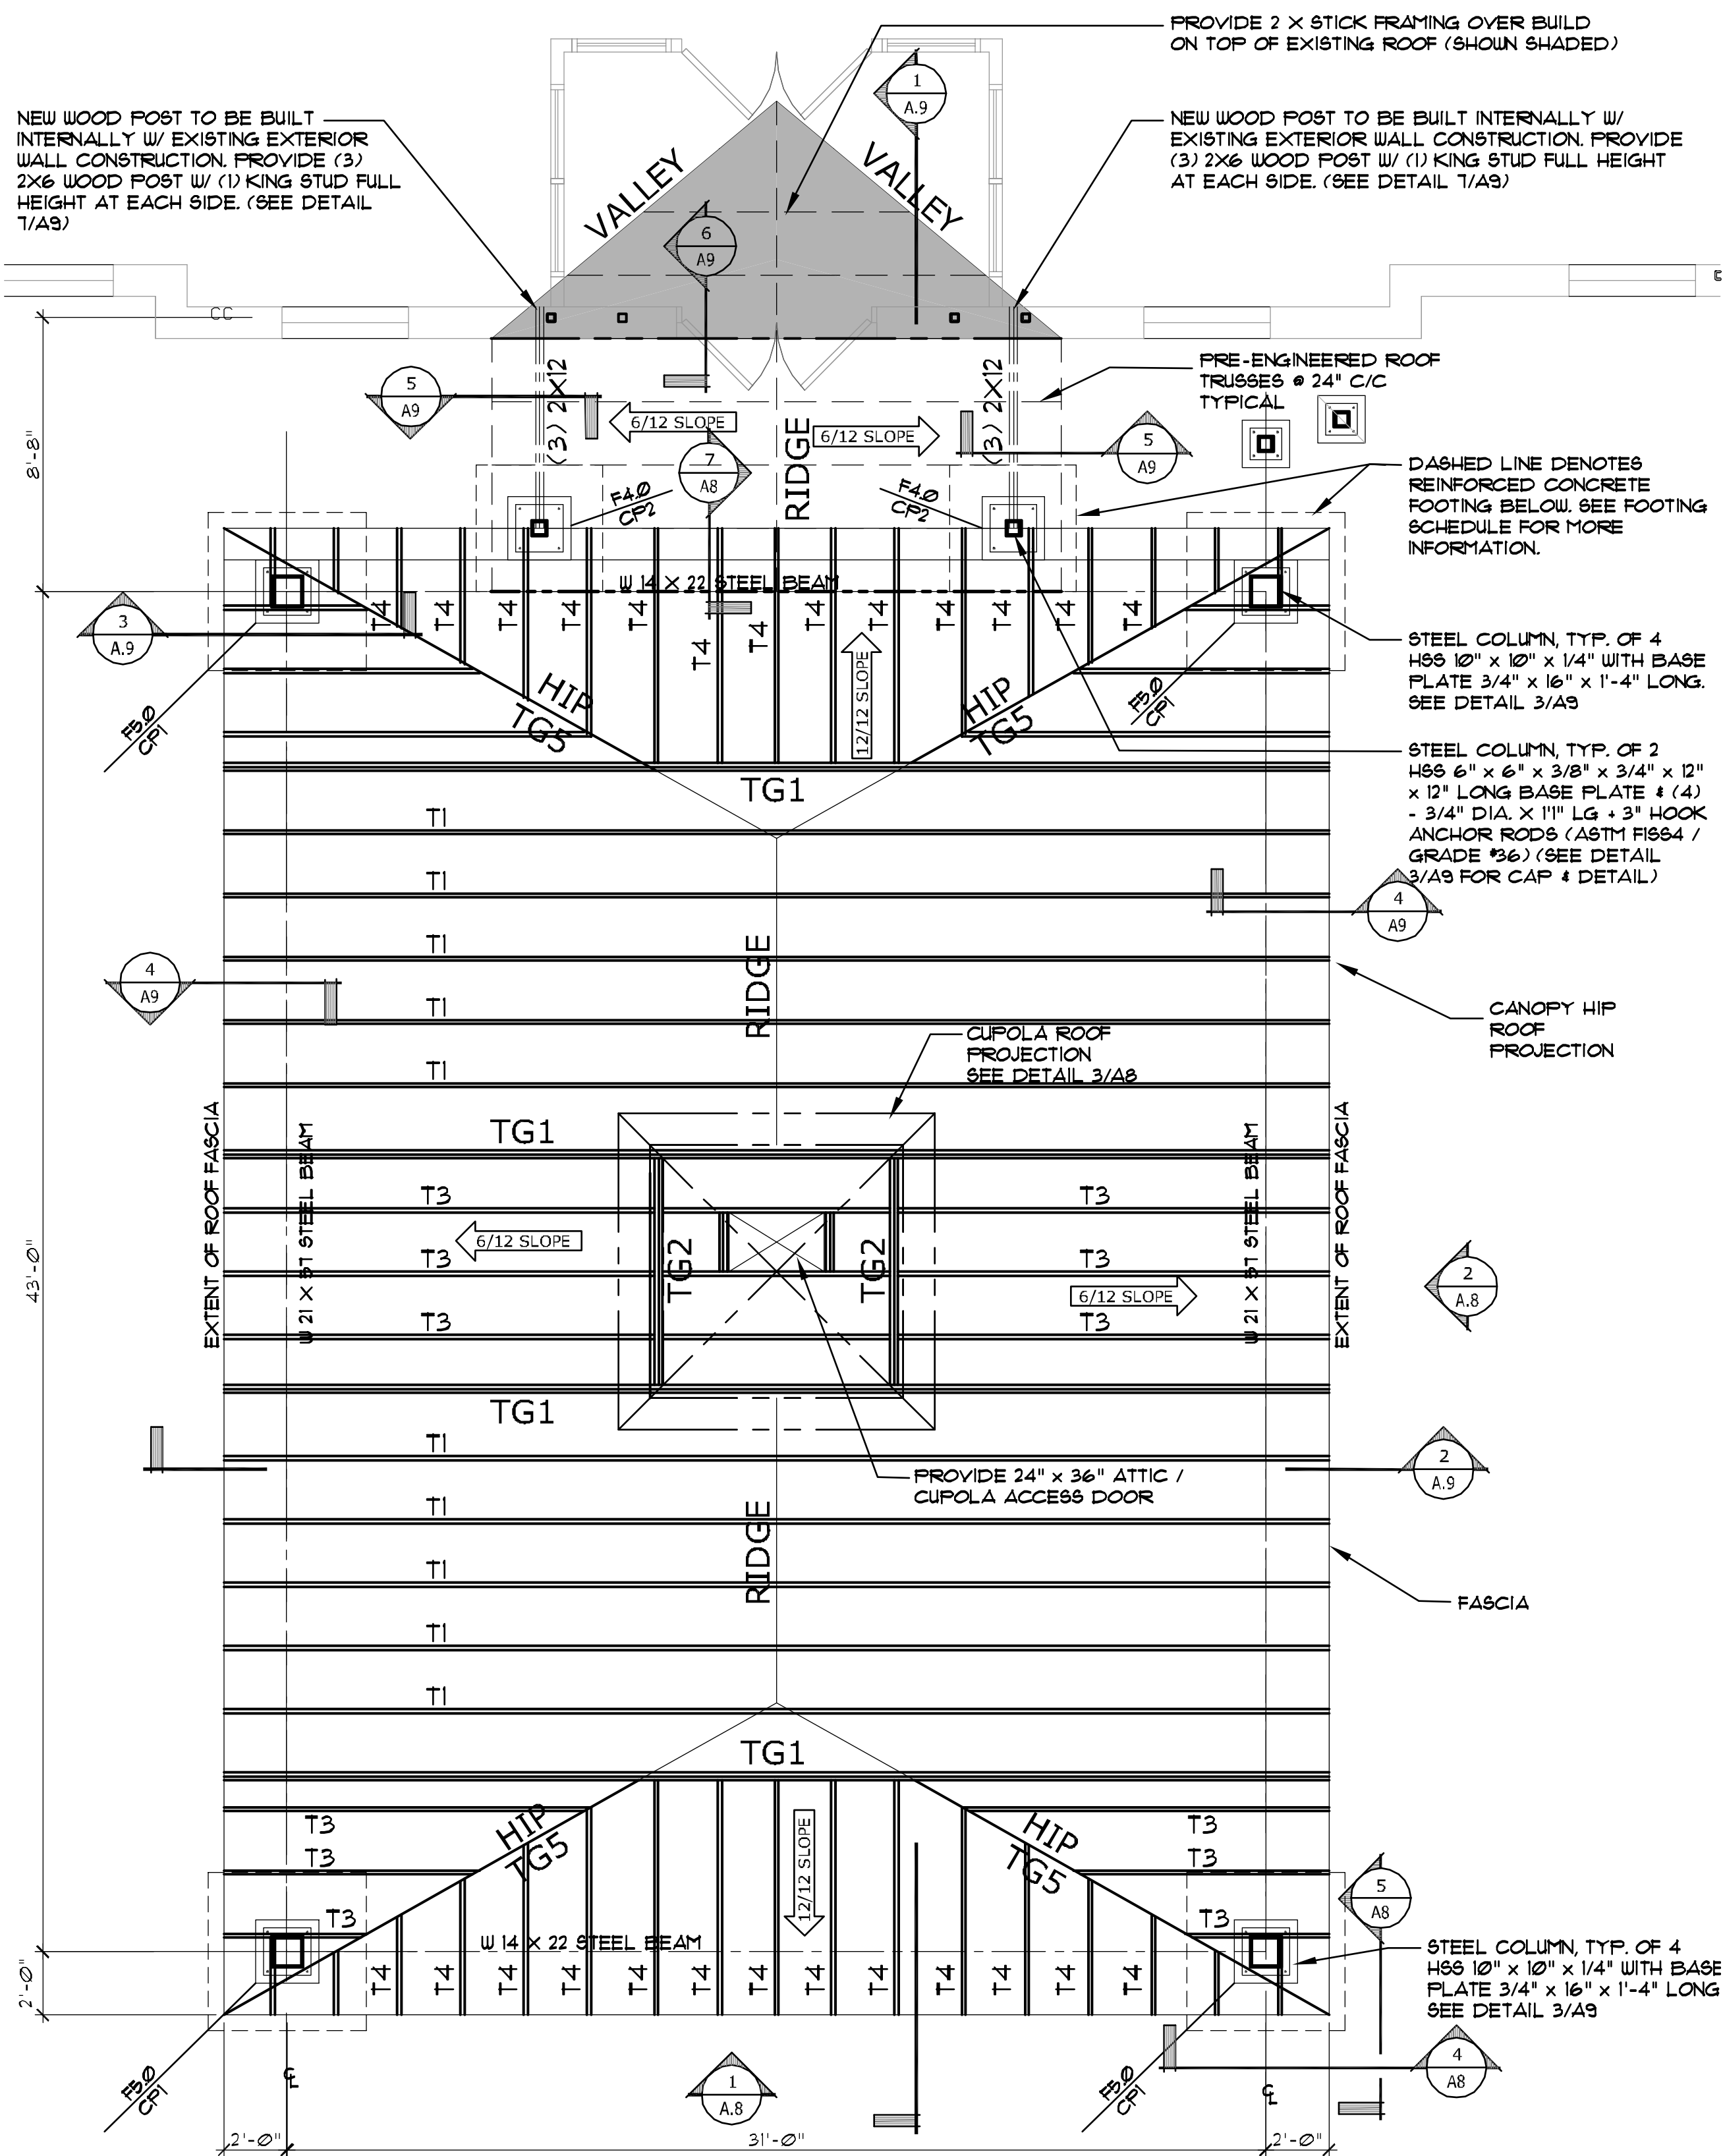
STEP DOWN TRUSSES AS REQUIRED.



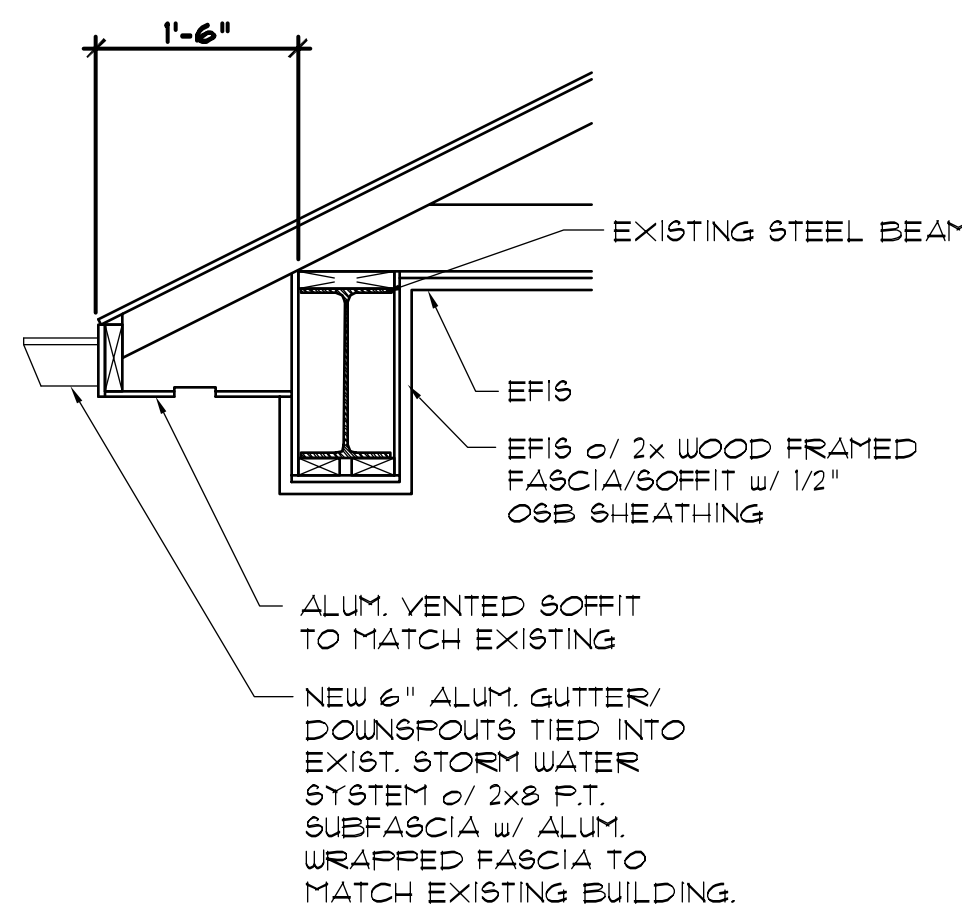
**FOUNDATION / CANOPY ROOF FRAMING PLAN**  
SCALE: 1/4" = 1'-0"



**1 SECTION**  
A7 SCALE: 3/4" = 1'-0"

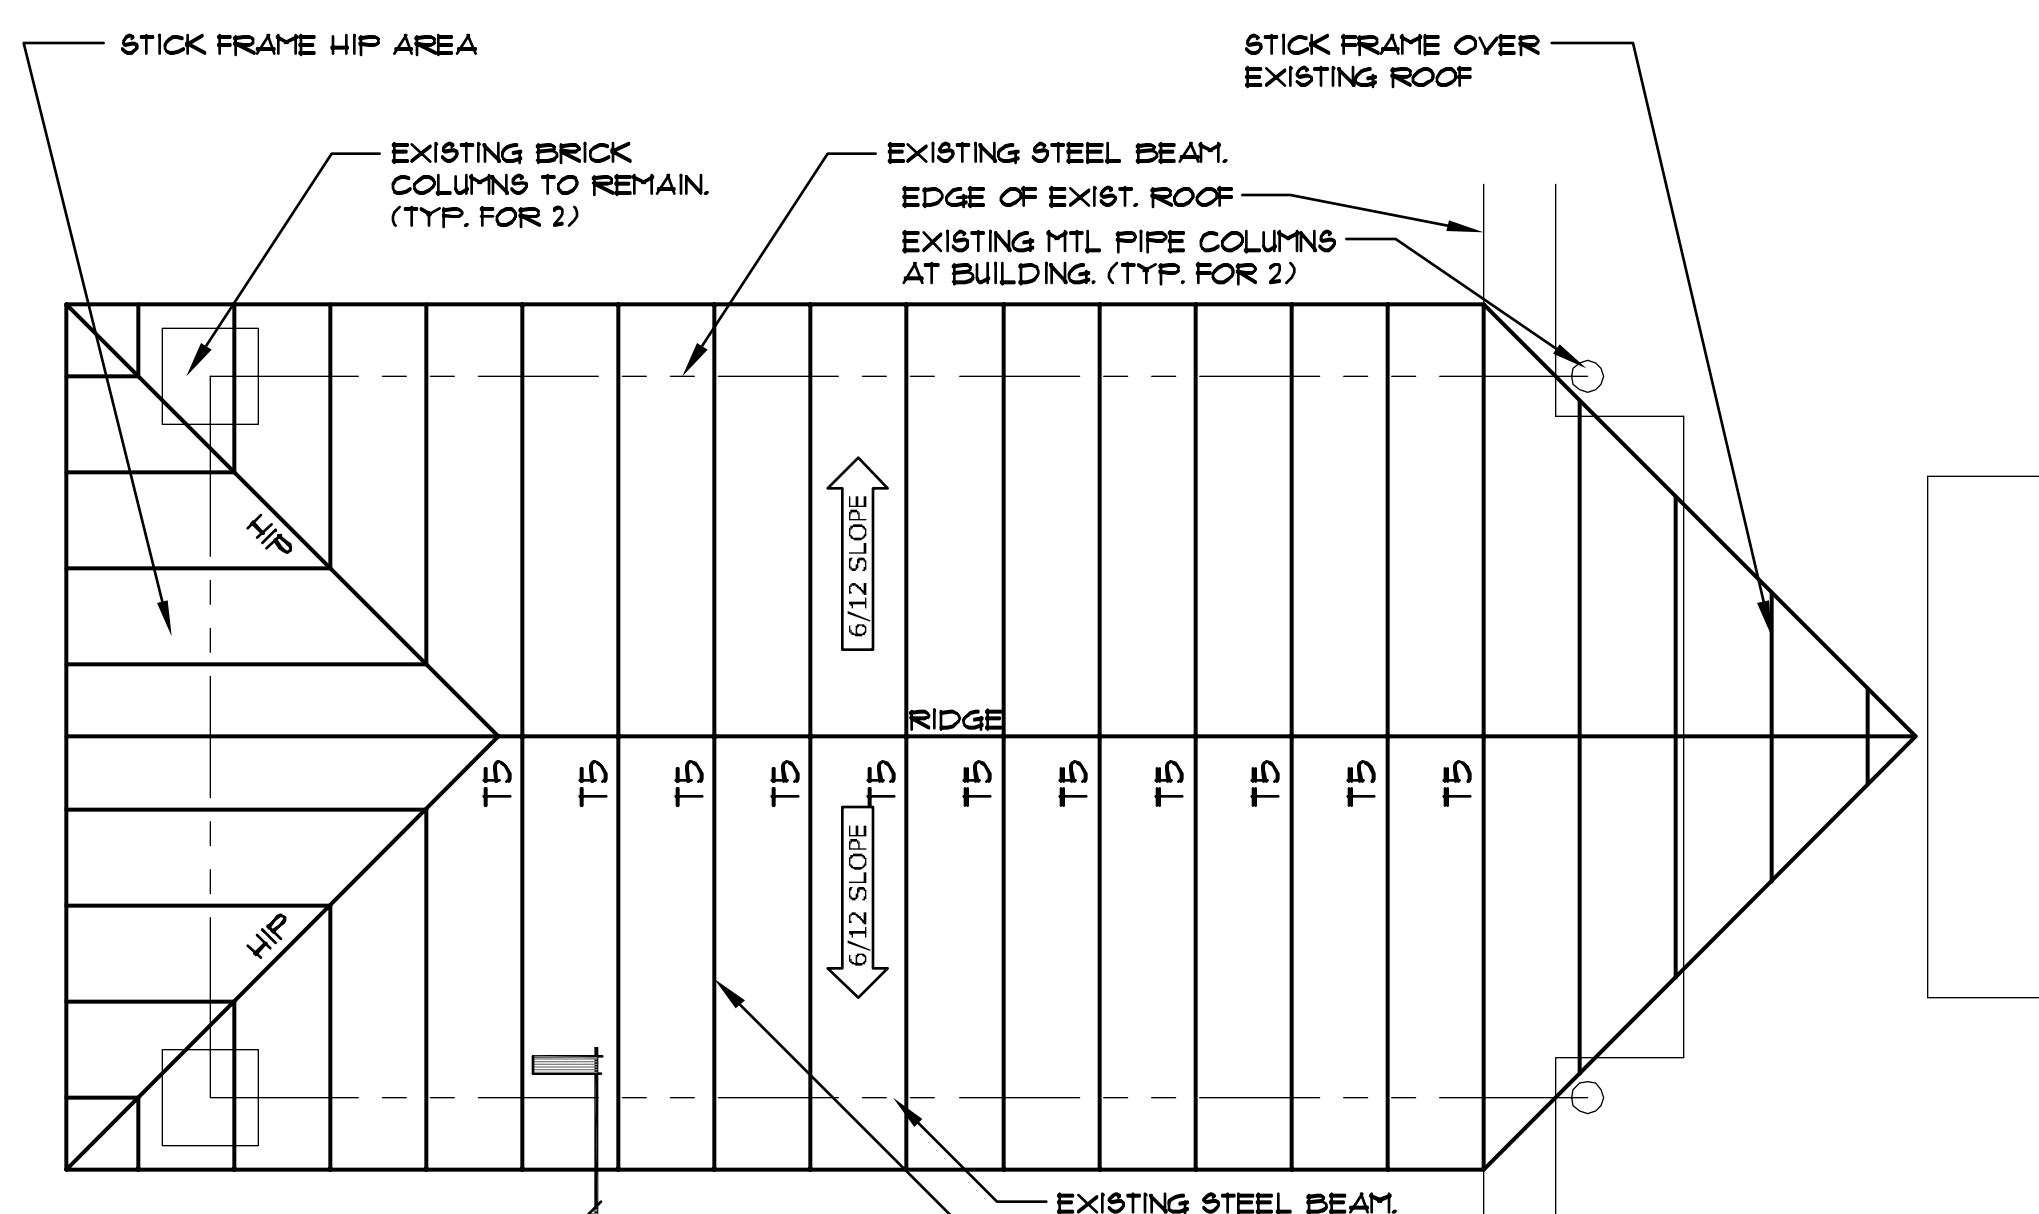


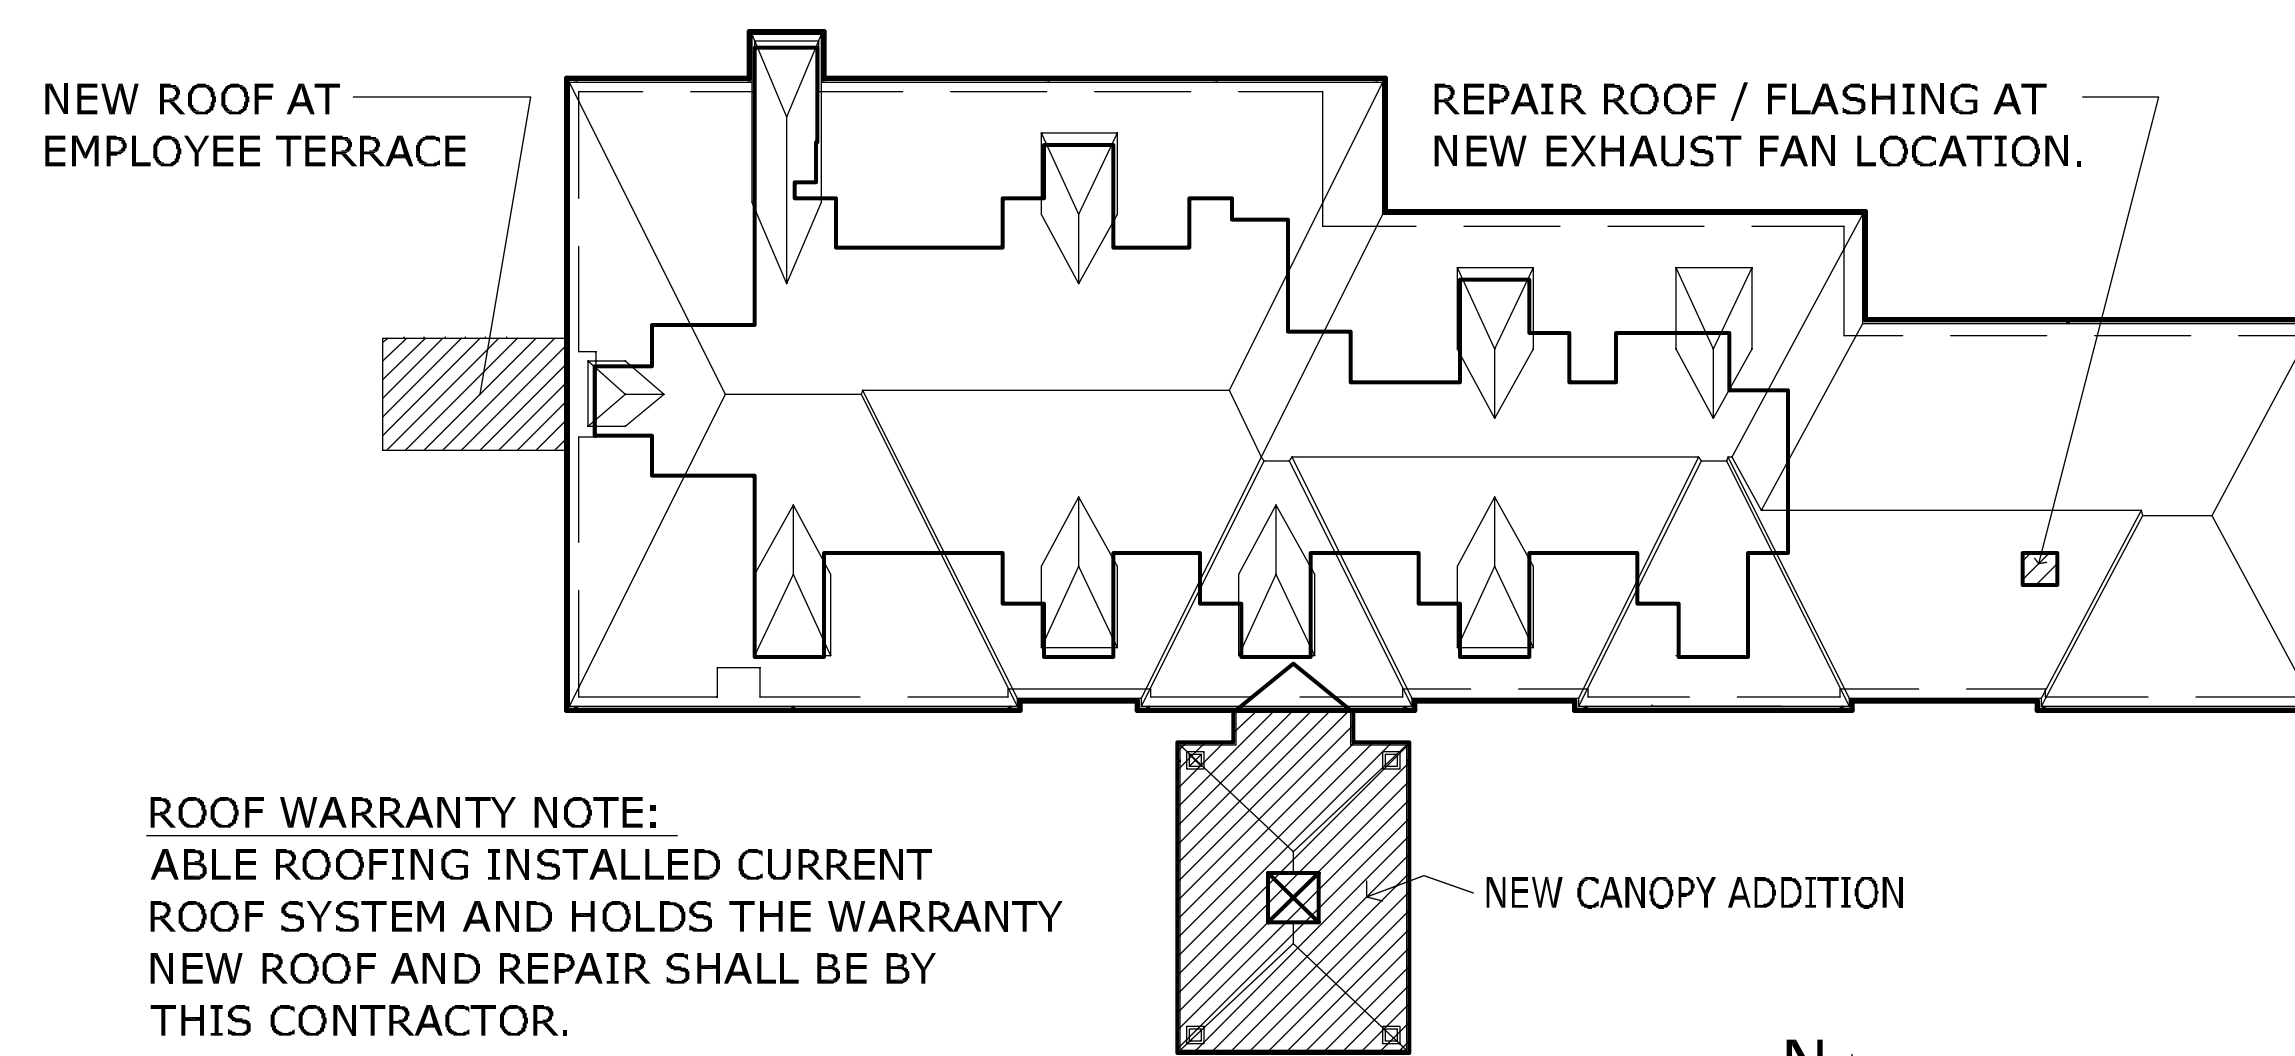**EMPLOYEE TERRACE ROOF PLAN**  
SCALE: 1/4" = 1'-0"




**ROOF WARRANTY NOTE:**  
ABLE ROOFING INSTALLED CURRENT ROOF SYSTEM AND HOLDS THE WARRANTY NEW ROOF AND REPAIR SHALL BE BY THIS CONTRACTOR.

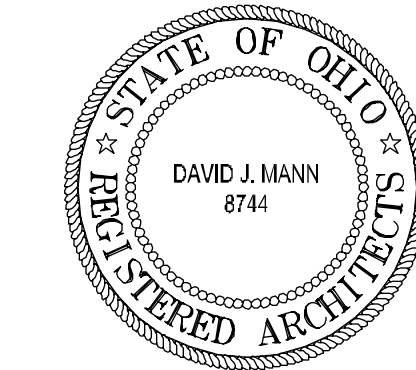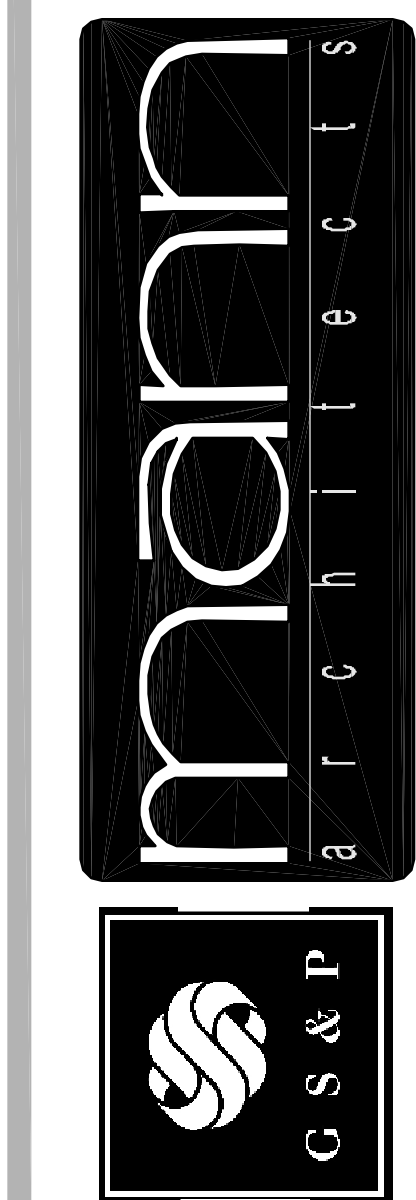**ROOF KEY PLAN**  
SCALE: N.T.S.



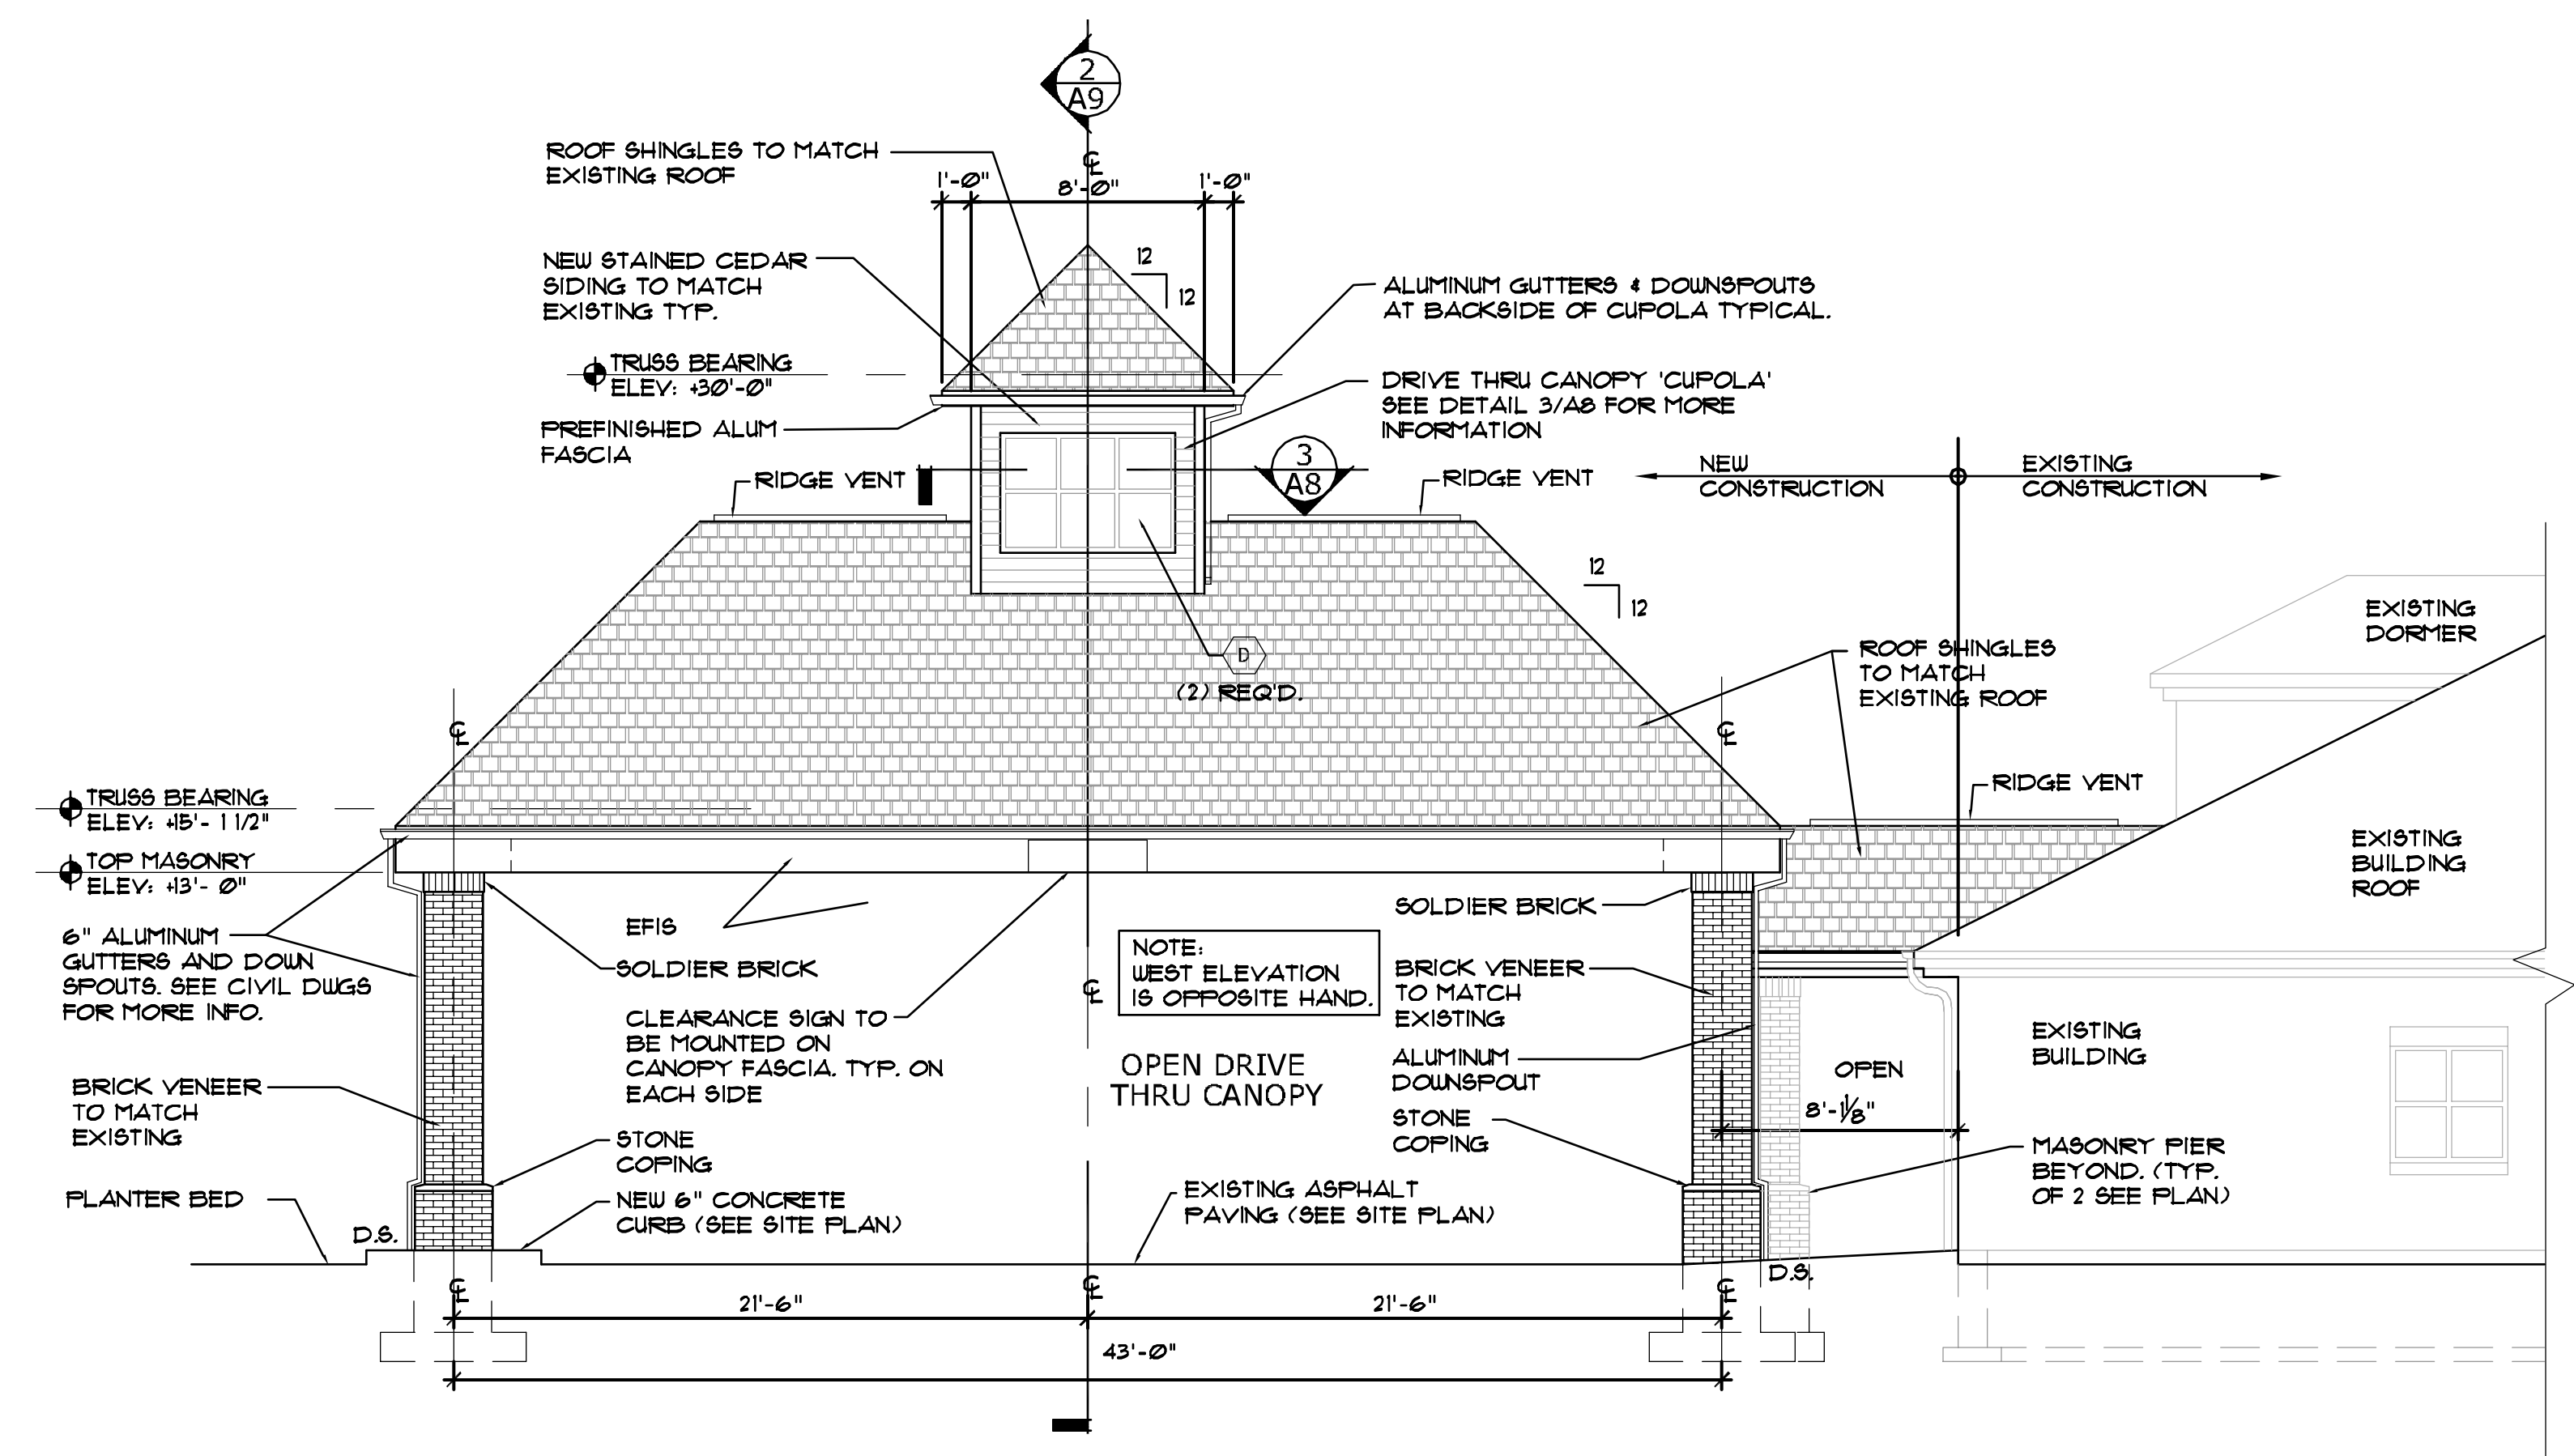
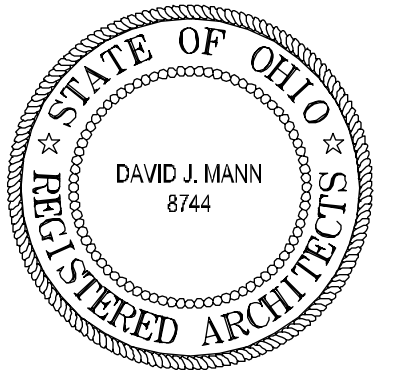
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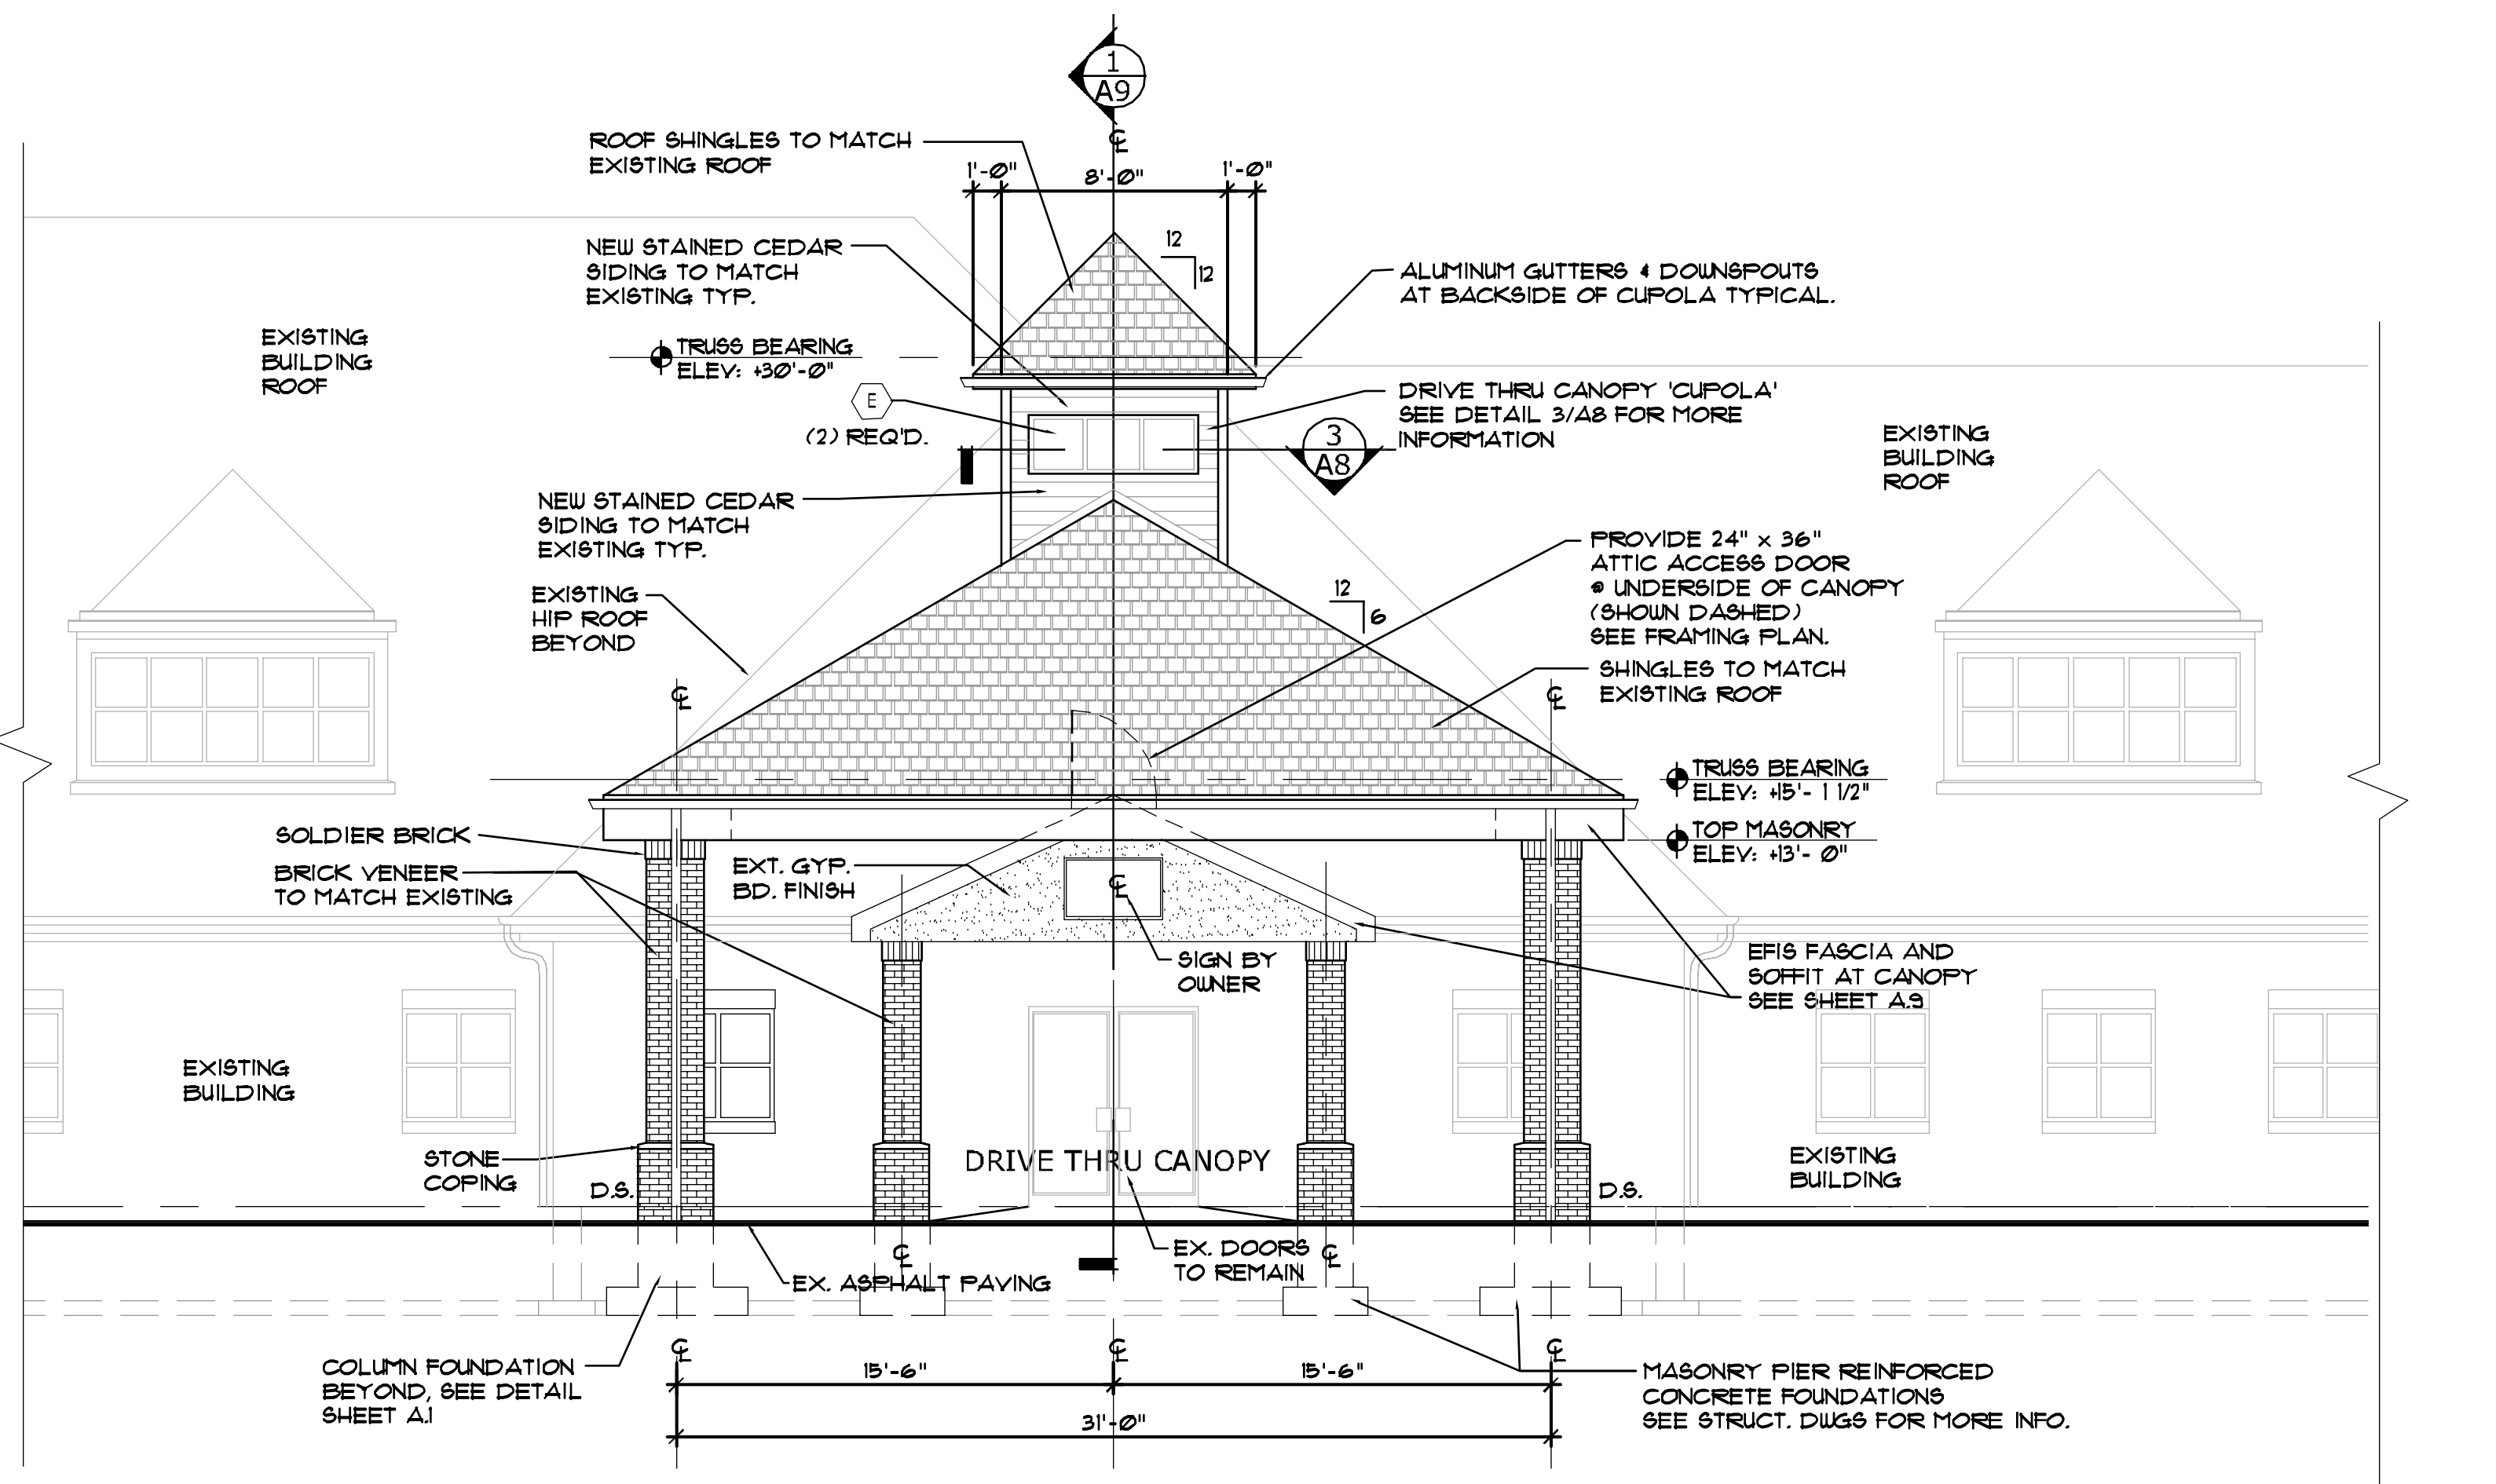


drawing CANOPY ROOF PLAN  
project no. 11406  
date OCTOBER 23, 2007  
scale AS NOTED  
COLUMBUS ONCOLOGY  
JASONWAY PROFESSIONAL BUILDING  
810 JASONWAY AVENUE SUITE A  
COLUMBUS, OHIO 43214-2329

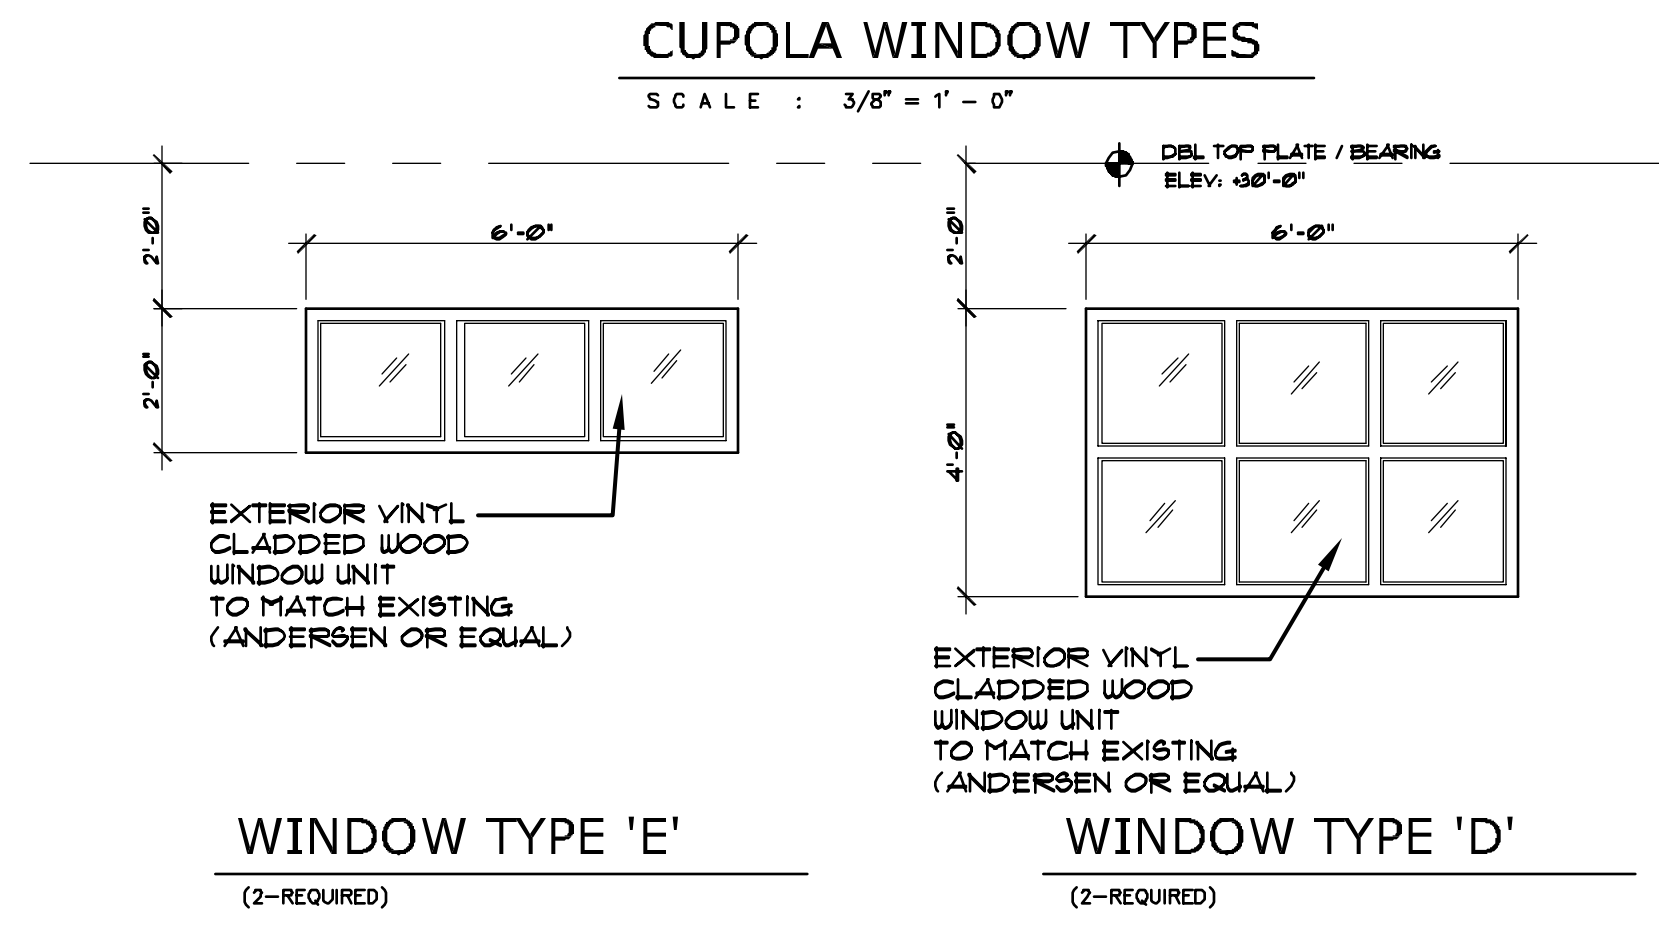
**A.7**  
OF 18  
sheet no.




**2 EAST CANOPY ELEVATION**  
 A.8 SCALE: 3/16" = 1'-0" 100




**1 SOUTH CANOPY ELEVATION**  
 A.8 SCALE: 3/16" = 1'-0" 100



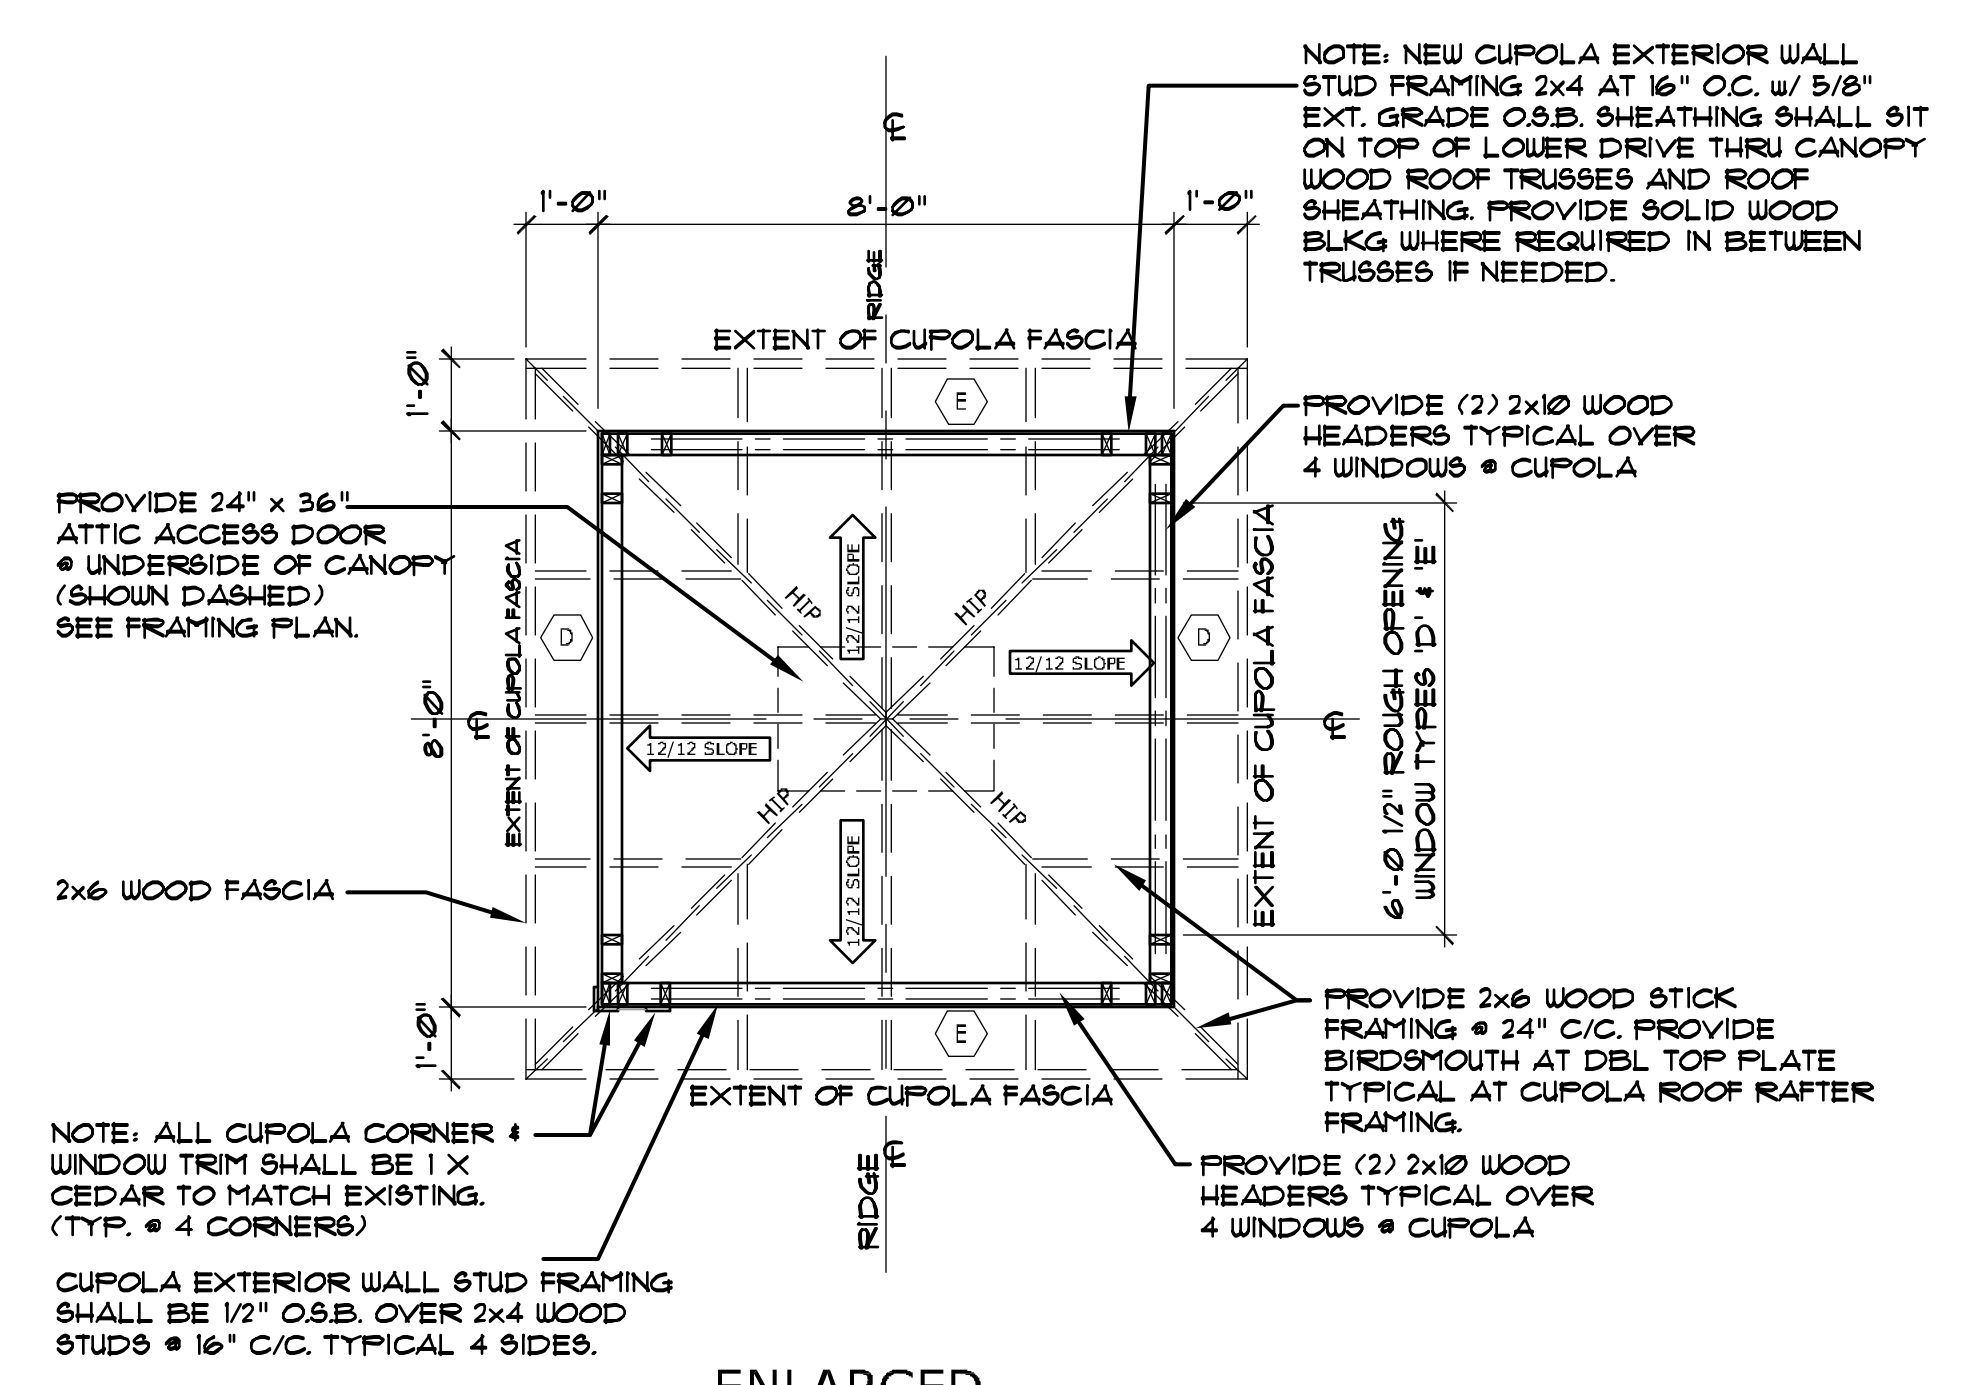**CUPOLA WINDOW TYPES**  
 SCALE: 3/8" = 1'-0"  
 WINDOW TYPE 'E' (2-REQUIRED)  
 WINDOW TYPE 'D' (2-REQUIRED)




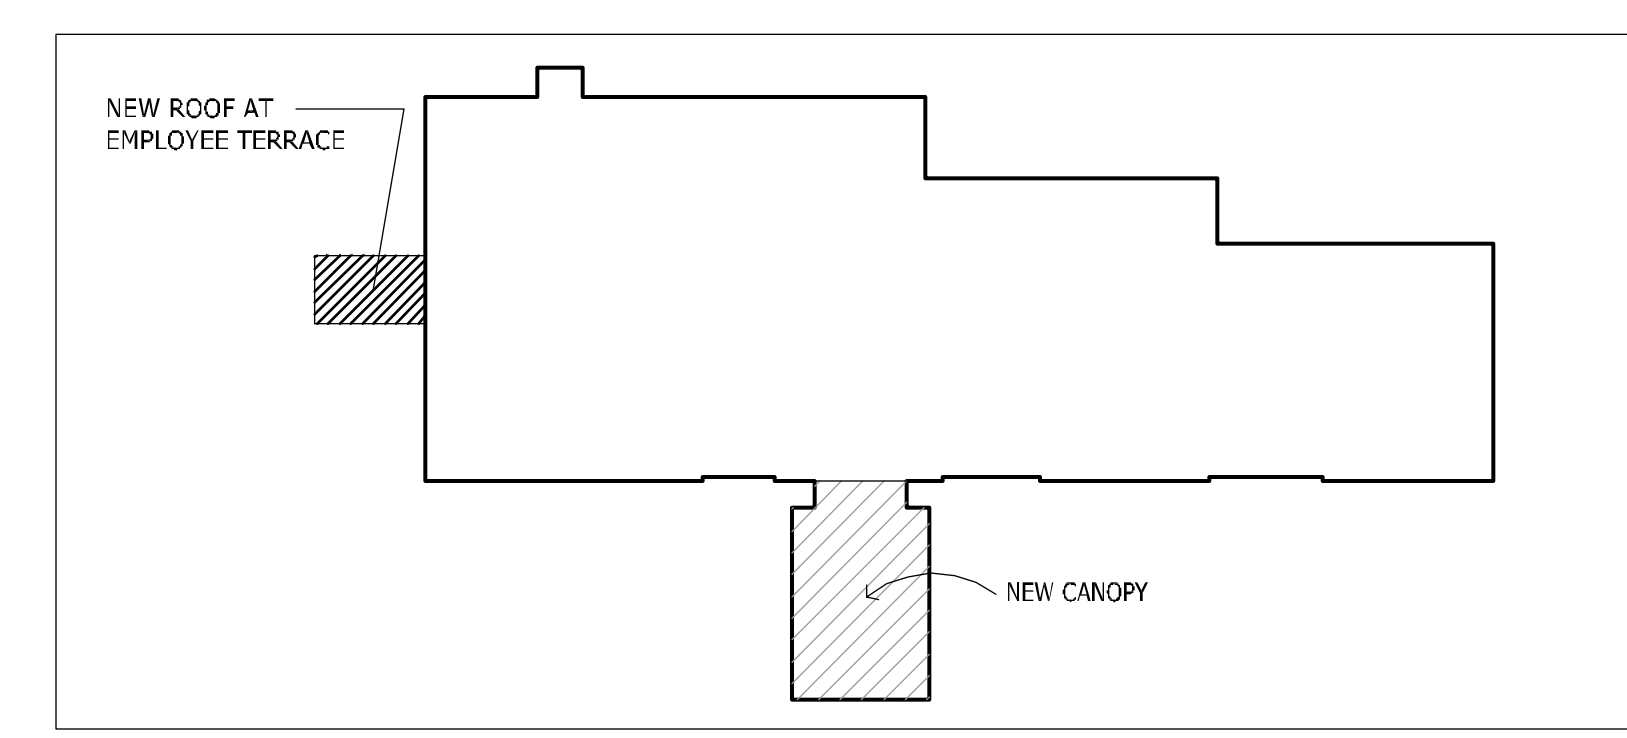
**3 ENLARGED CUPOLA PLAN DETAIL**  
 A.8 SCALE: 3/8" = 1'-0"



**KEY PLAN**  
 N.T.S.

revisions










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drawing ELEVATIONS  
 CANOPY project no. 11406  
 date OCTOBER 23, 2001  
 scale AS NOTED  
 project COLUMBUS ONCOLOGY  
 JASONWAY PROFESSIONAL BUILDING  
 810 JASONWAY AVENUE SUITE A  
 COLUMBUS, OHIO 43214-2329

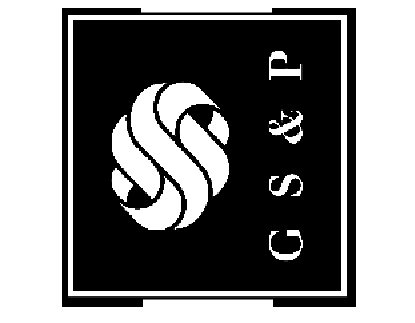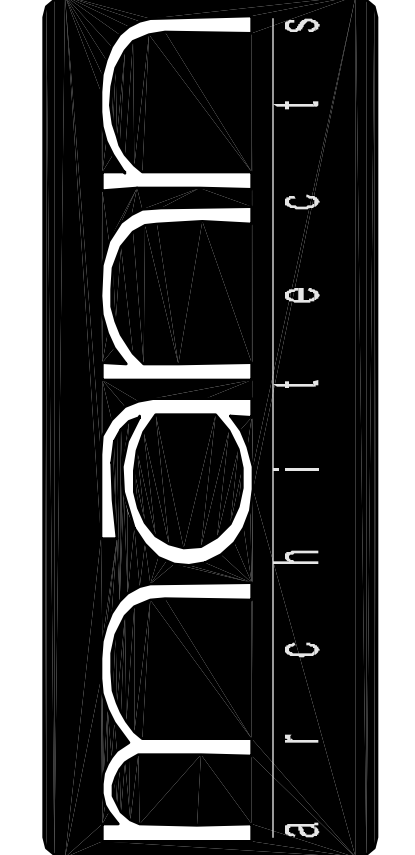
**A.8**  
 OF 18  
 sheet no.

FOOTING SCHEDULE	
<b>F4.0 / FOOTING</b>	<b>F5.0 / FOOTING</b>
4'-0" WIDE x 4'-0" LONG x 1'-0" REINFORCED WITH (5) - #5 BARS EACHWAY ON BOTTOM	5'-0" WIDE x 5'-0" LONG x 1'-0" REINFORCED WITH (6) - #6 BARS EACHWAY ON BOTTOM
NOTE: BOTTOM OF ALL FOOTINGS SHALL BE -3'-6" BELOW ADJACENT FINAL GRADE FOR FROST.	



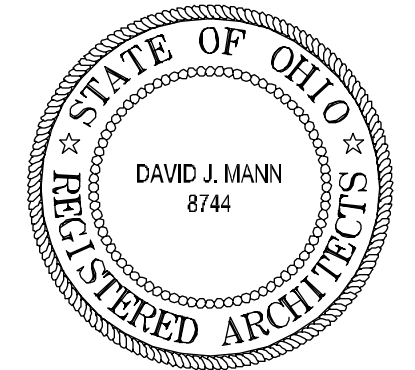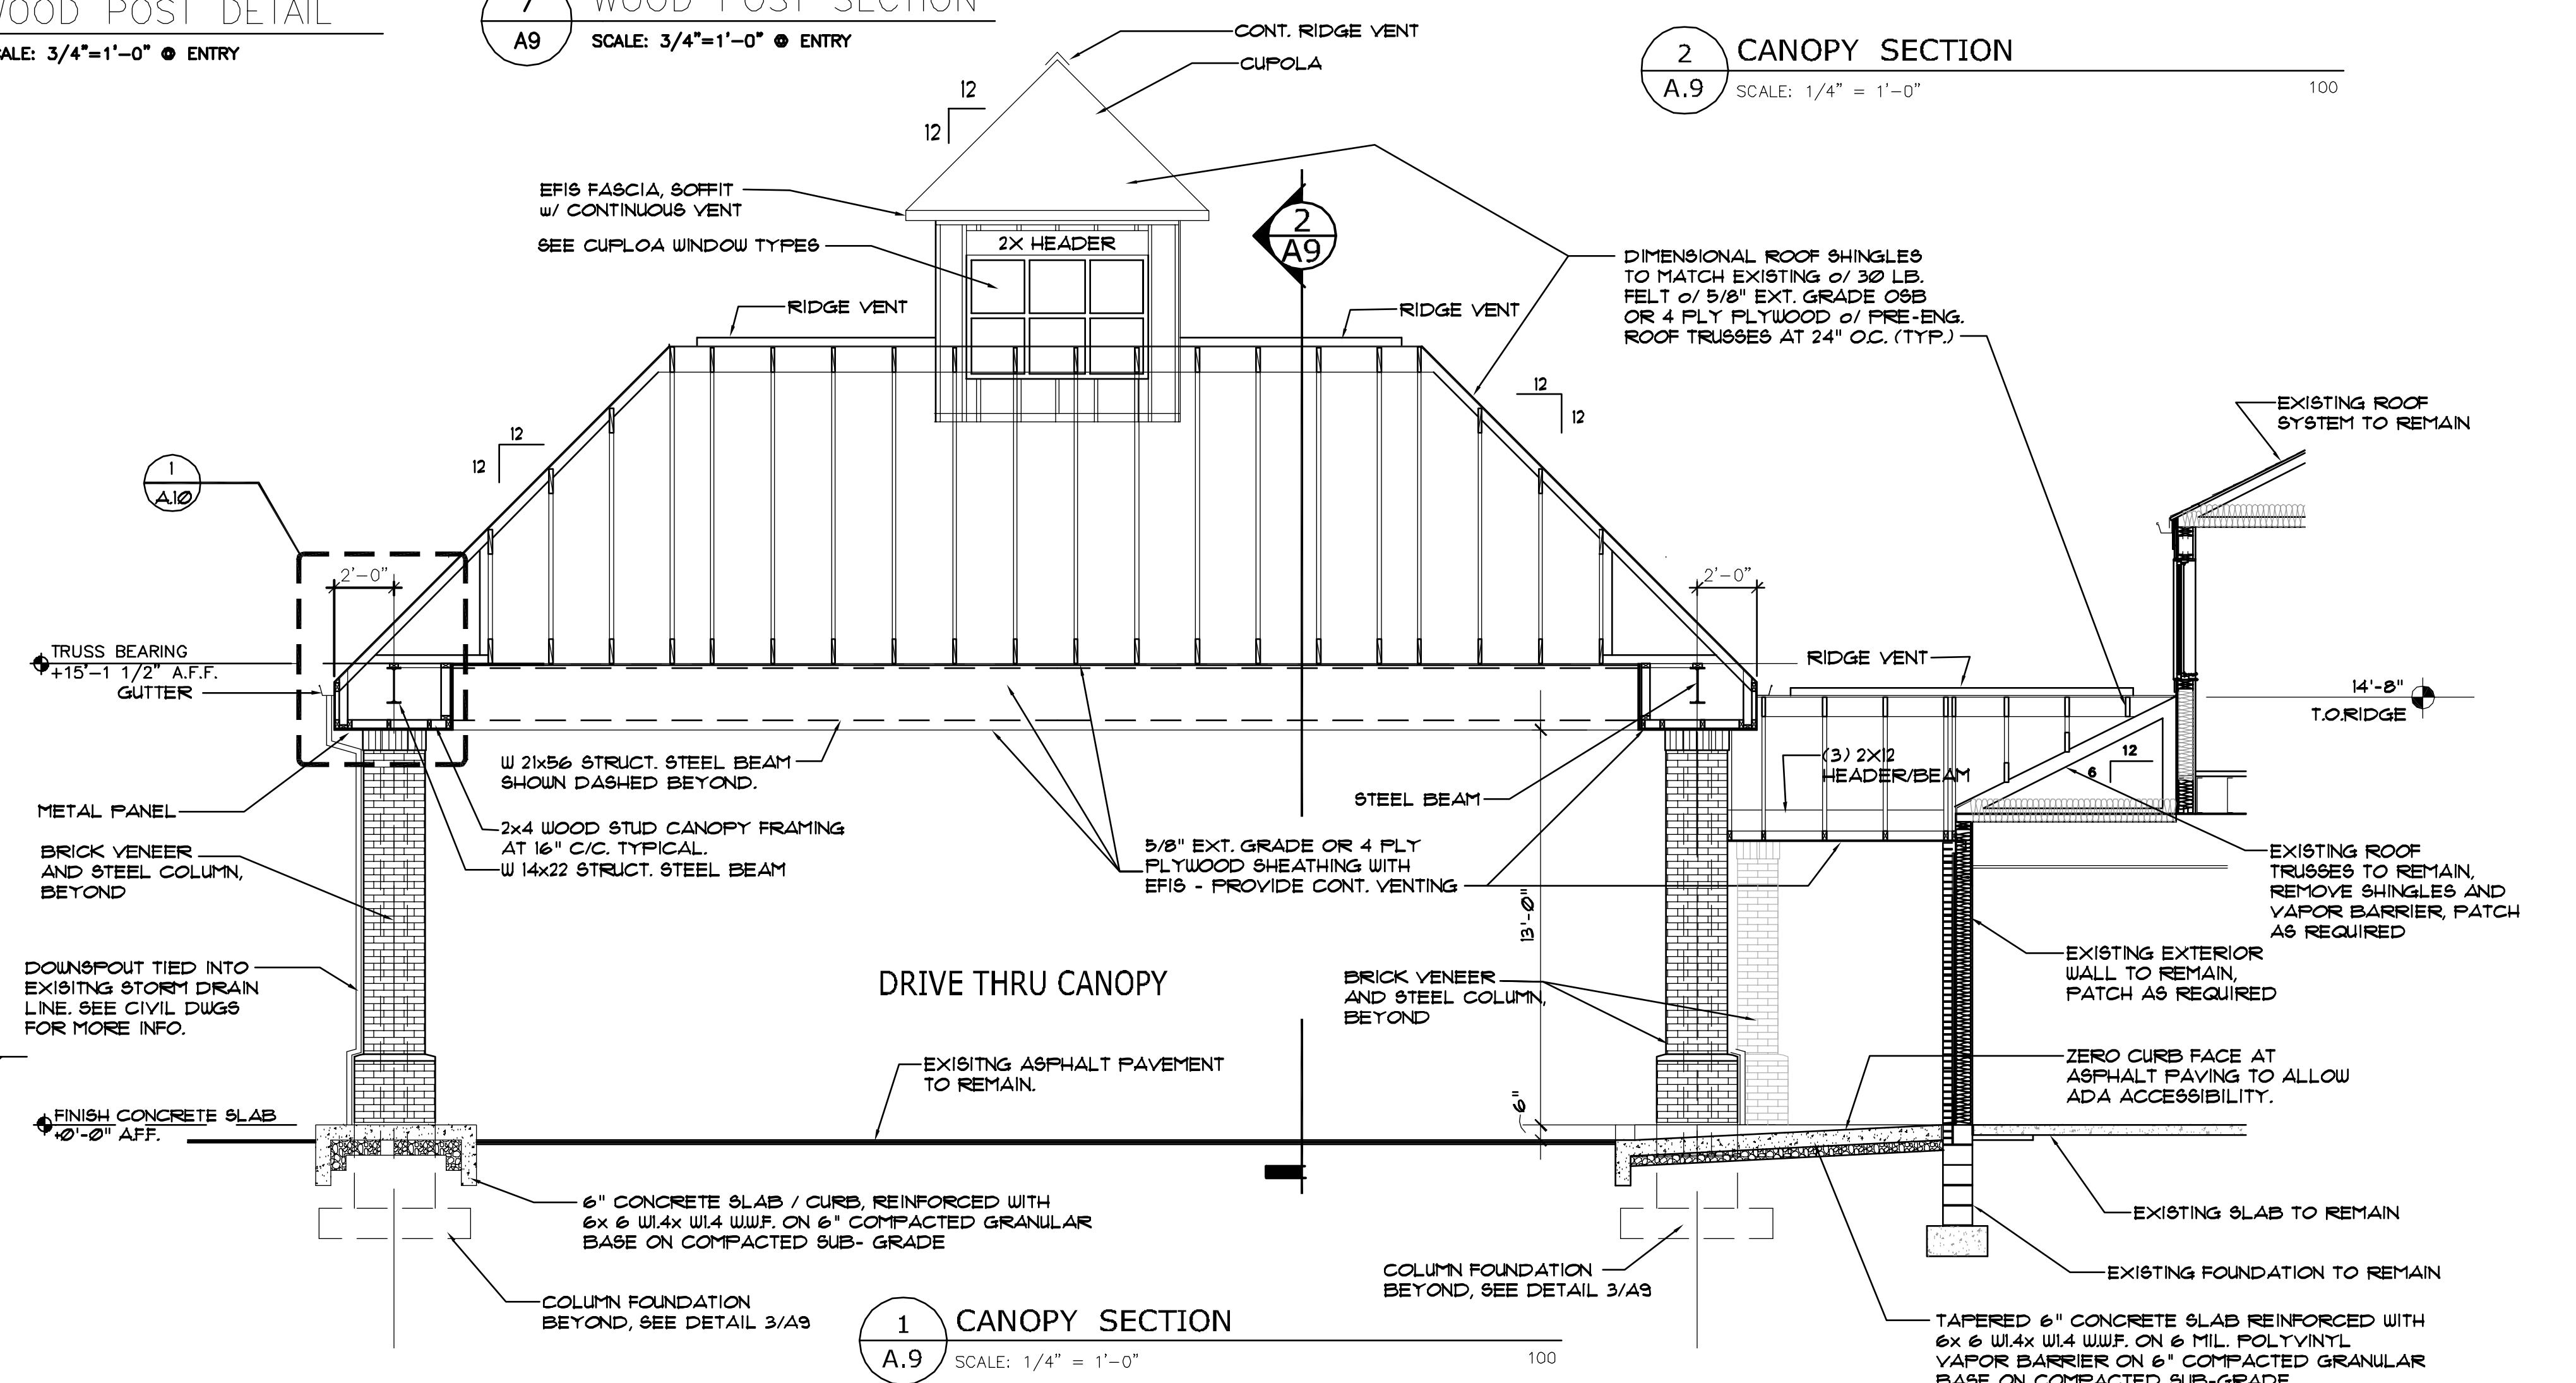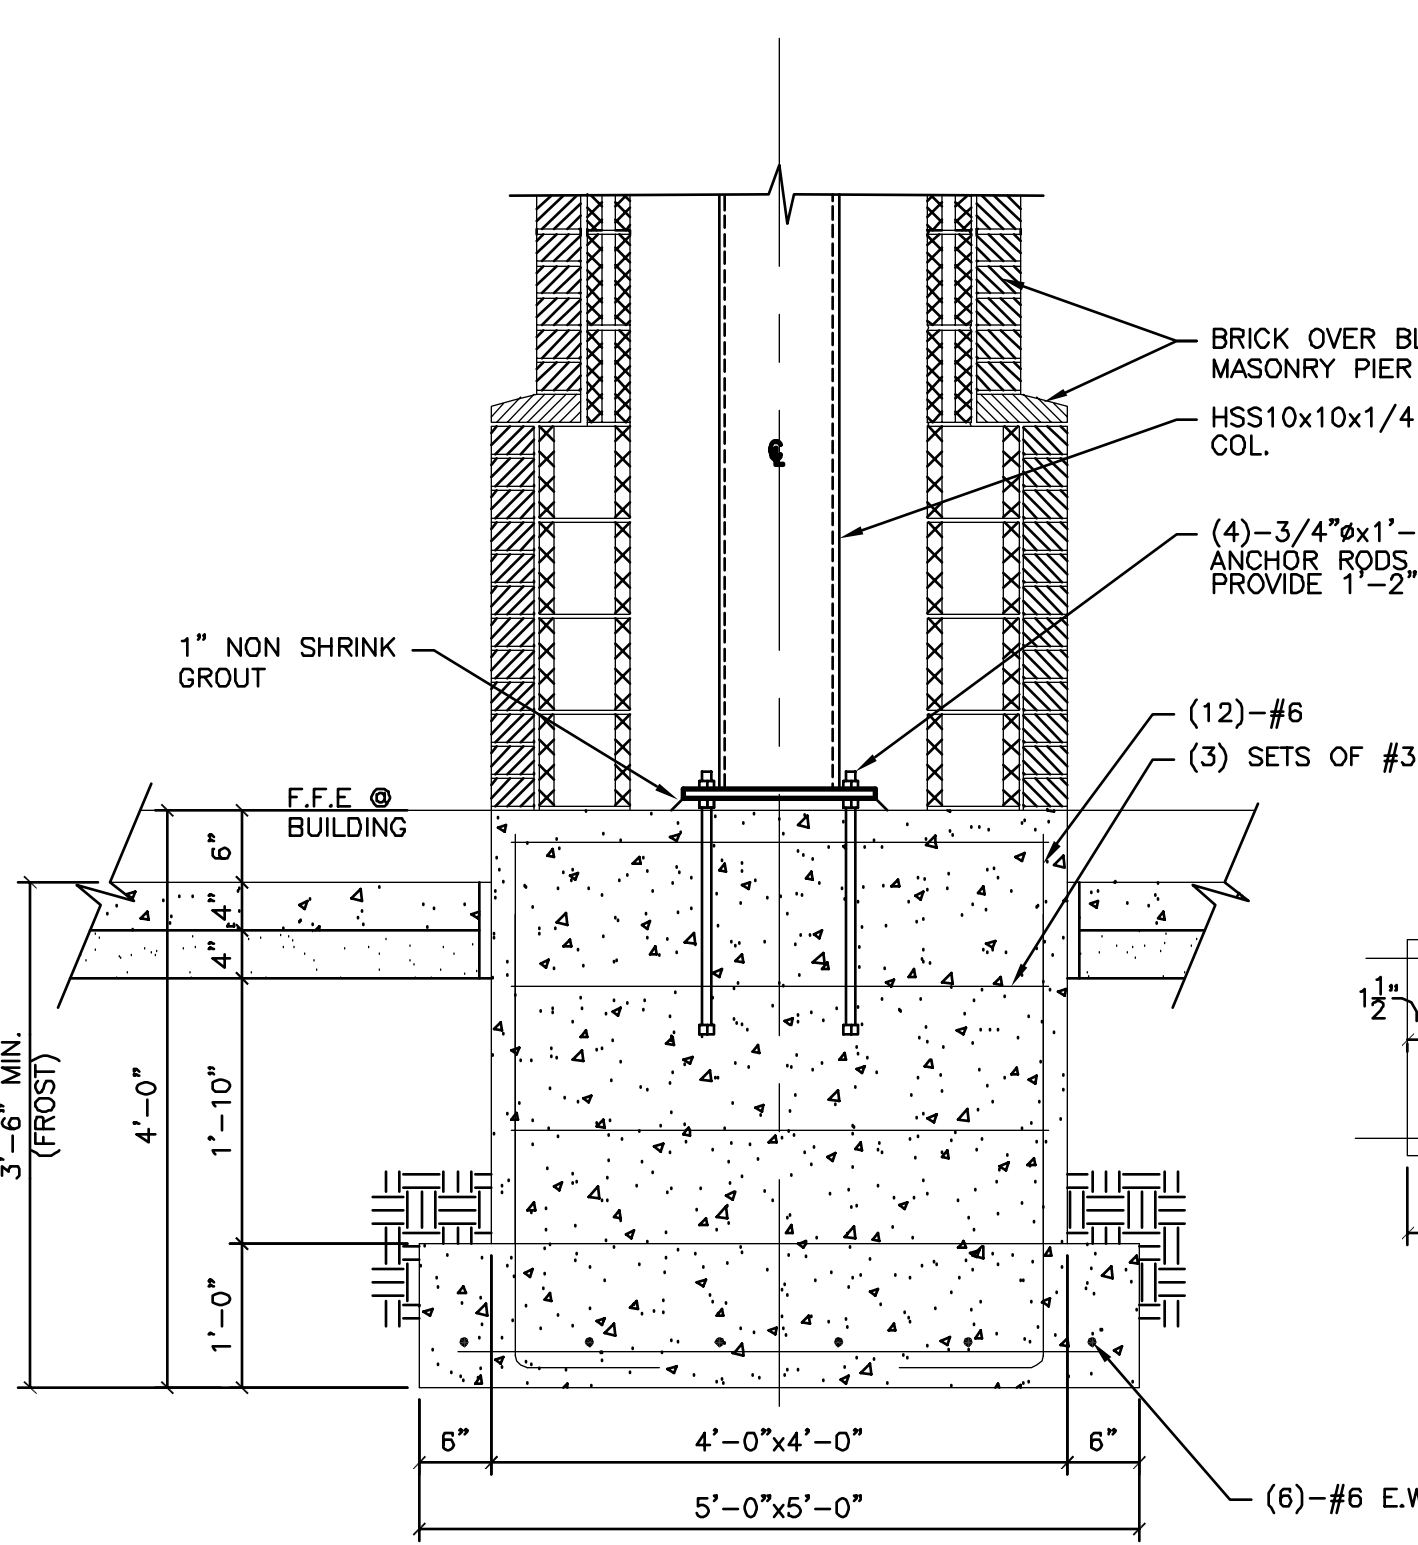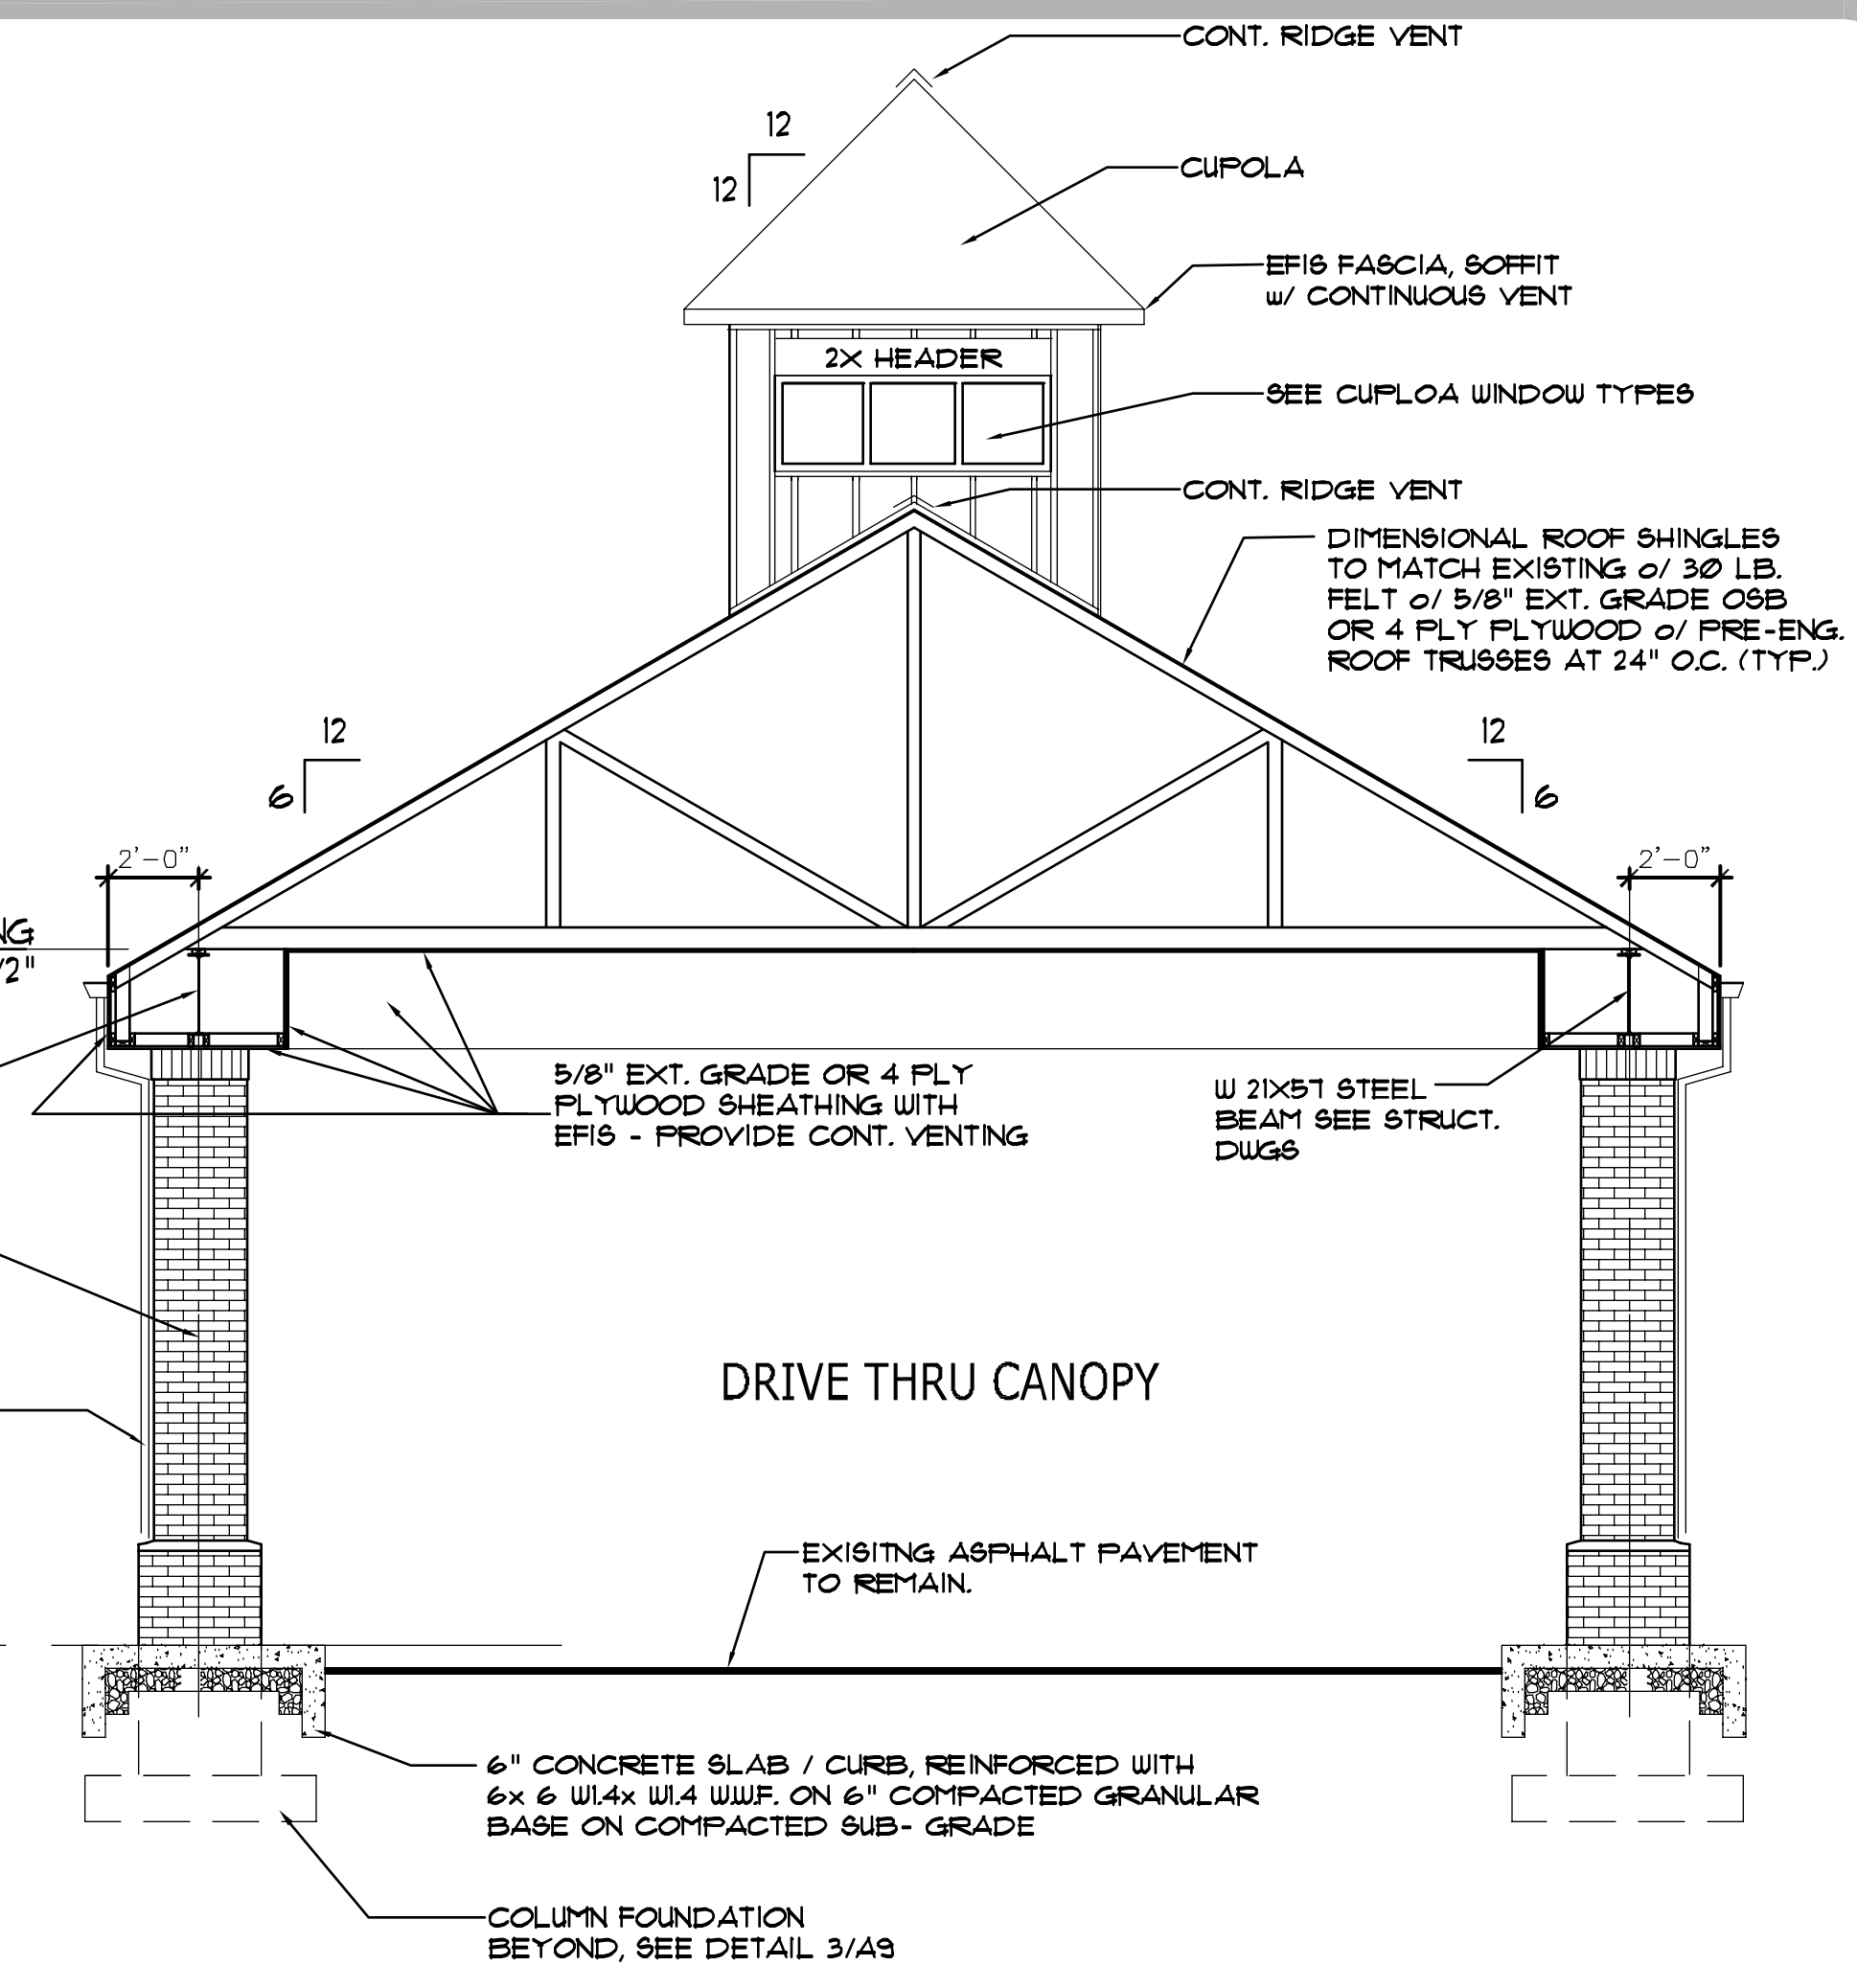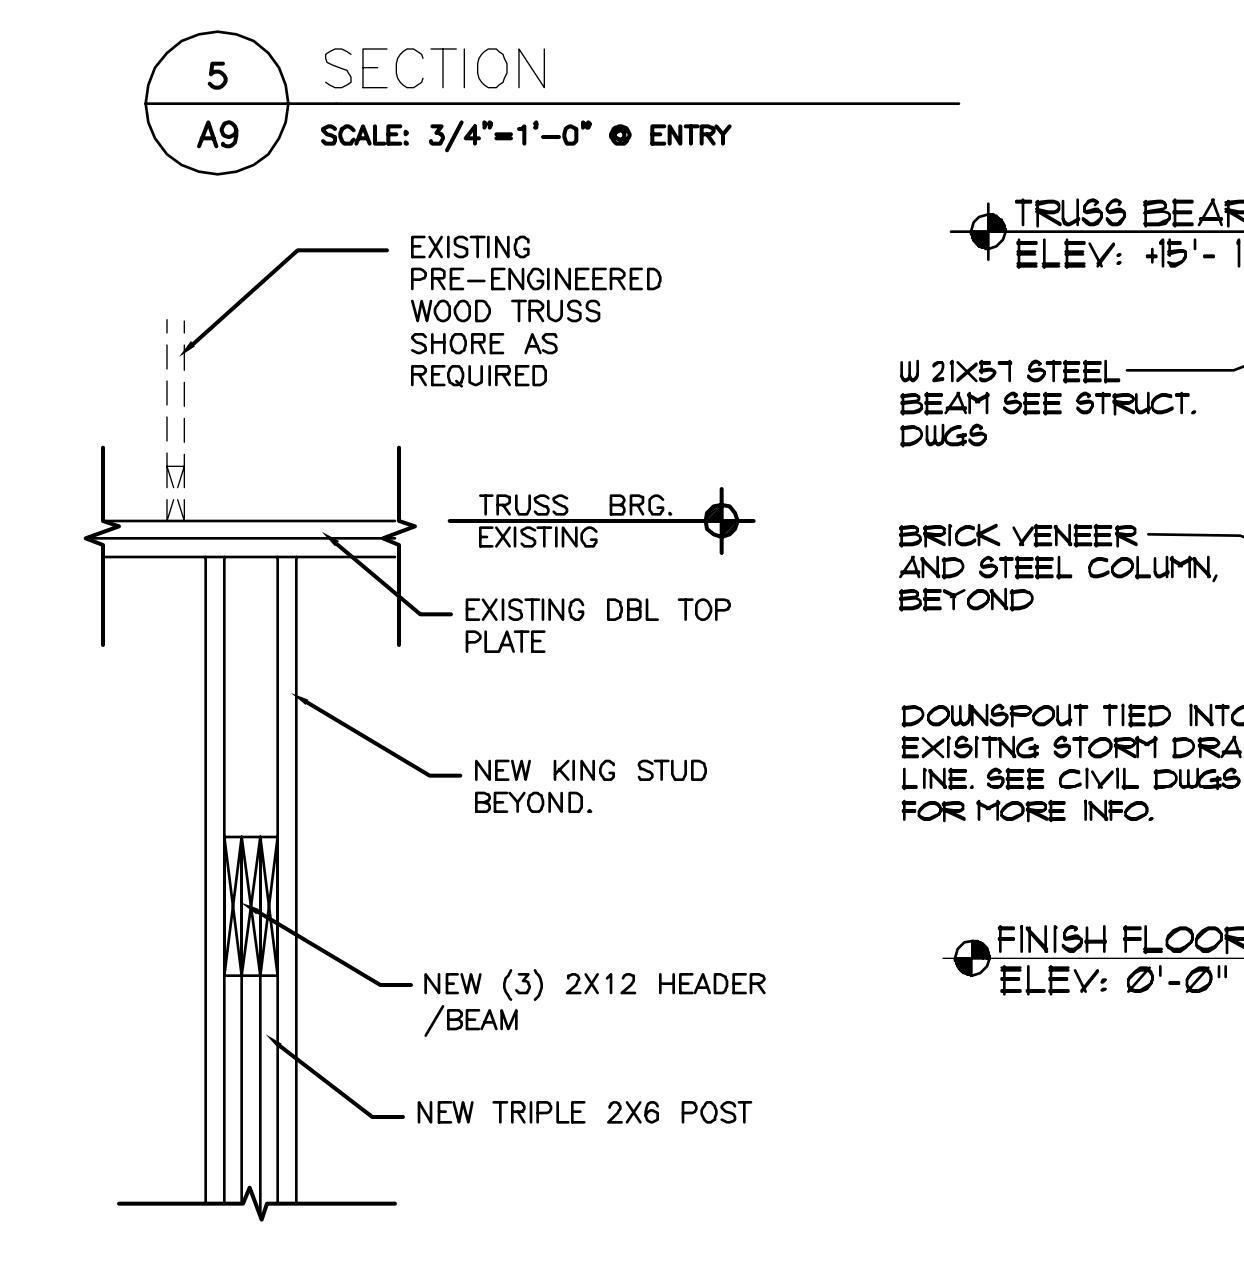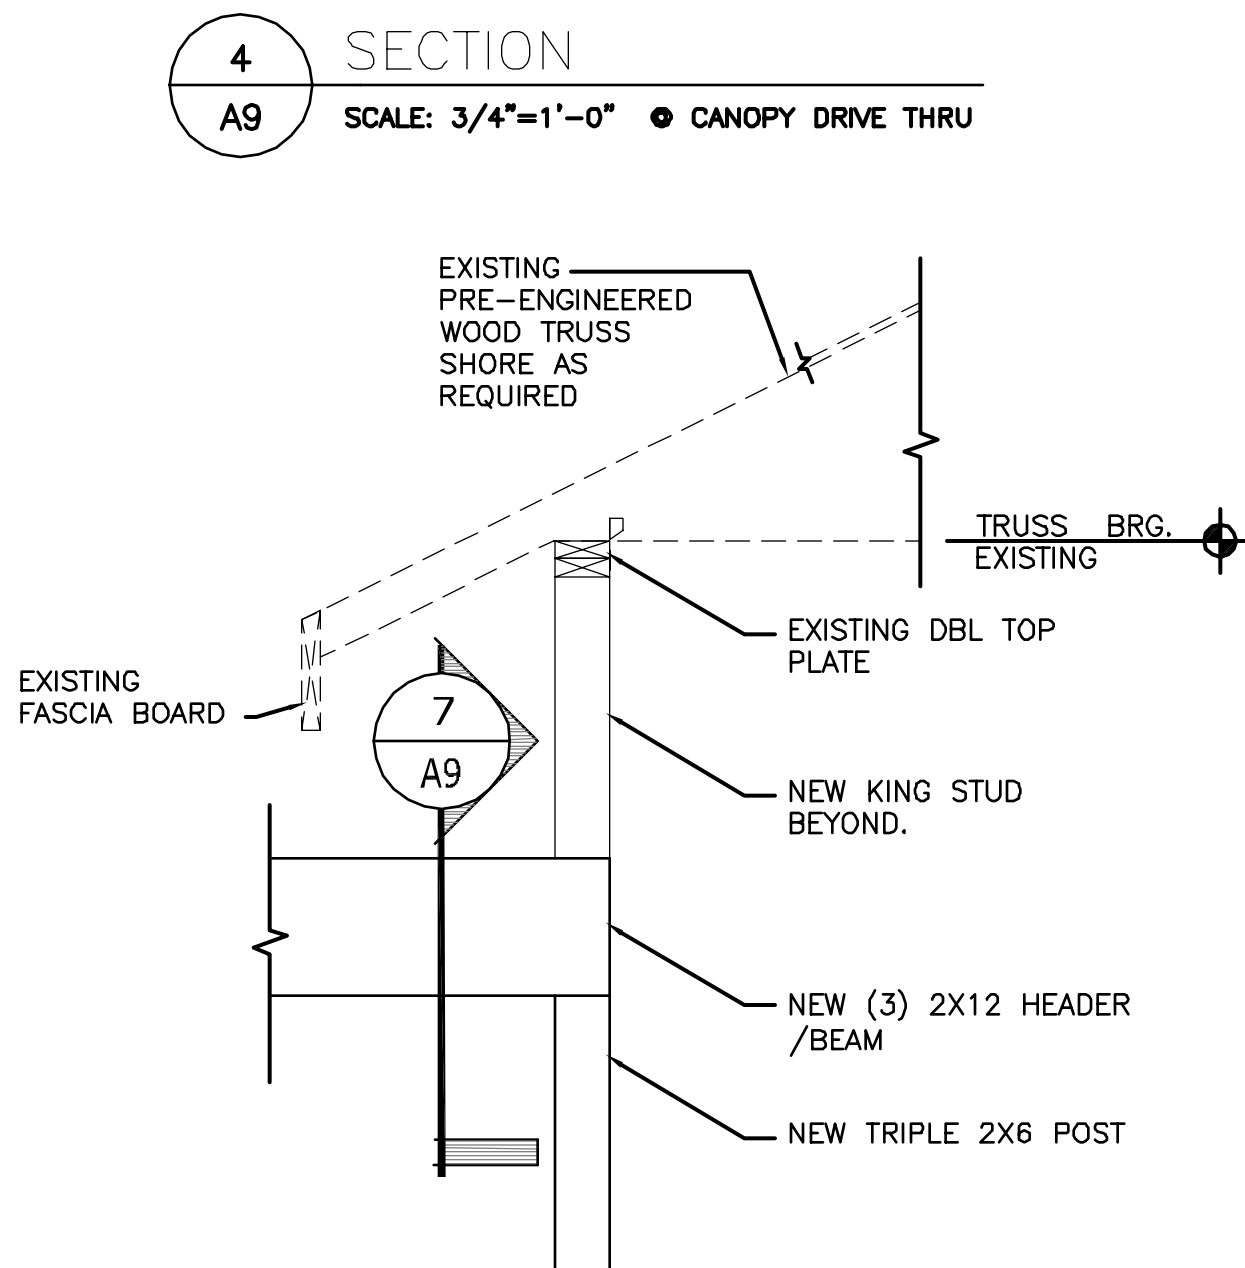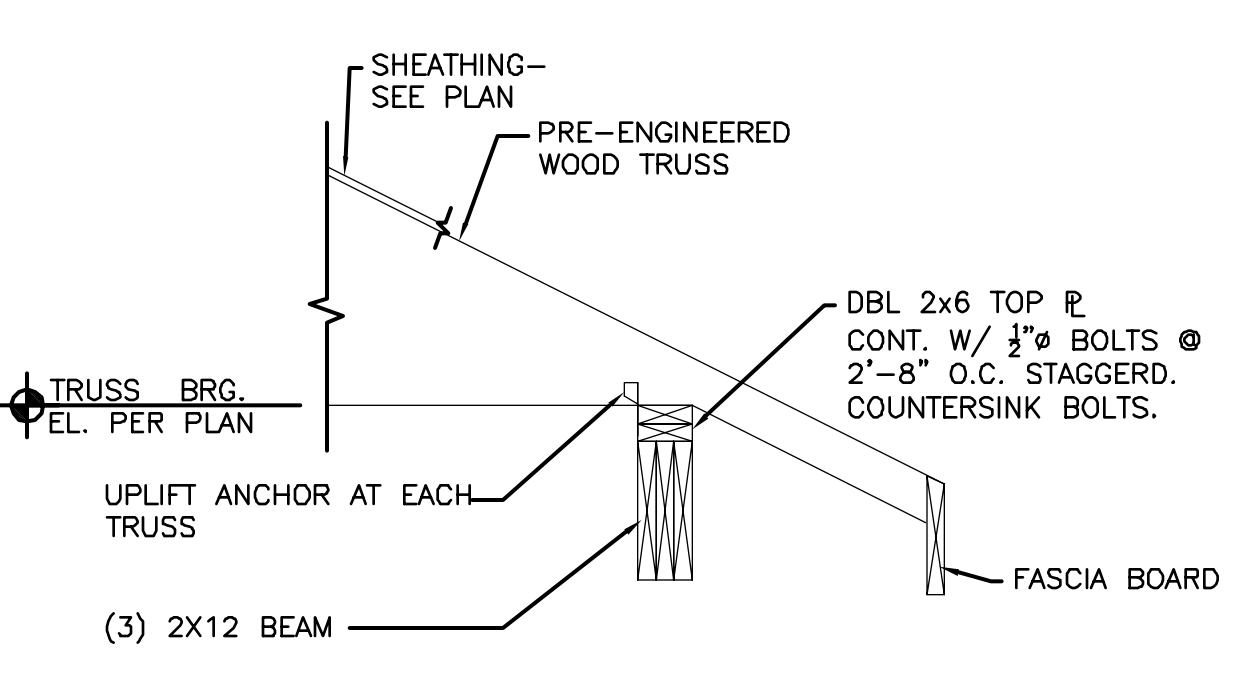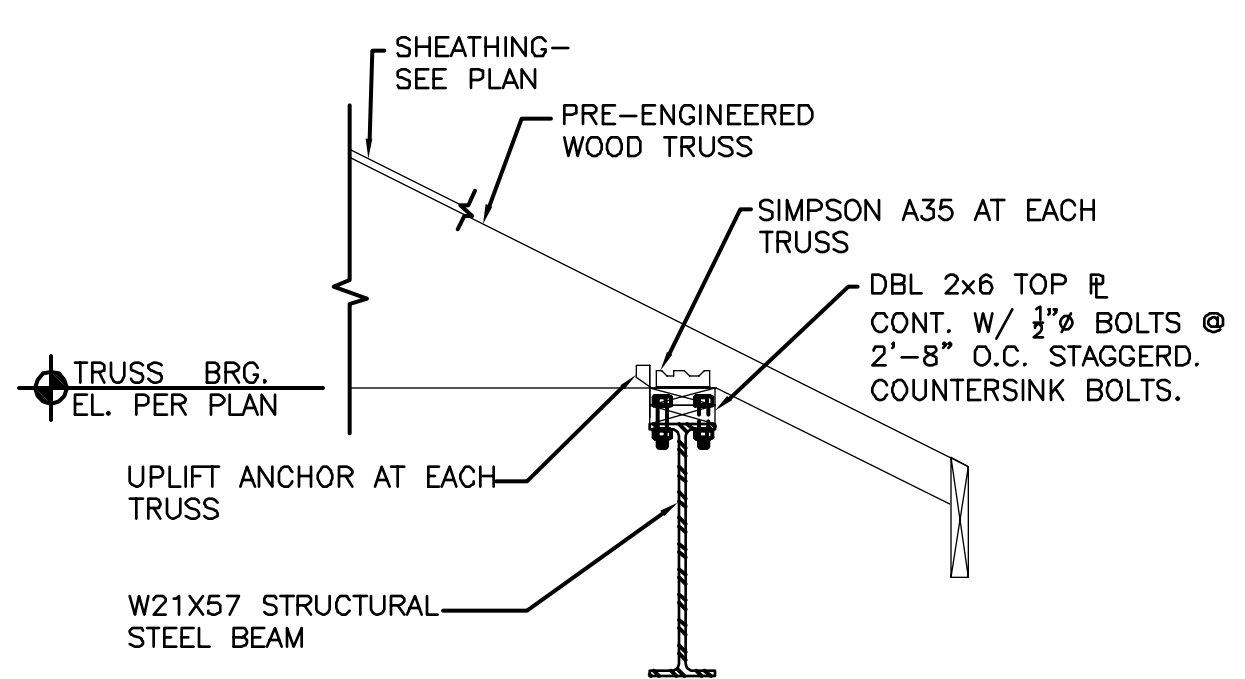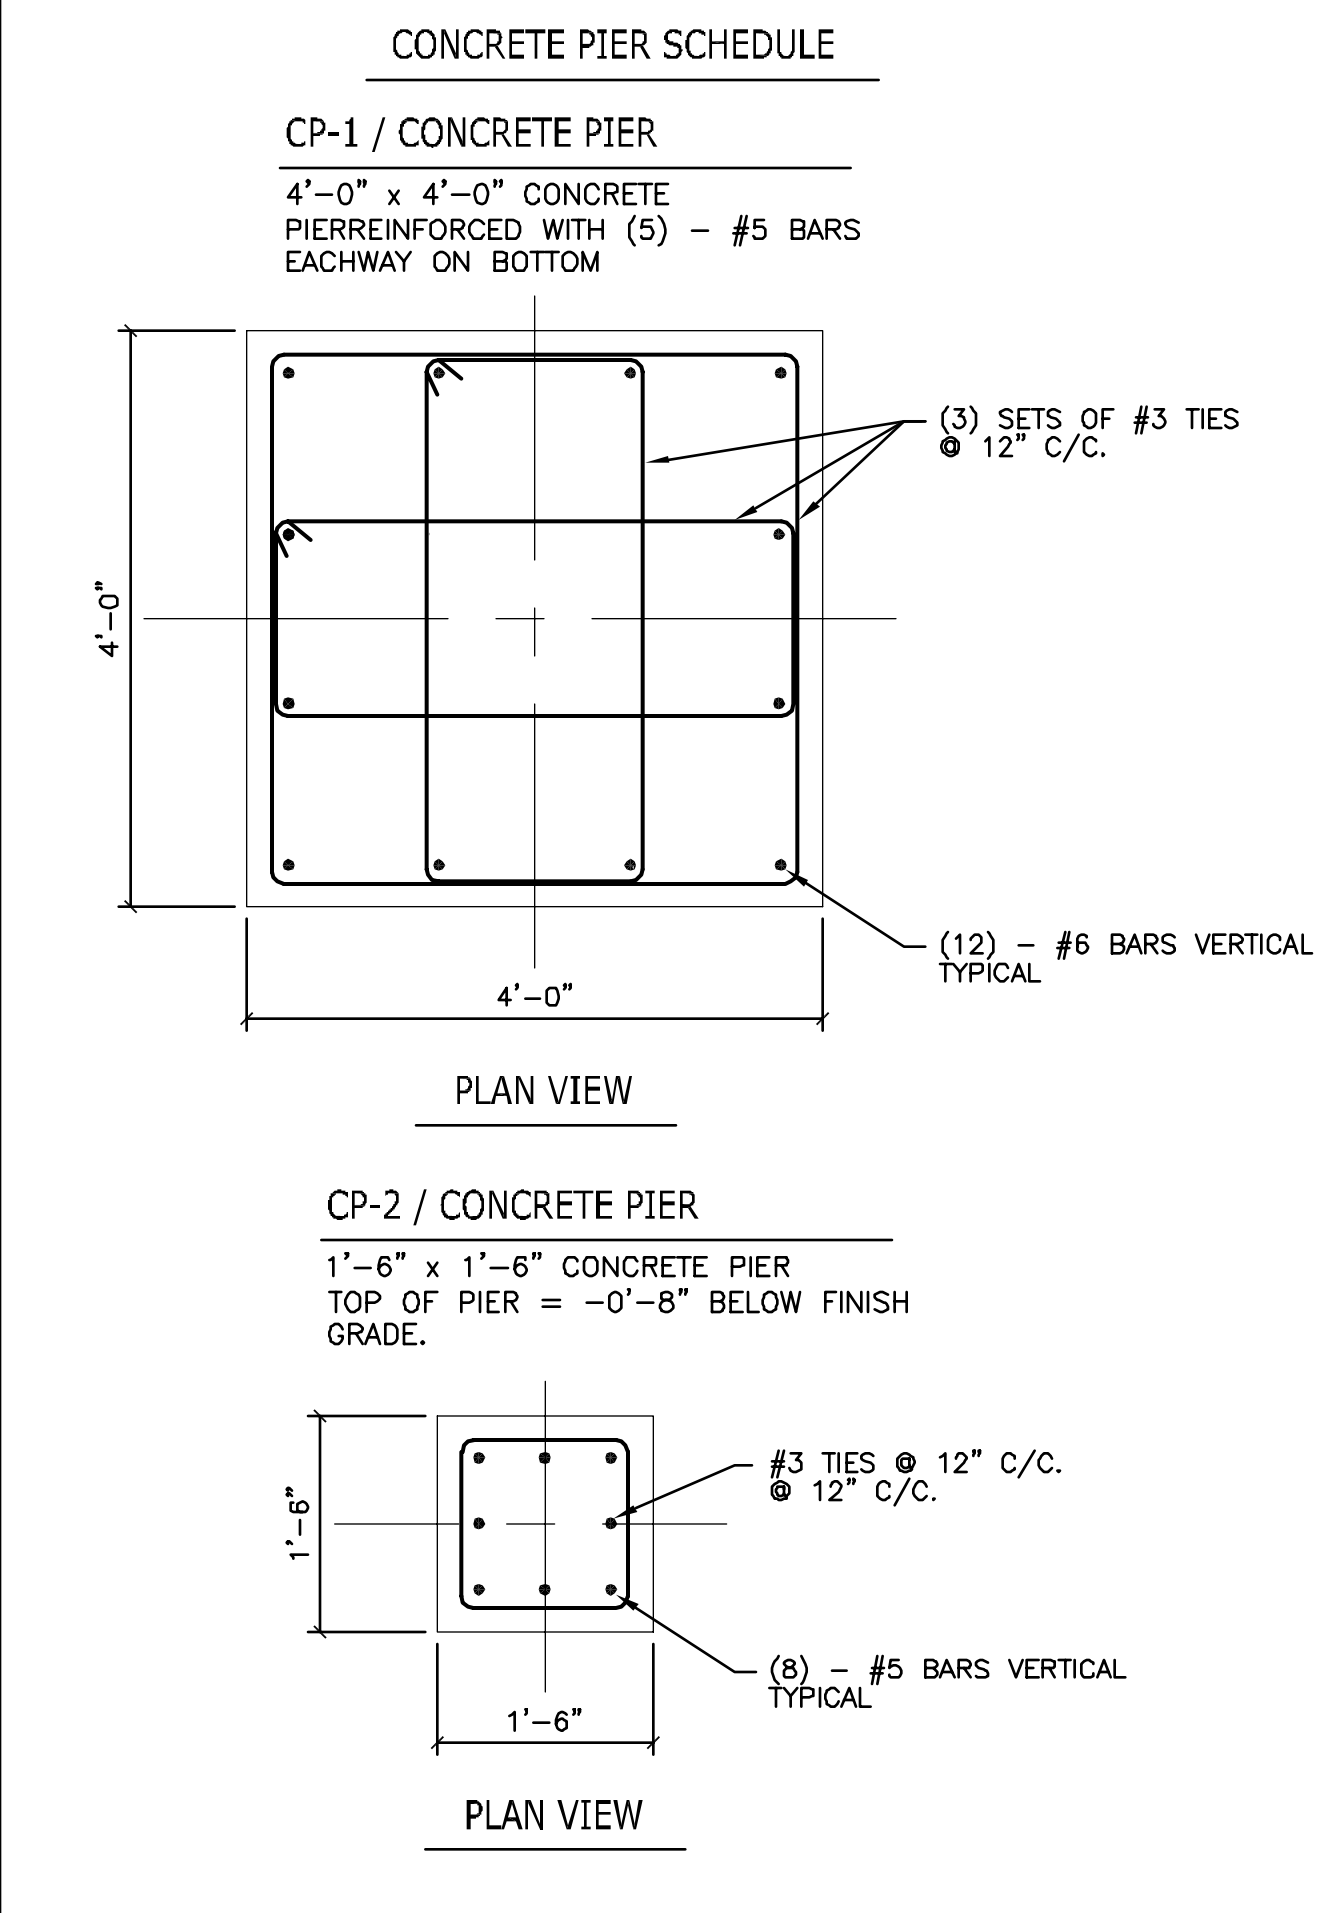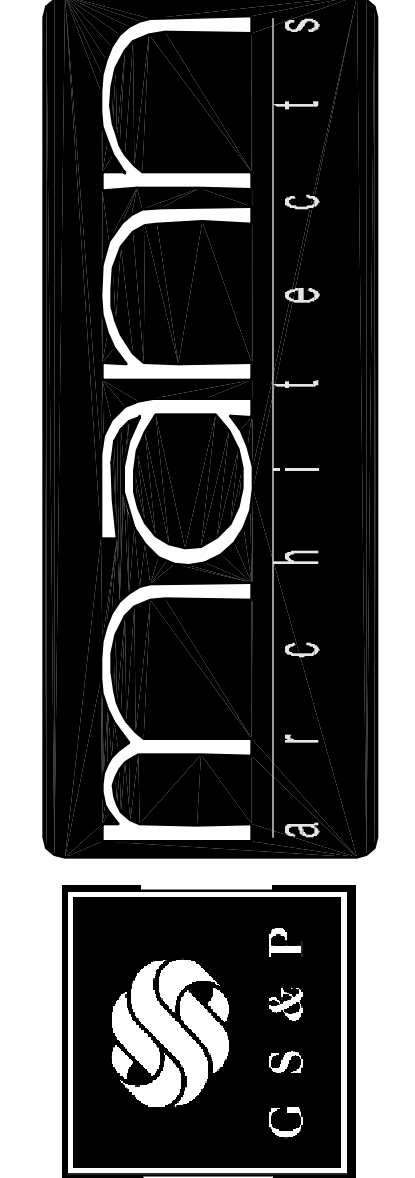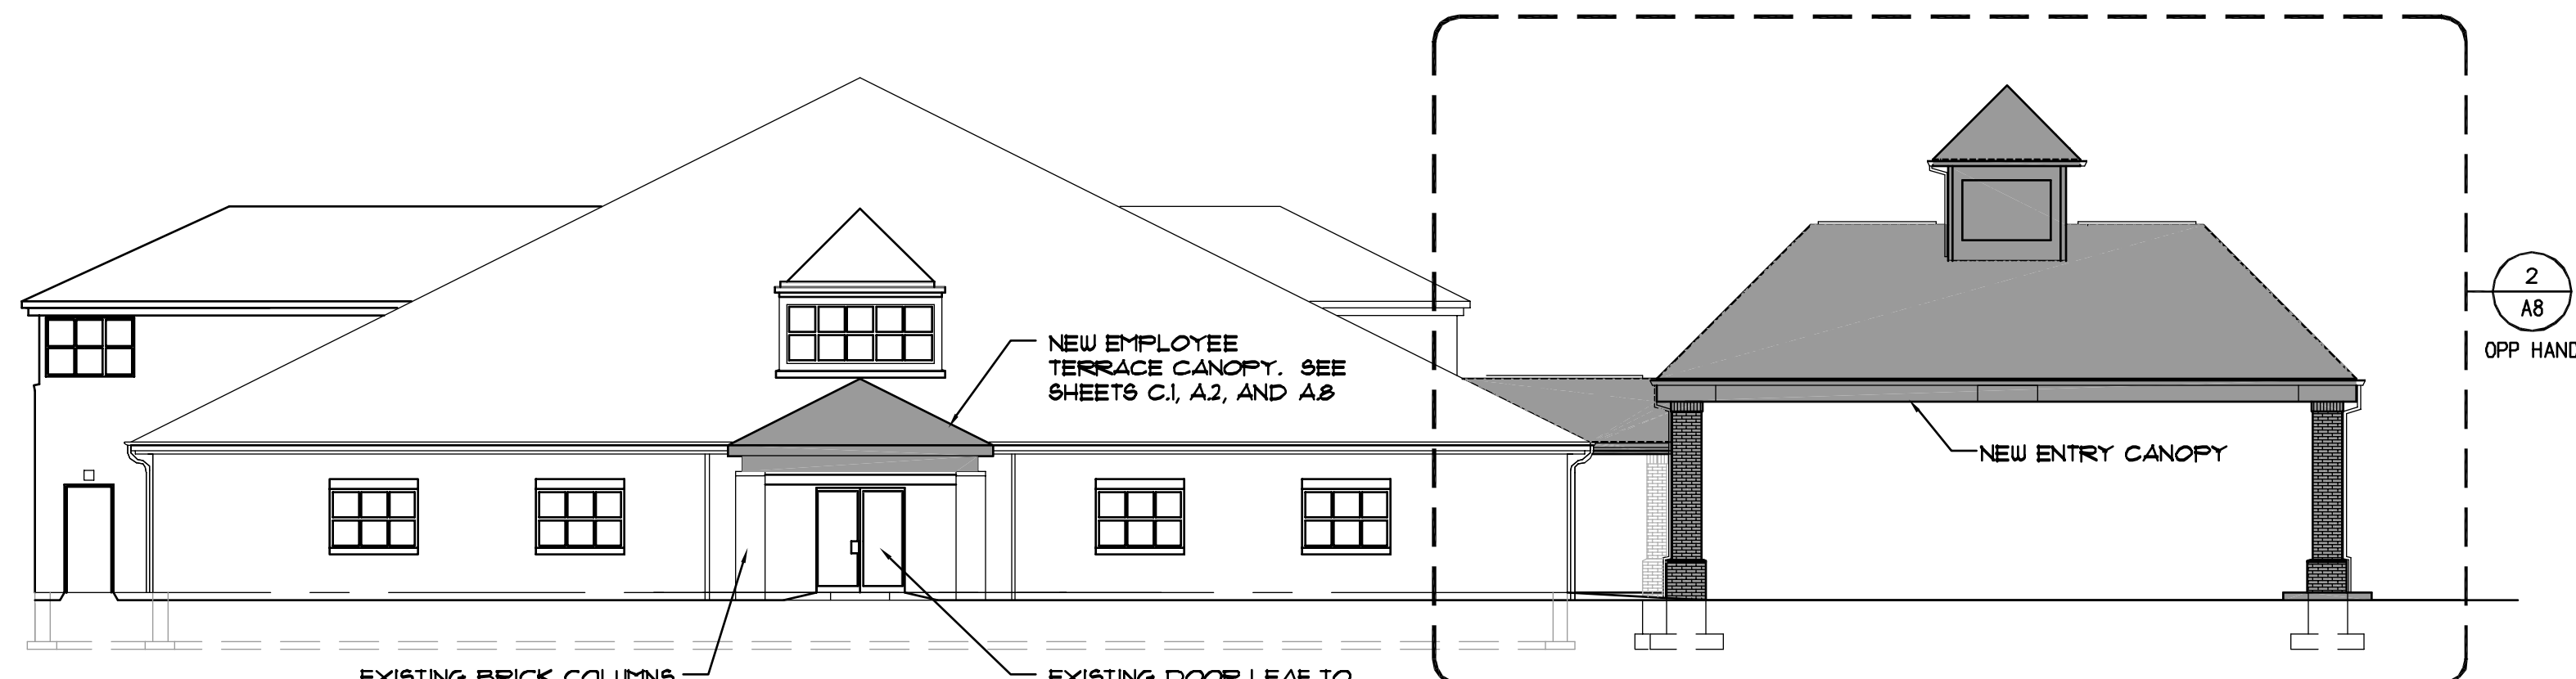
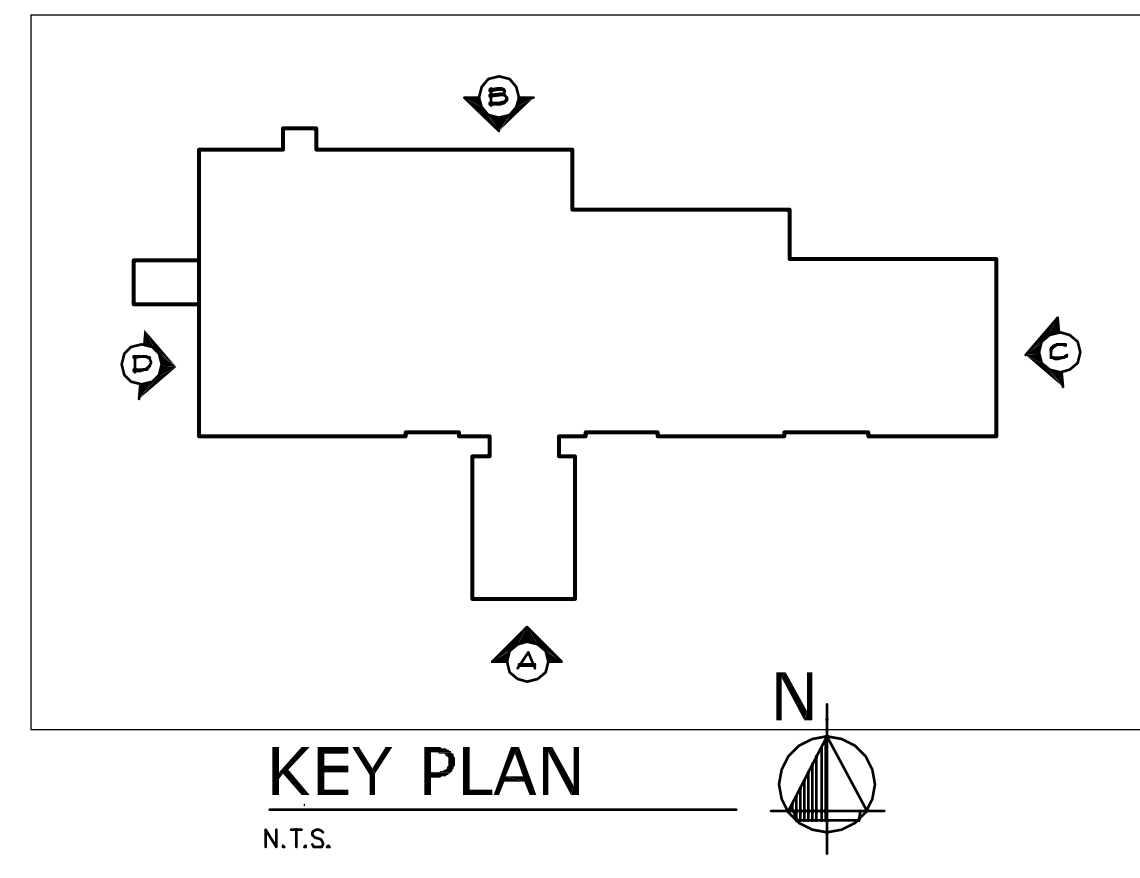
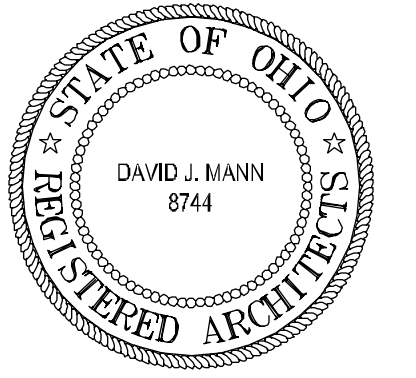
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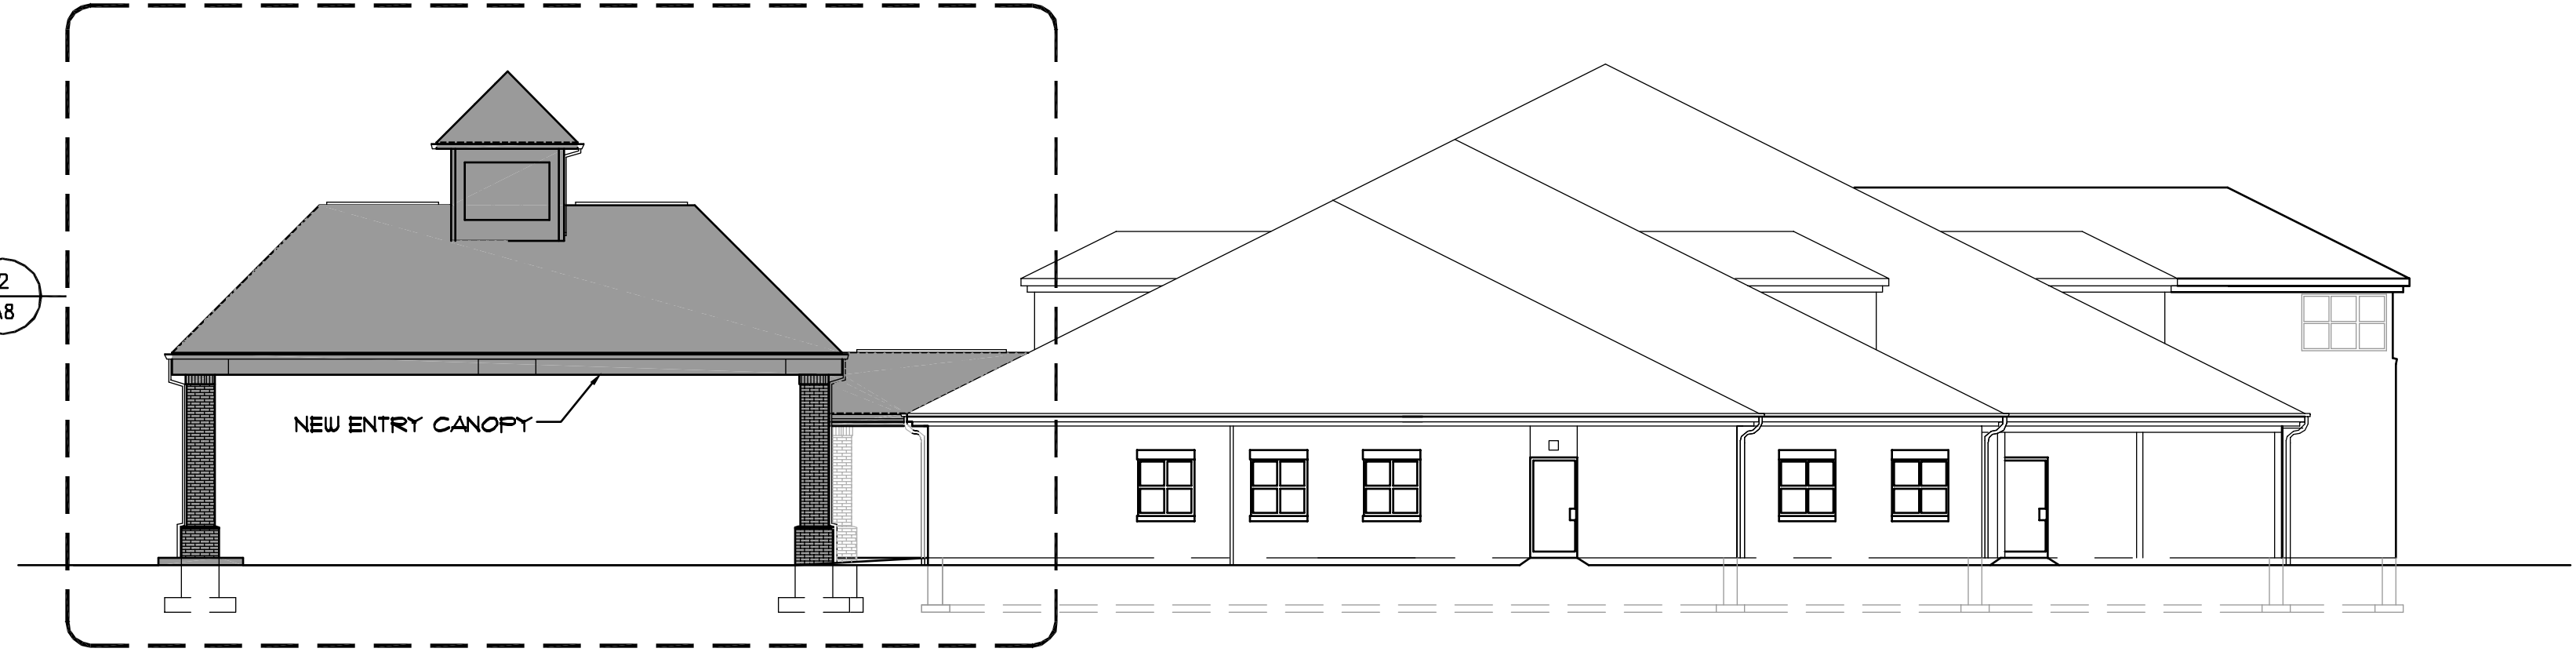


drawing  
CANOPY SECTIONS  
project no. 11406  
date OCTOBER 23, 2001  
scale AS NOTED  
AS NOTED  
COLUMBUS ONCOLOGY  
JASONIAT PROFESSIONAL BUILDING  
810 JASONIAT AVENUE, SUITE A  
COLUMBUS, OHIO 43214-2329

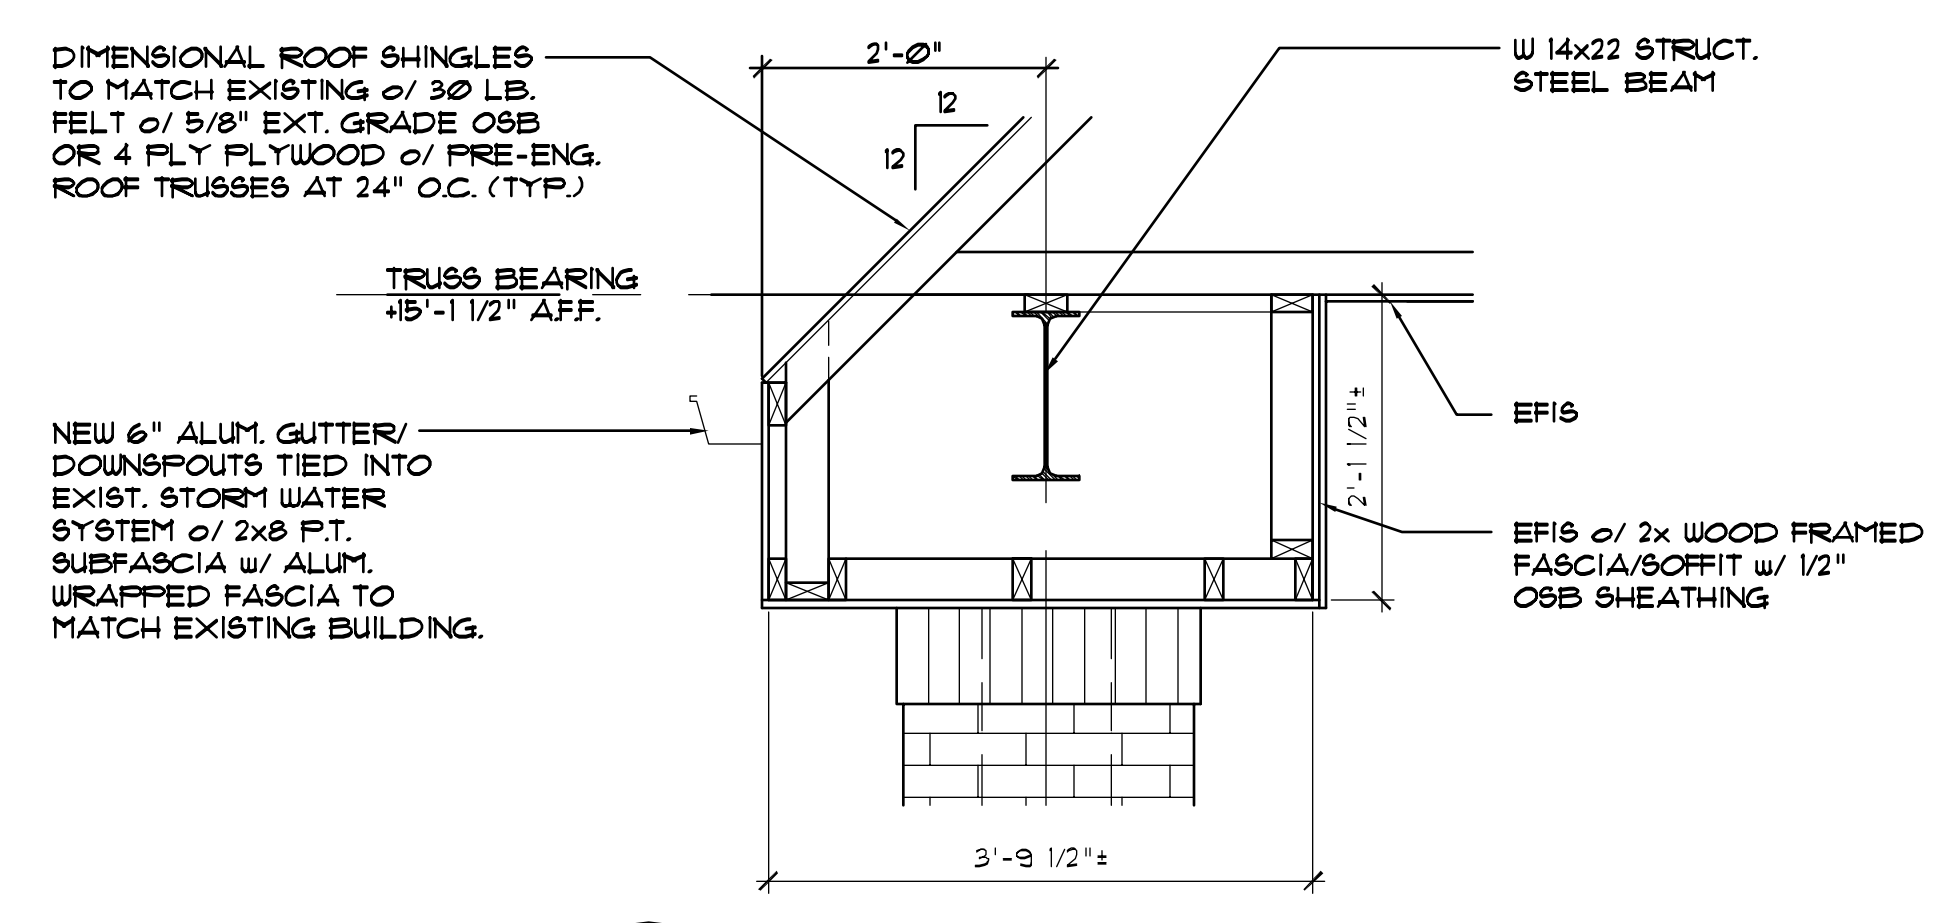
**A.9**  
OF 18  
sheet no.



**WEST ELEVATION**  
SCALE 3/32" = 1'-0"




**EAST ELEVATION**  
SCALE 3/32" = 1'-0"



**NEW ENTRY CANOPY**  
SCALE 3/4" = 1'-0"




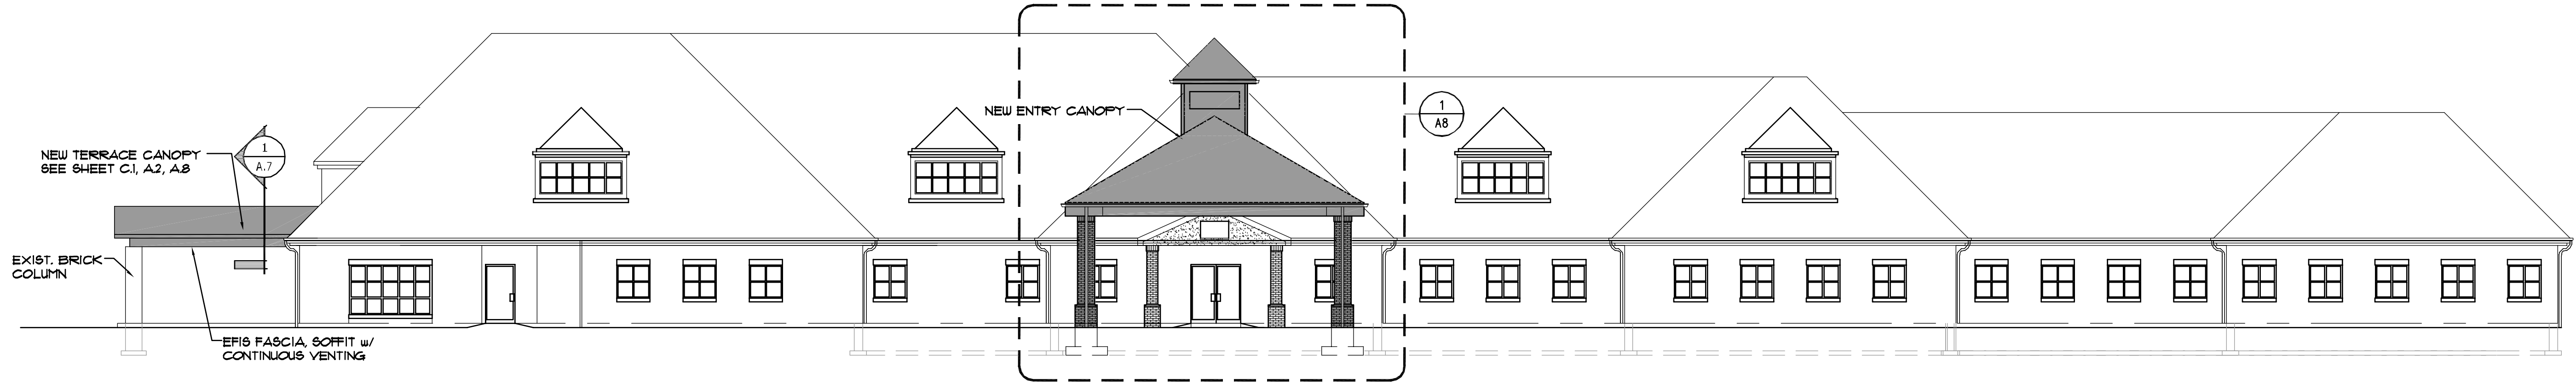
**NORTH ELEVATION**  
SCALE 3/32" = 1'-0"



**SOUTH ELEVATION**  
SCALE 3/32" = 1'-0"

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drawing  
EXTERIOR ELEVATIONS

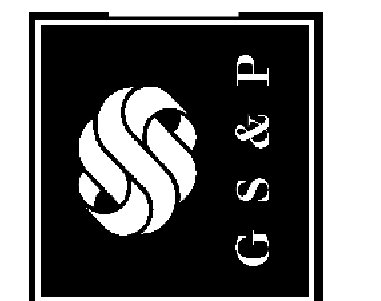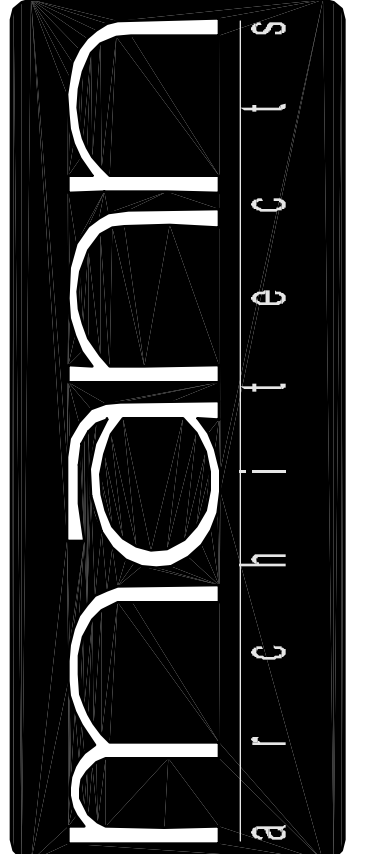project no. 114216  
date OCTOBER 23, 2007  
scale AS NOTED


**COLUMBUS ONCOLOGY**  
JASONIAY PROFESSIONAL BUILDING  
810 JASONIAY AVENUE SUITE A  
COLUMBUS, OHIO 43214-2329

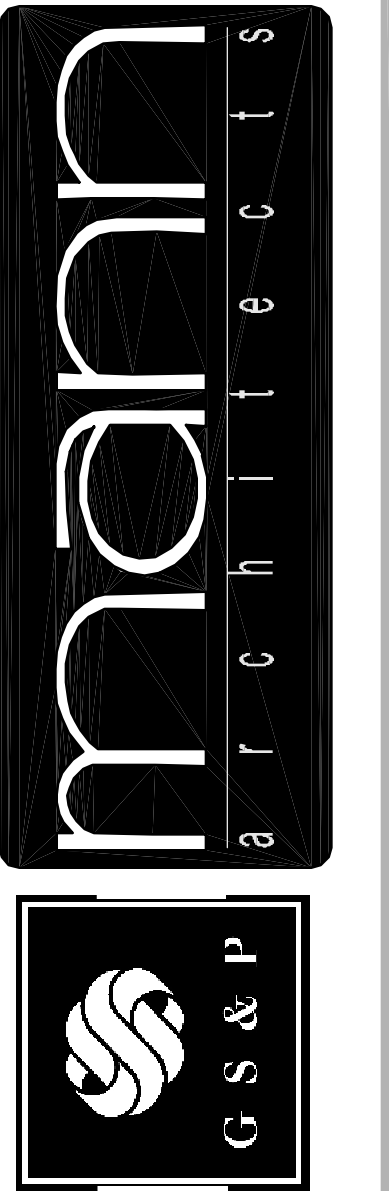**A.10**  
OF 18  
sheet no.

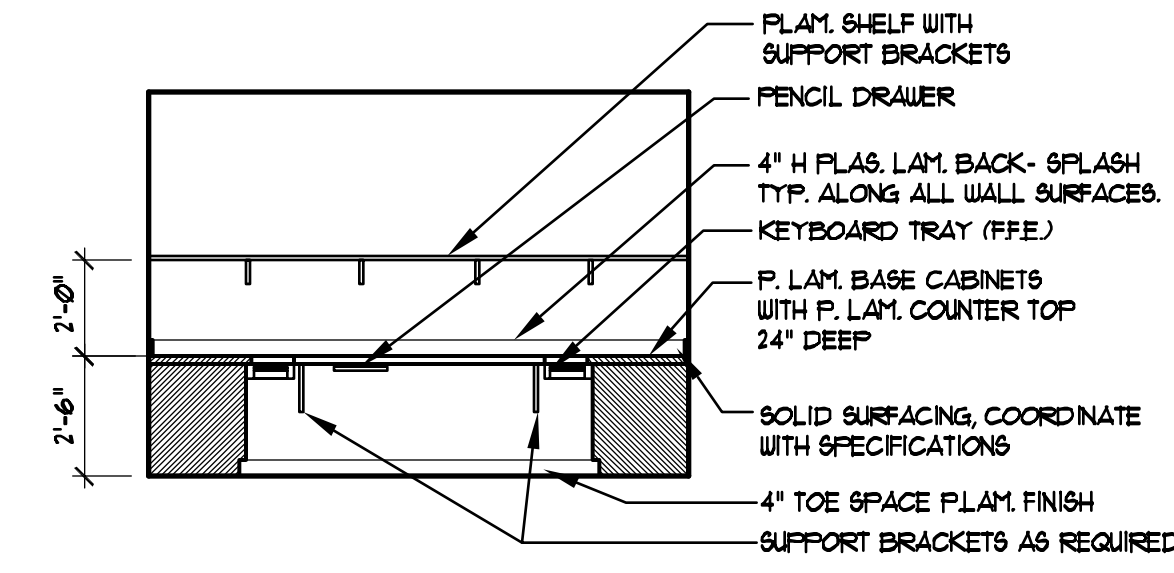


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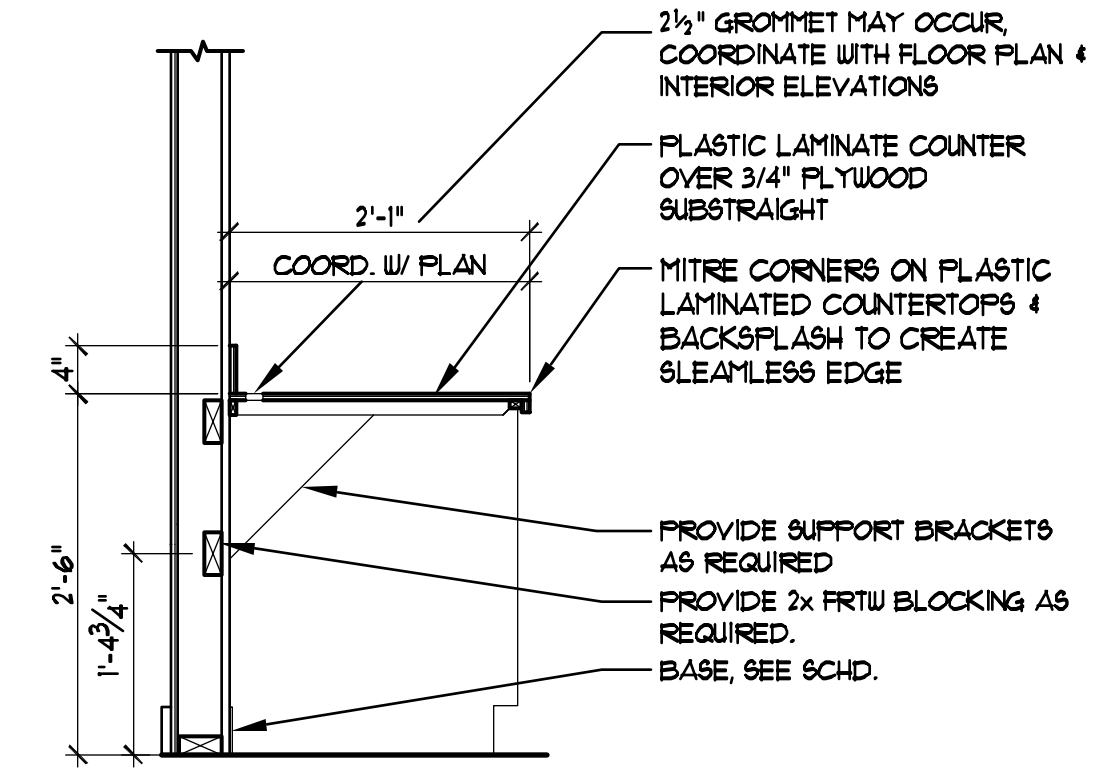
3660 embassy parkway  
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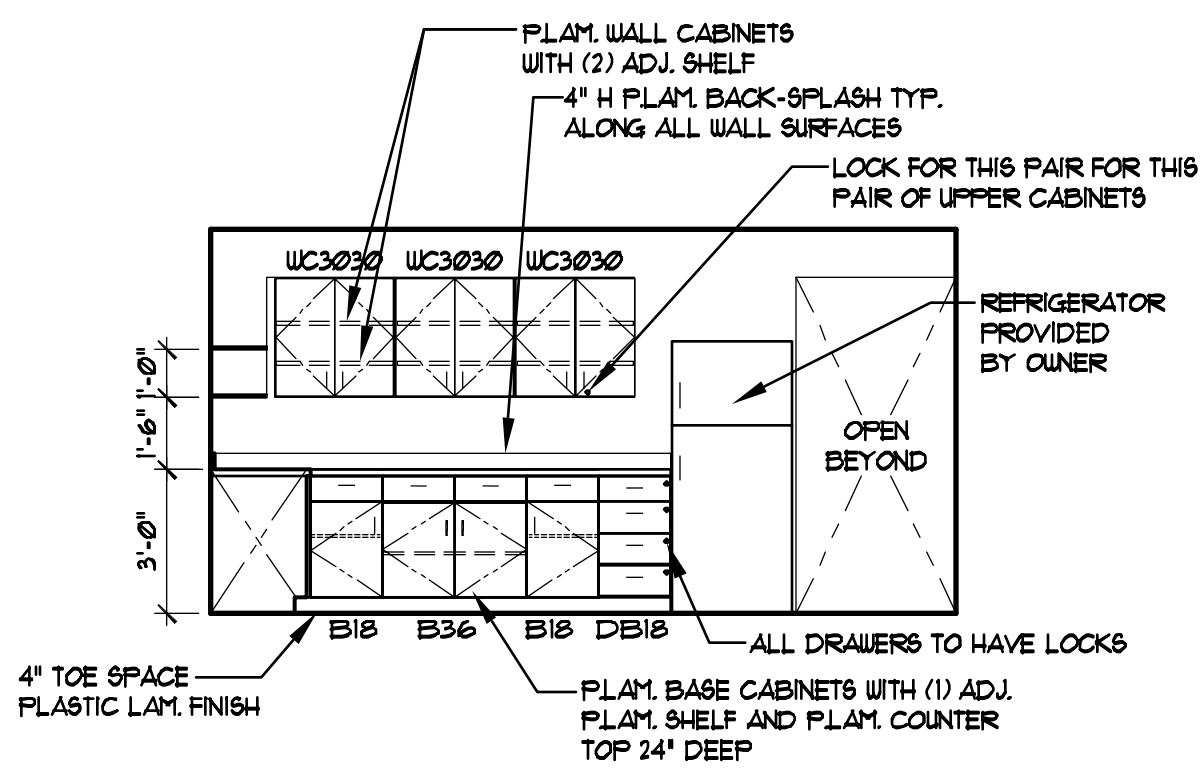
drawing  
ENLARGED ROOMS & INTERIOR ELEV. scale  
project no. 11406 date OCTOBER 23, 2001 AS NOTED  
COLUMBUS ONCOLOGY  
JASONIWAY PROFESSIONAL BUILDING  
810 JASONIWAY AVENUE SUITE A  
COLUMBUS, OHIO 43214-2323




13 TRIAGE ROOM  
A.11 SCALE: 1/4" = 1'-0" 102




9 TRIAGE ROOM  
A.11 SCALE: 3/4" = 1'-0" 102



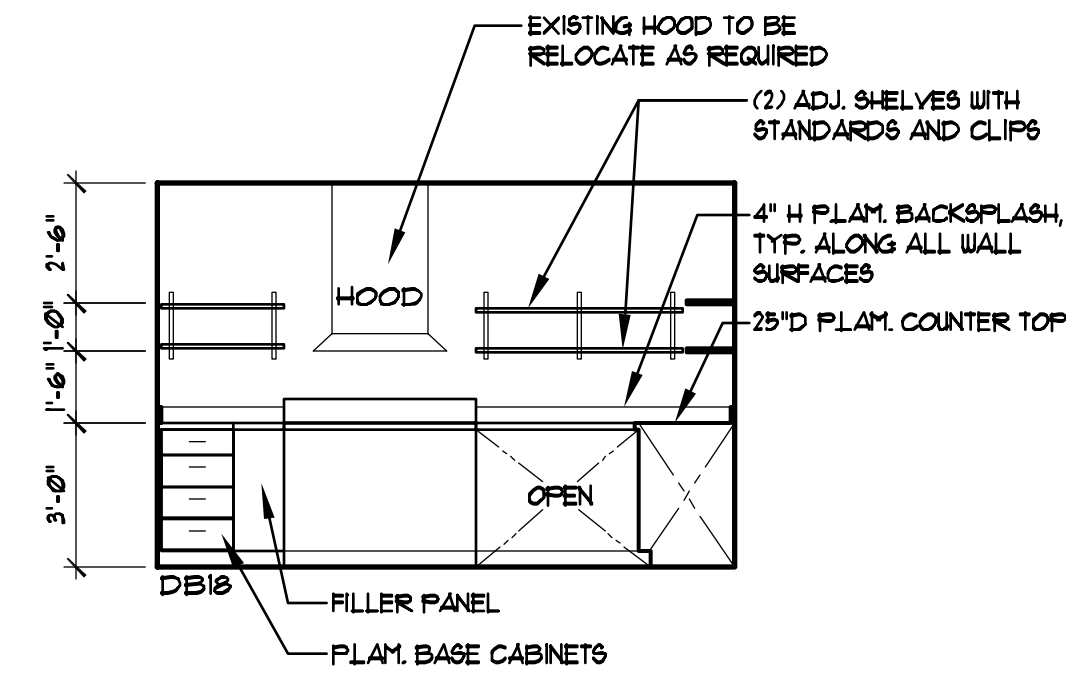
10 MIXING  
A.11 SCALE: 1/4" = 1'-0" 116



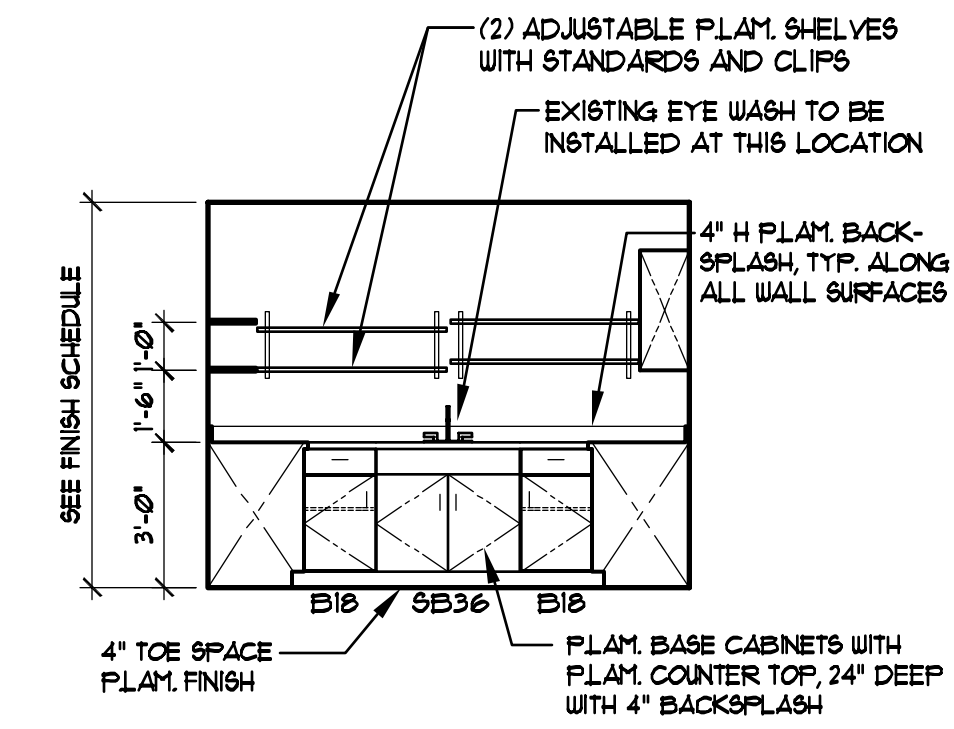
12 MIXING  
A.11 SCALE: 1/4" = 1'-0" 116



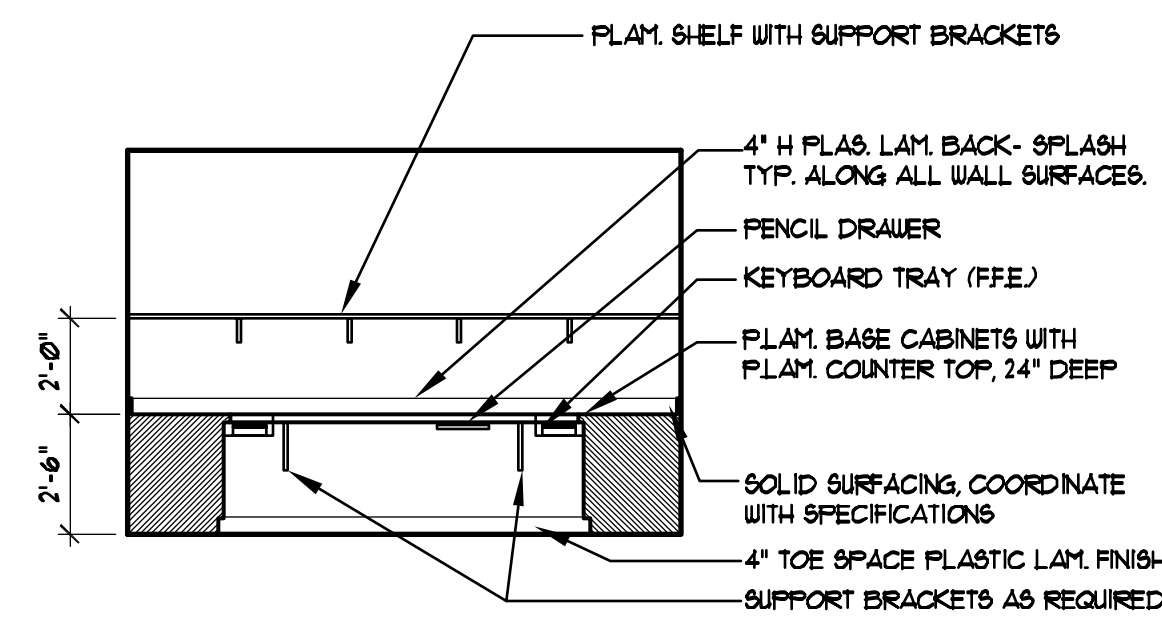
11 MIXING  
A.11 SCALE: 1/4" = 1'-0" 116



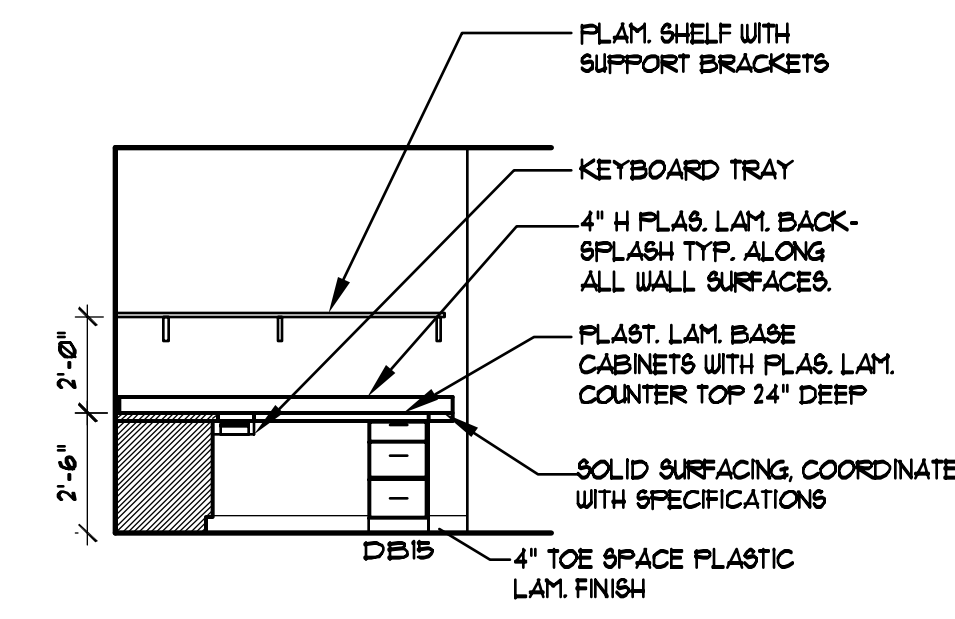
8 TRIAGE ROOM  
A.11 SCALE: 1/4" = 1'-0" 102



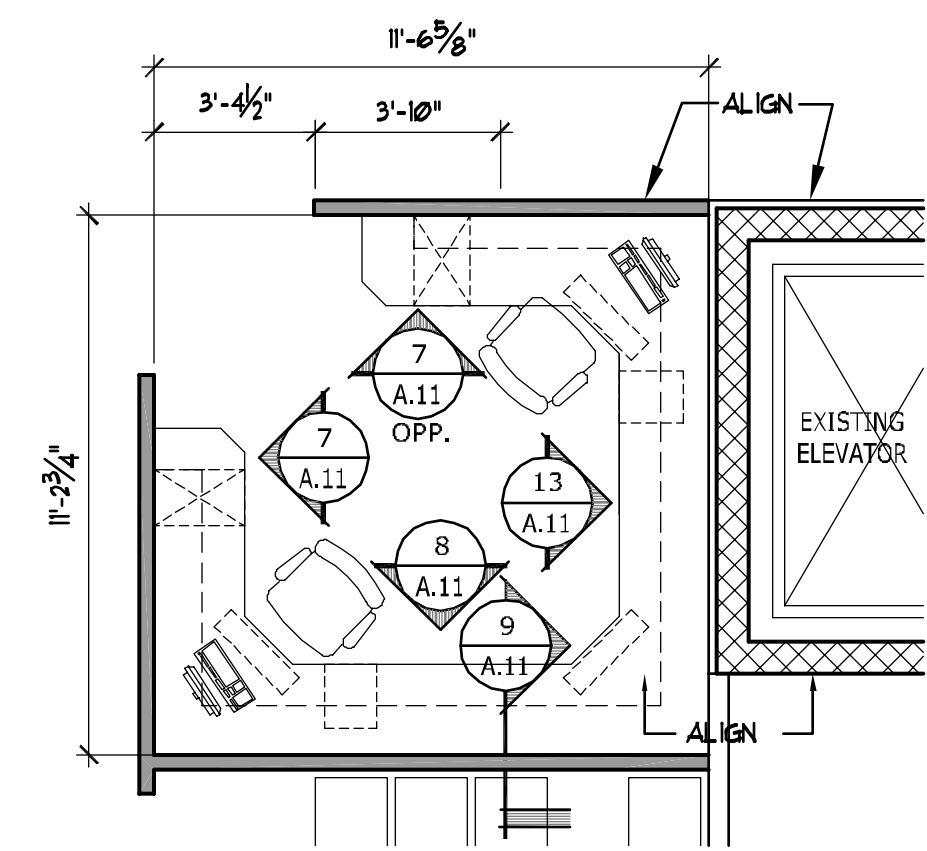
7 TRIAGE ROOM  
A.11 SCALE: 1/4" = 1'-0" 102



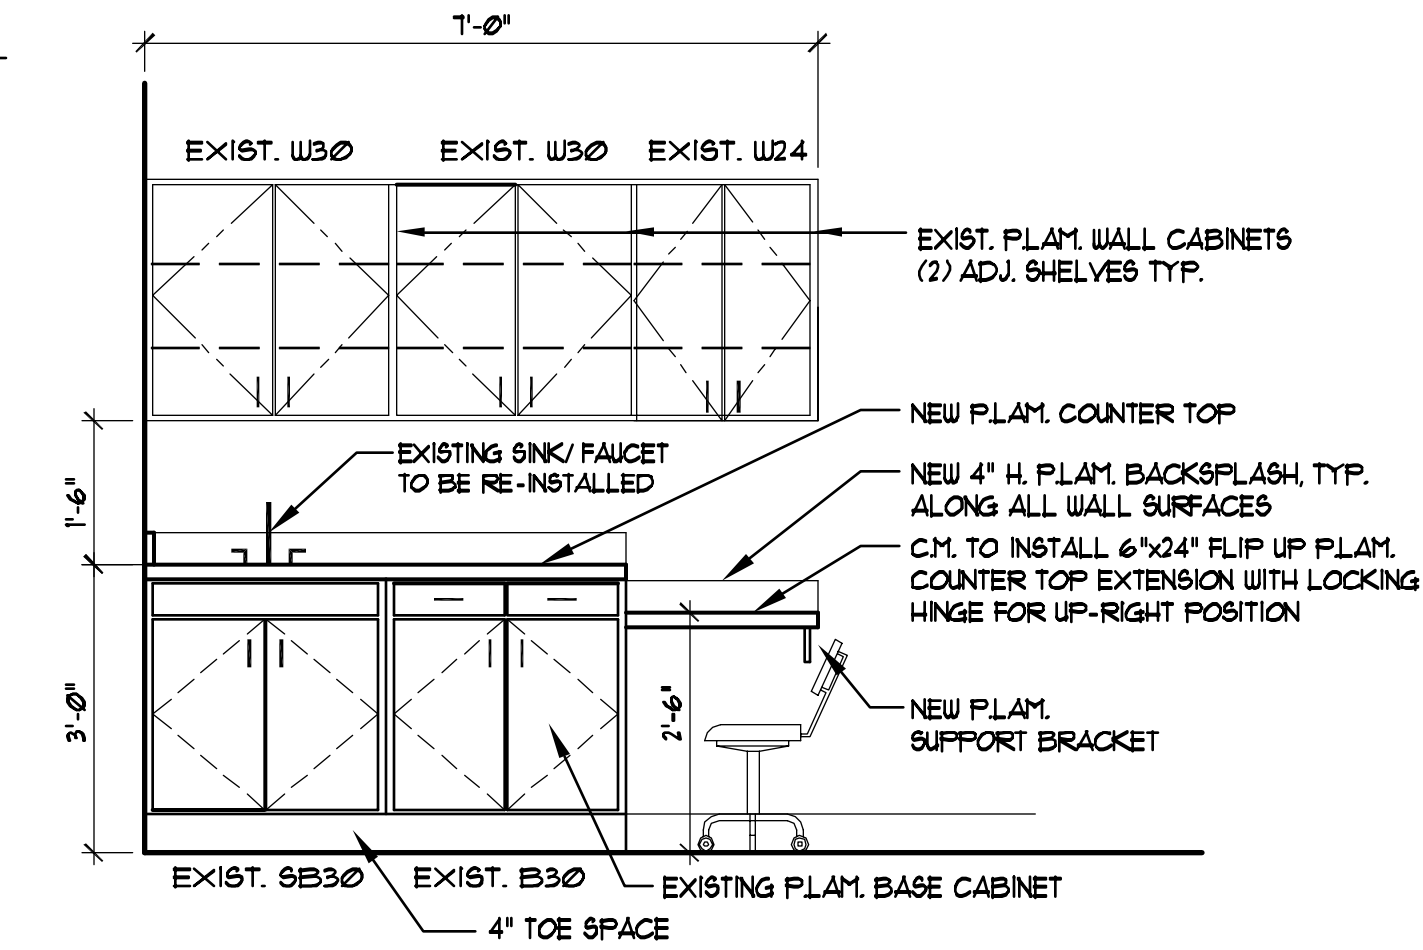
6 TRIAGE ROOM  
A.11 SCALE: 1/4" = 1'-0" 102



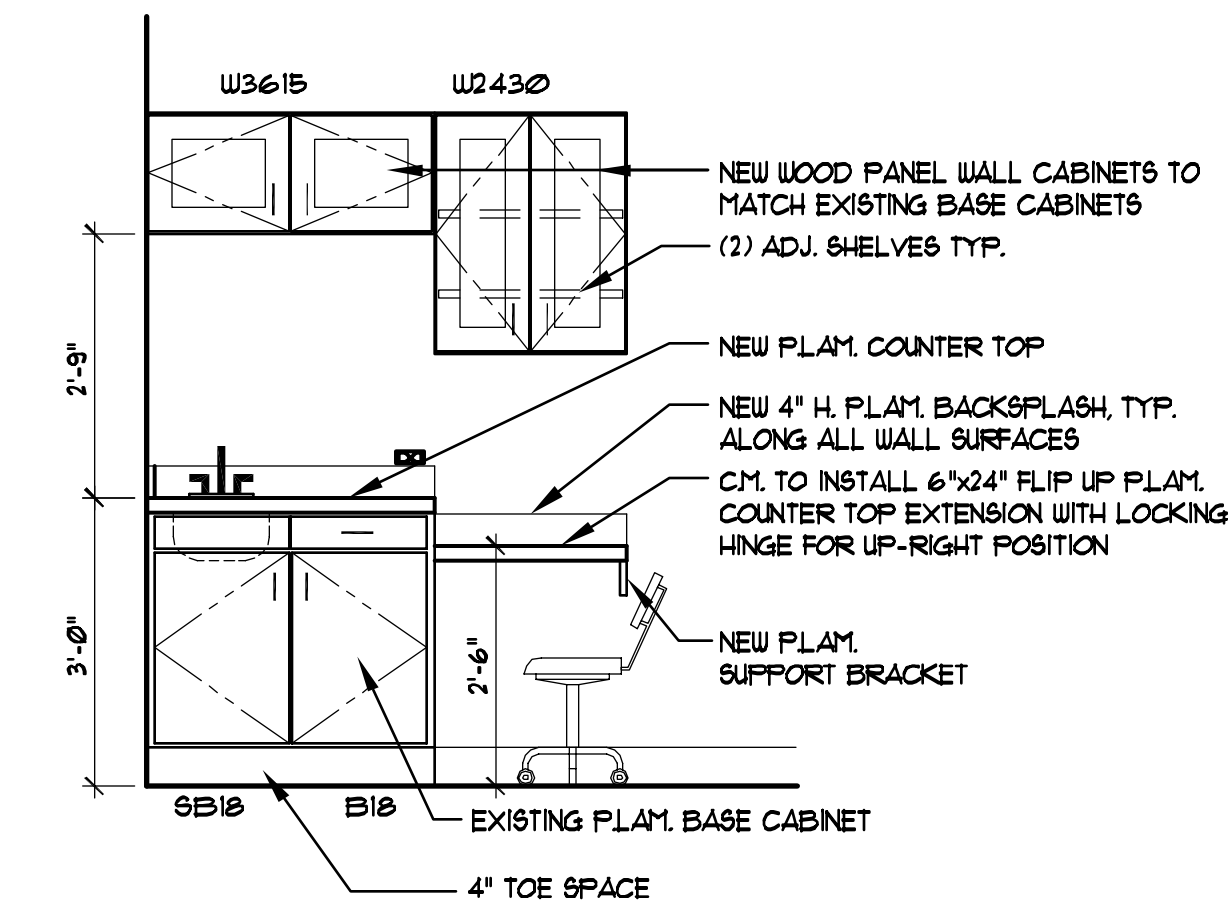
5 TYPICAL PROCEDURE ROOM  
A.11 SCALE: 1/2" = 1'-0" 102



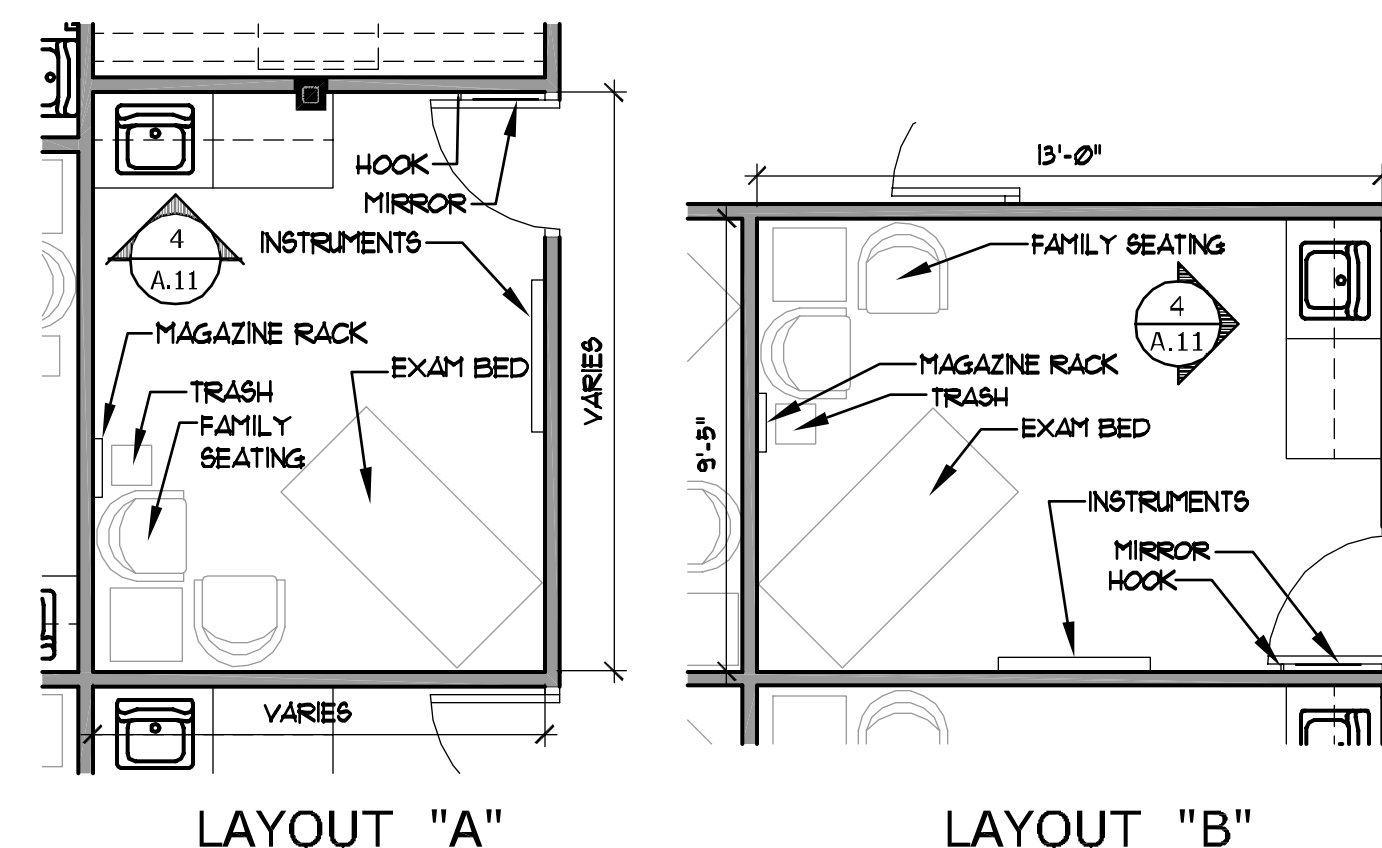
4 TYPICAL EXAM ROOM  
A.11 SCALE: 1/2" = 1'-0" 102



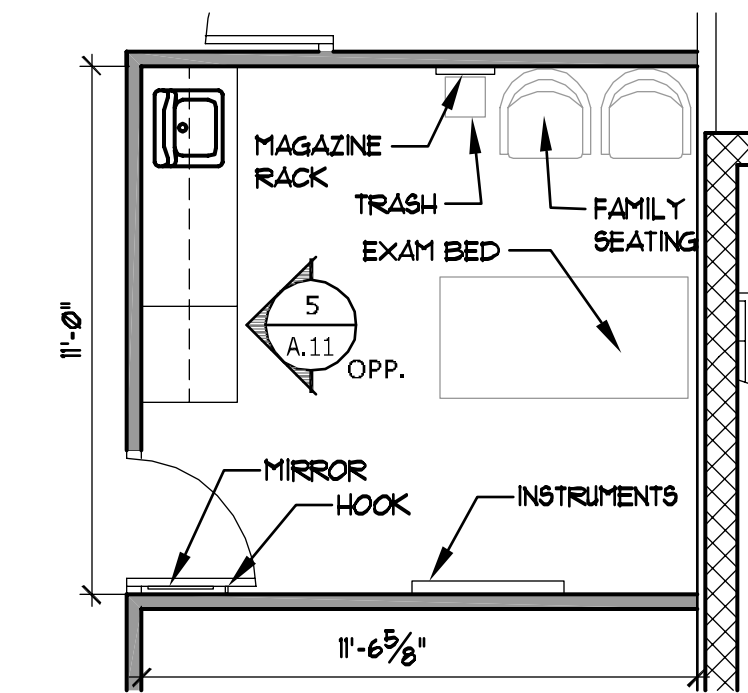3 TYPICAL EXAM ROOM  
A.11 SCALE: 1/4" = 1'-0" 102



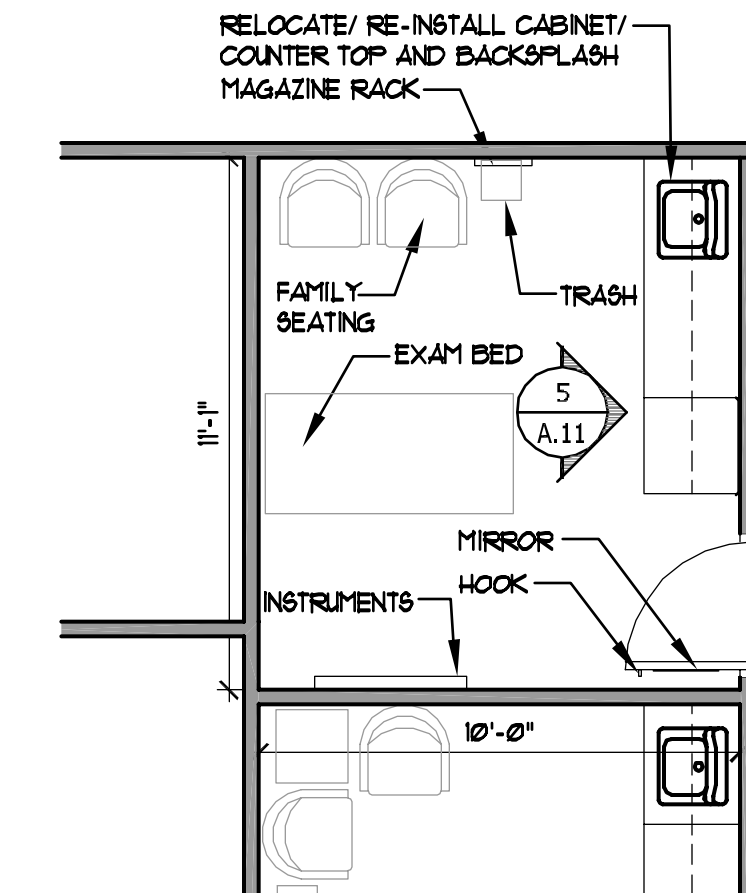2 PROCEDURE ROOM  
A.11 SCALE: 1/4" = 1'-0" 113





1 PROCEDURE ROOM  
A.11 SCALE: 1/4" = 1'-0" 102


EXISTING MILLWORK RELOCATED AND RE-INSTALLED

EXISTING MILLWORK RELOCATED AND RE-INSTALLED

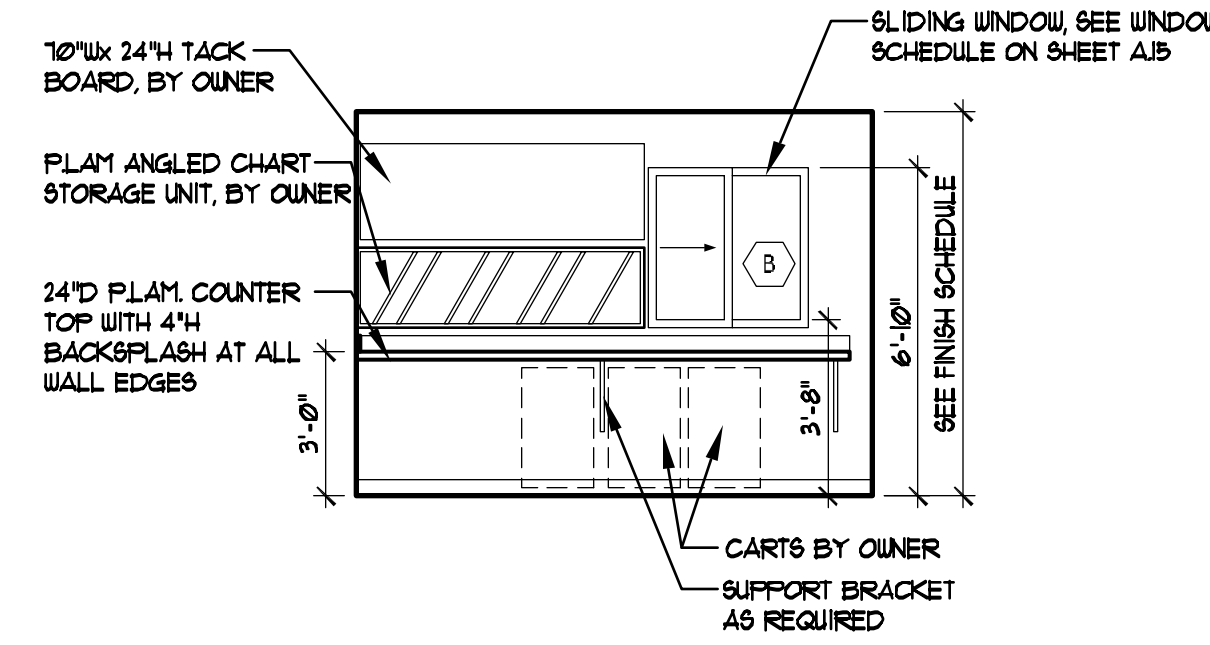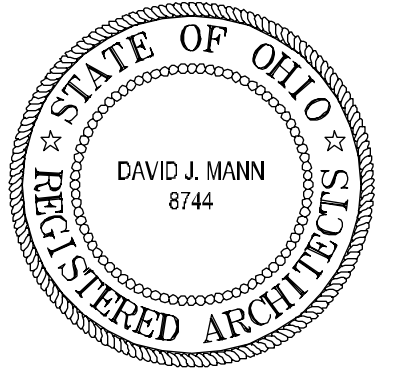
EXISTING MILLWORK RELOCATED AND RE-INSTALLED



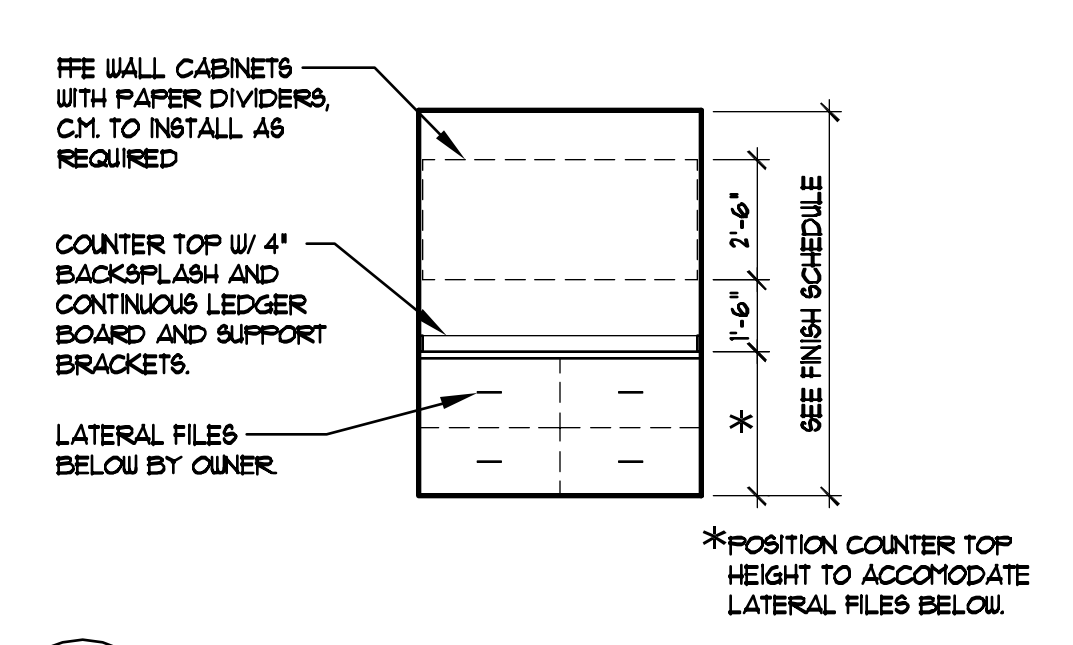
16 MA STAGING  
A.12 SCALE: 1/4" = 1'-0" 106



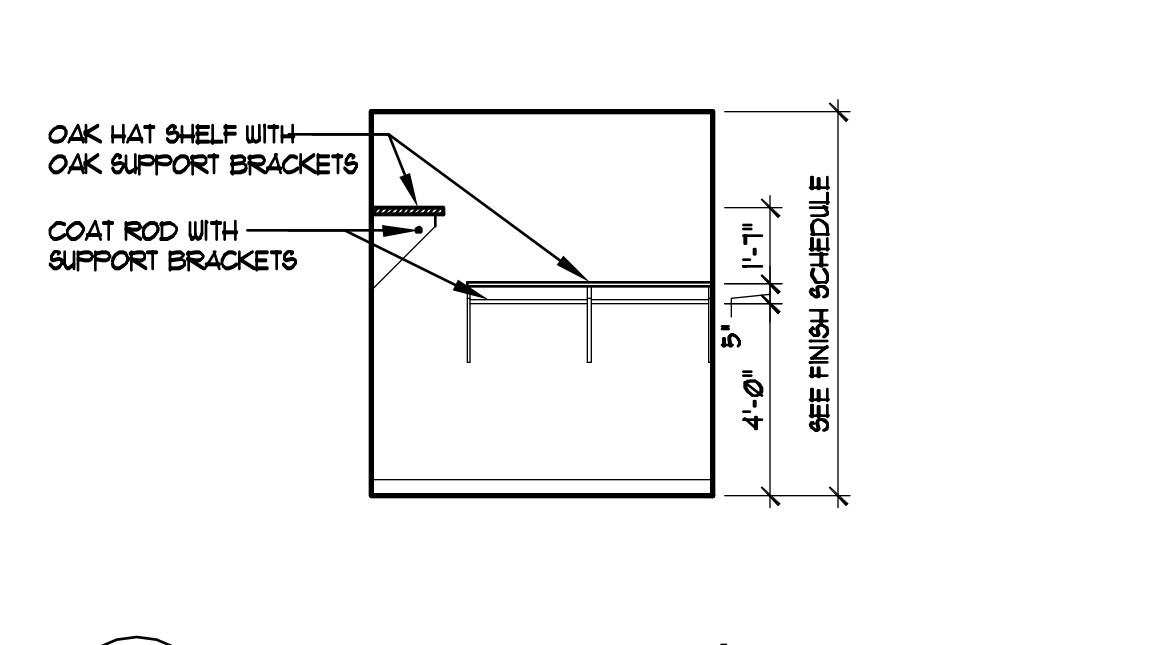
11 INFORMATION  
A.12 SCALE: 1/4" = 1'-0" 112



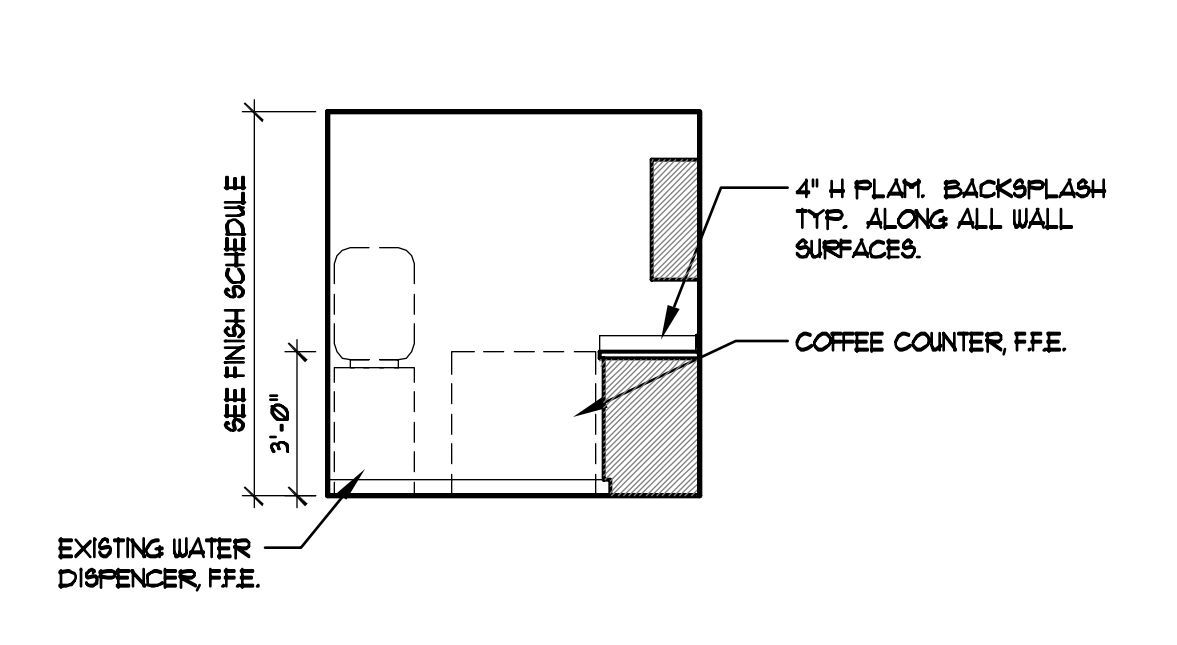
8 WHEELCHAIR / COATS (SOUTH WALL)  
A.12 SCALE: 1/4" = 1'-0" 159



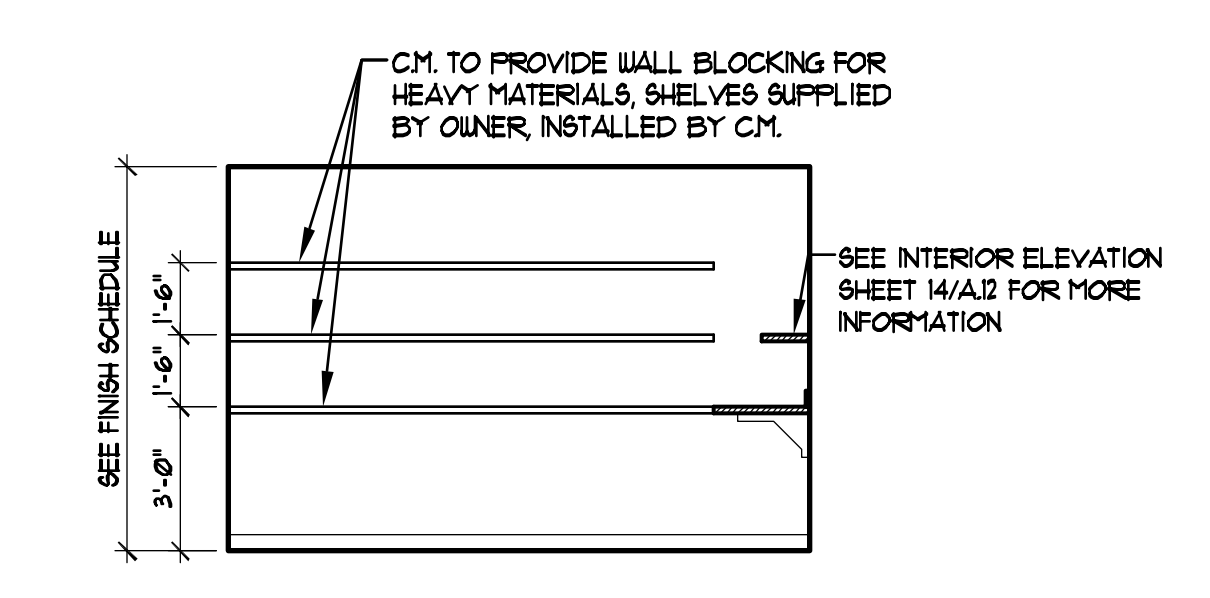
4 COFFEE AREA  
A.12 SCALE: 1/4" = 1'-0" 102A



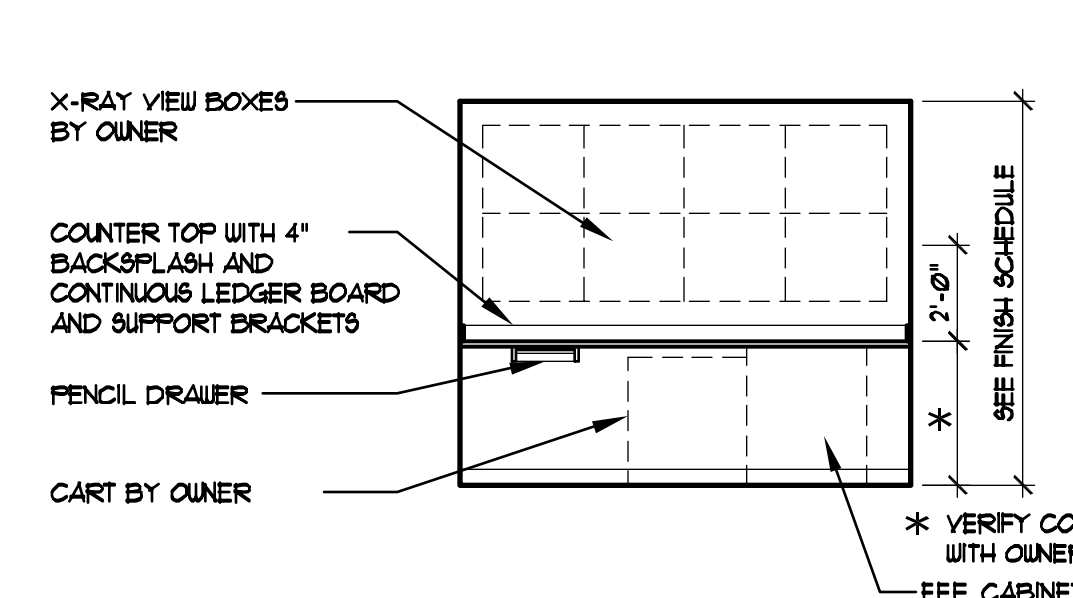
15 STORAGE  
A.12 SCALE: 1/4" = 1'-0" C11



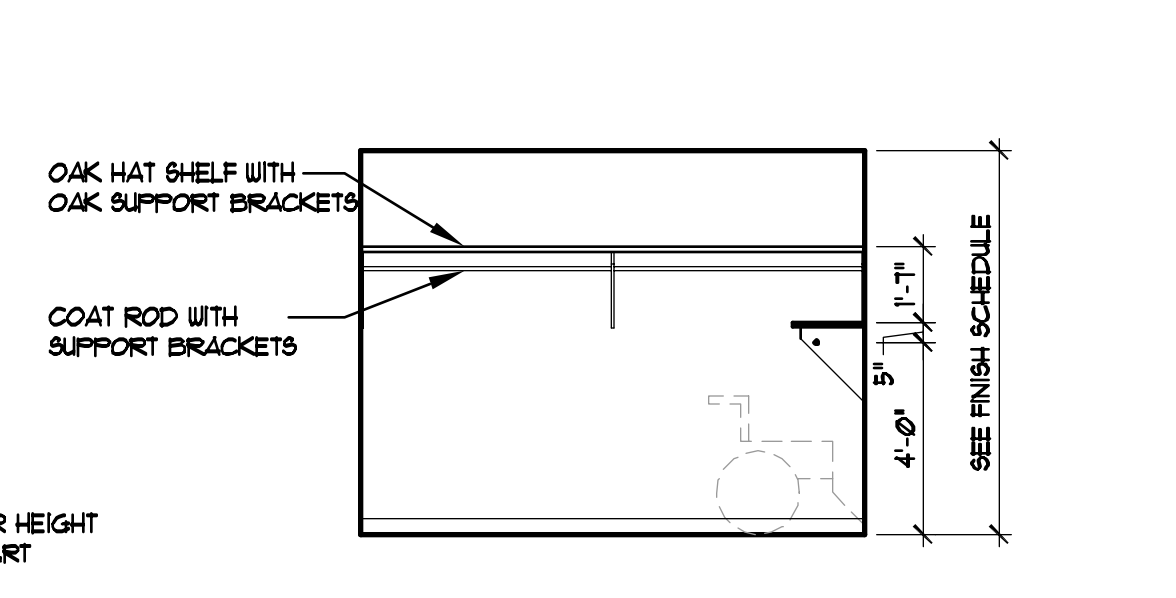
10 ADMINISTRATION  
A.12 SCALE: 1/4" = 1'-0" 120



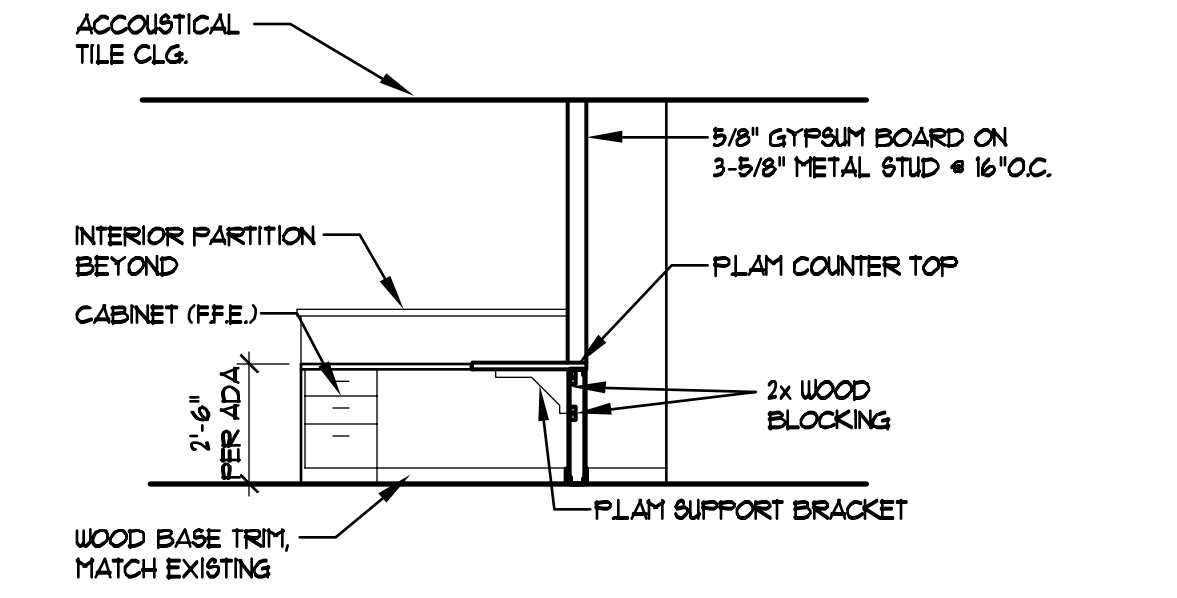
7 WHEELCHAIR / COATS (EAST WALL)  
A.12 SCALE: 1/4" = 1'-0" 159



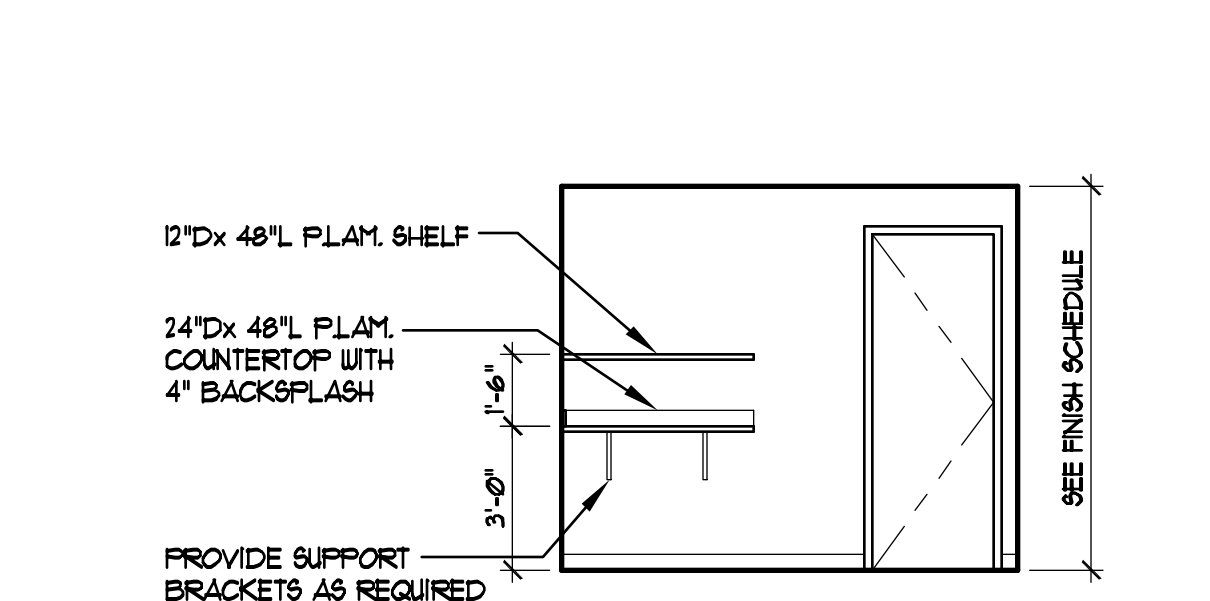
3 SECTION  
A.12 SCALE: 1/4" = 1'-0" 128



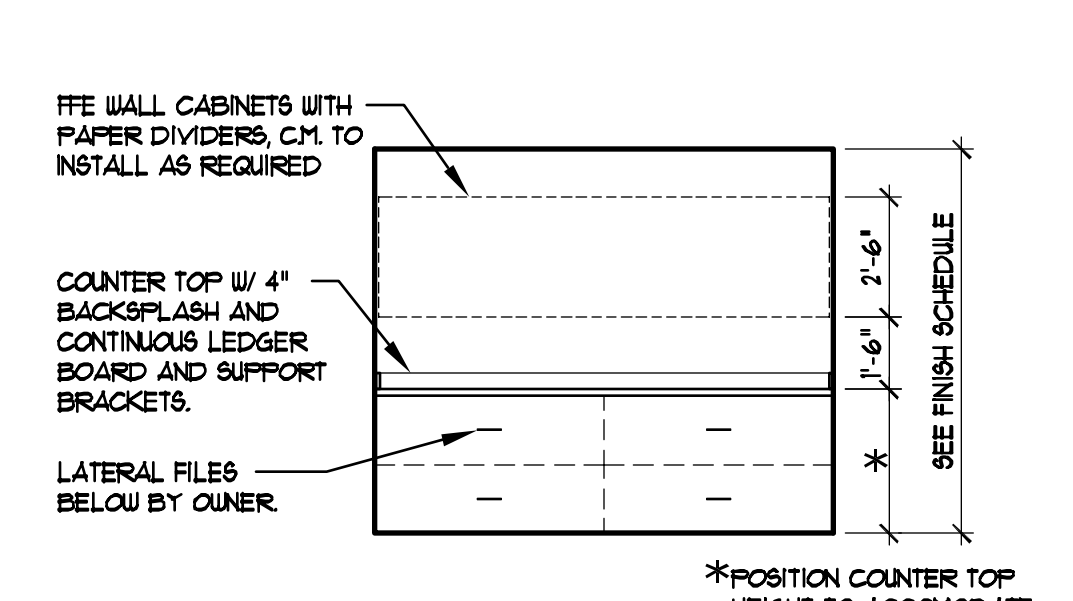
14 STORAGE  
A.12 SCALE: 1/4" = 1'-0" C11



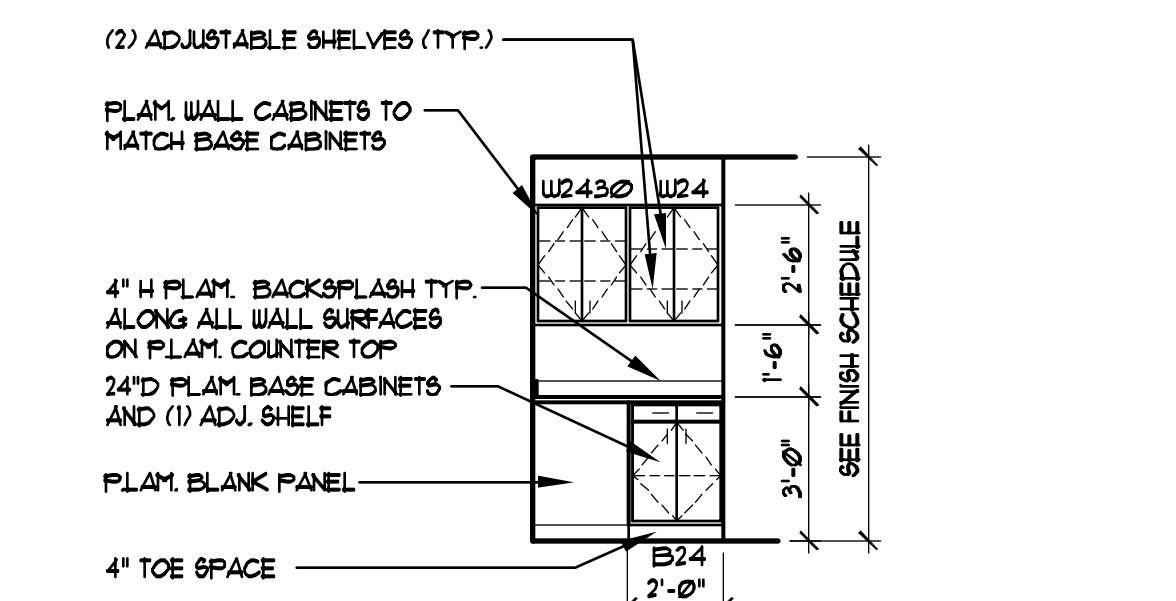
9 INFORMATION  
A.12 SCALE: 1/4" = 1'-0" 119



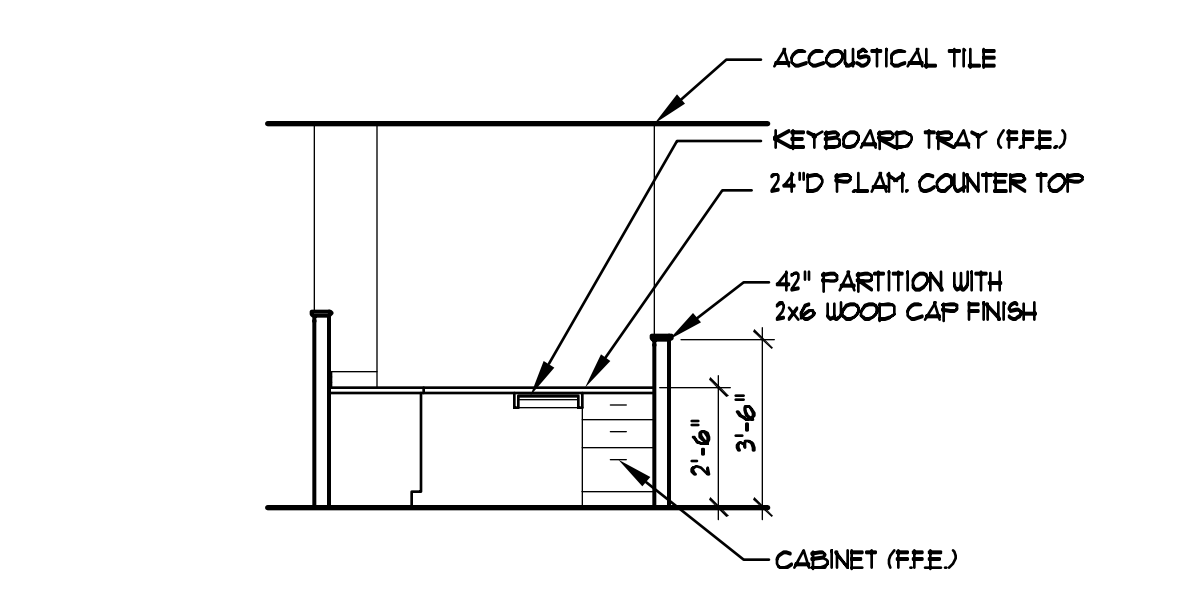
6 COFFEE AREA  
A.12 SCALE: 1/4" = 1'-0" 102A



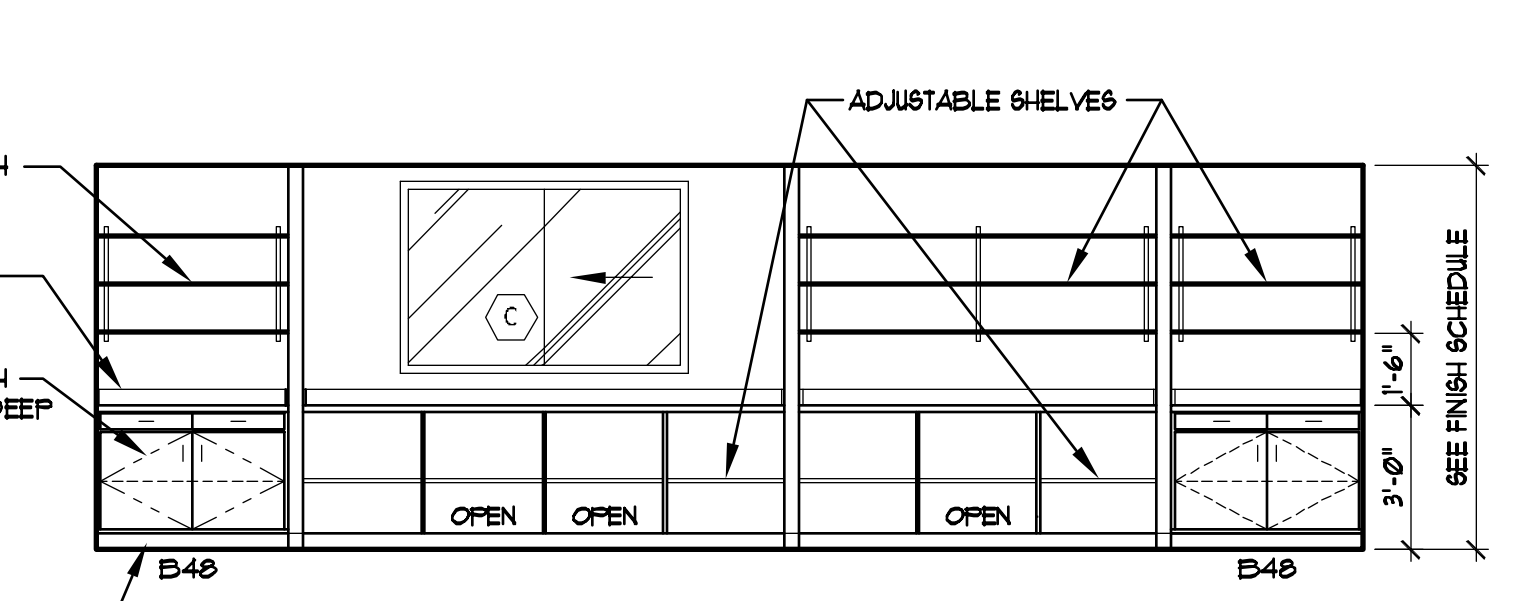
2 ELEVATION  
A.12 SCALE: 1/4" = 1'-0" 128



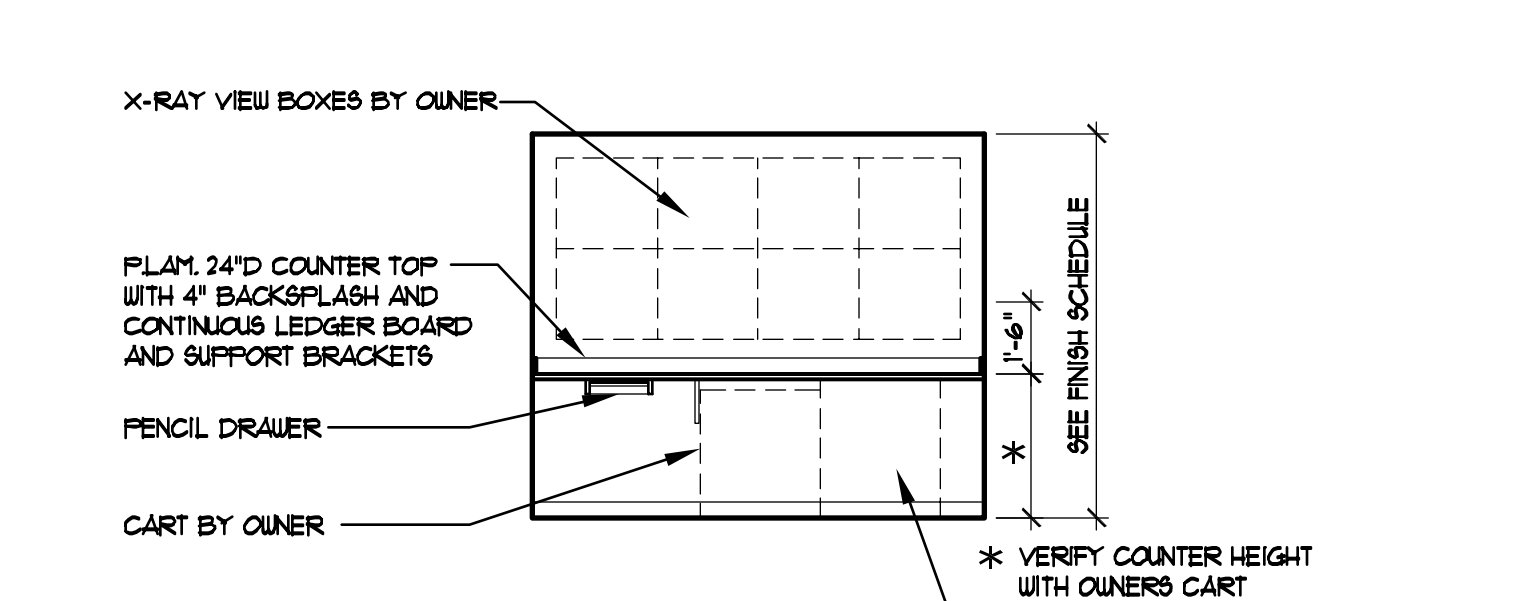
13 NURSES STATION  
A.12 SCALE: 1/4" = 1'-0" C18



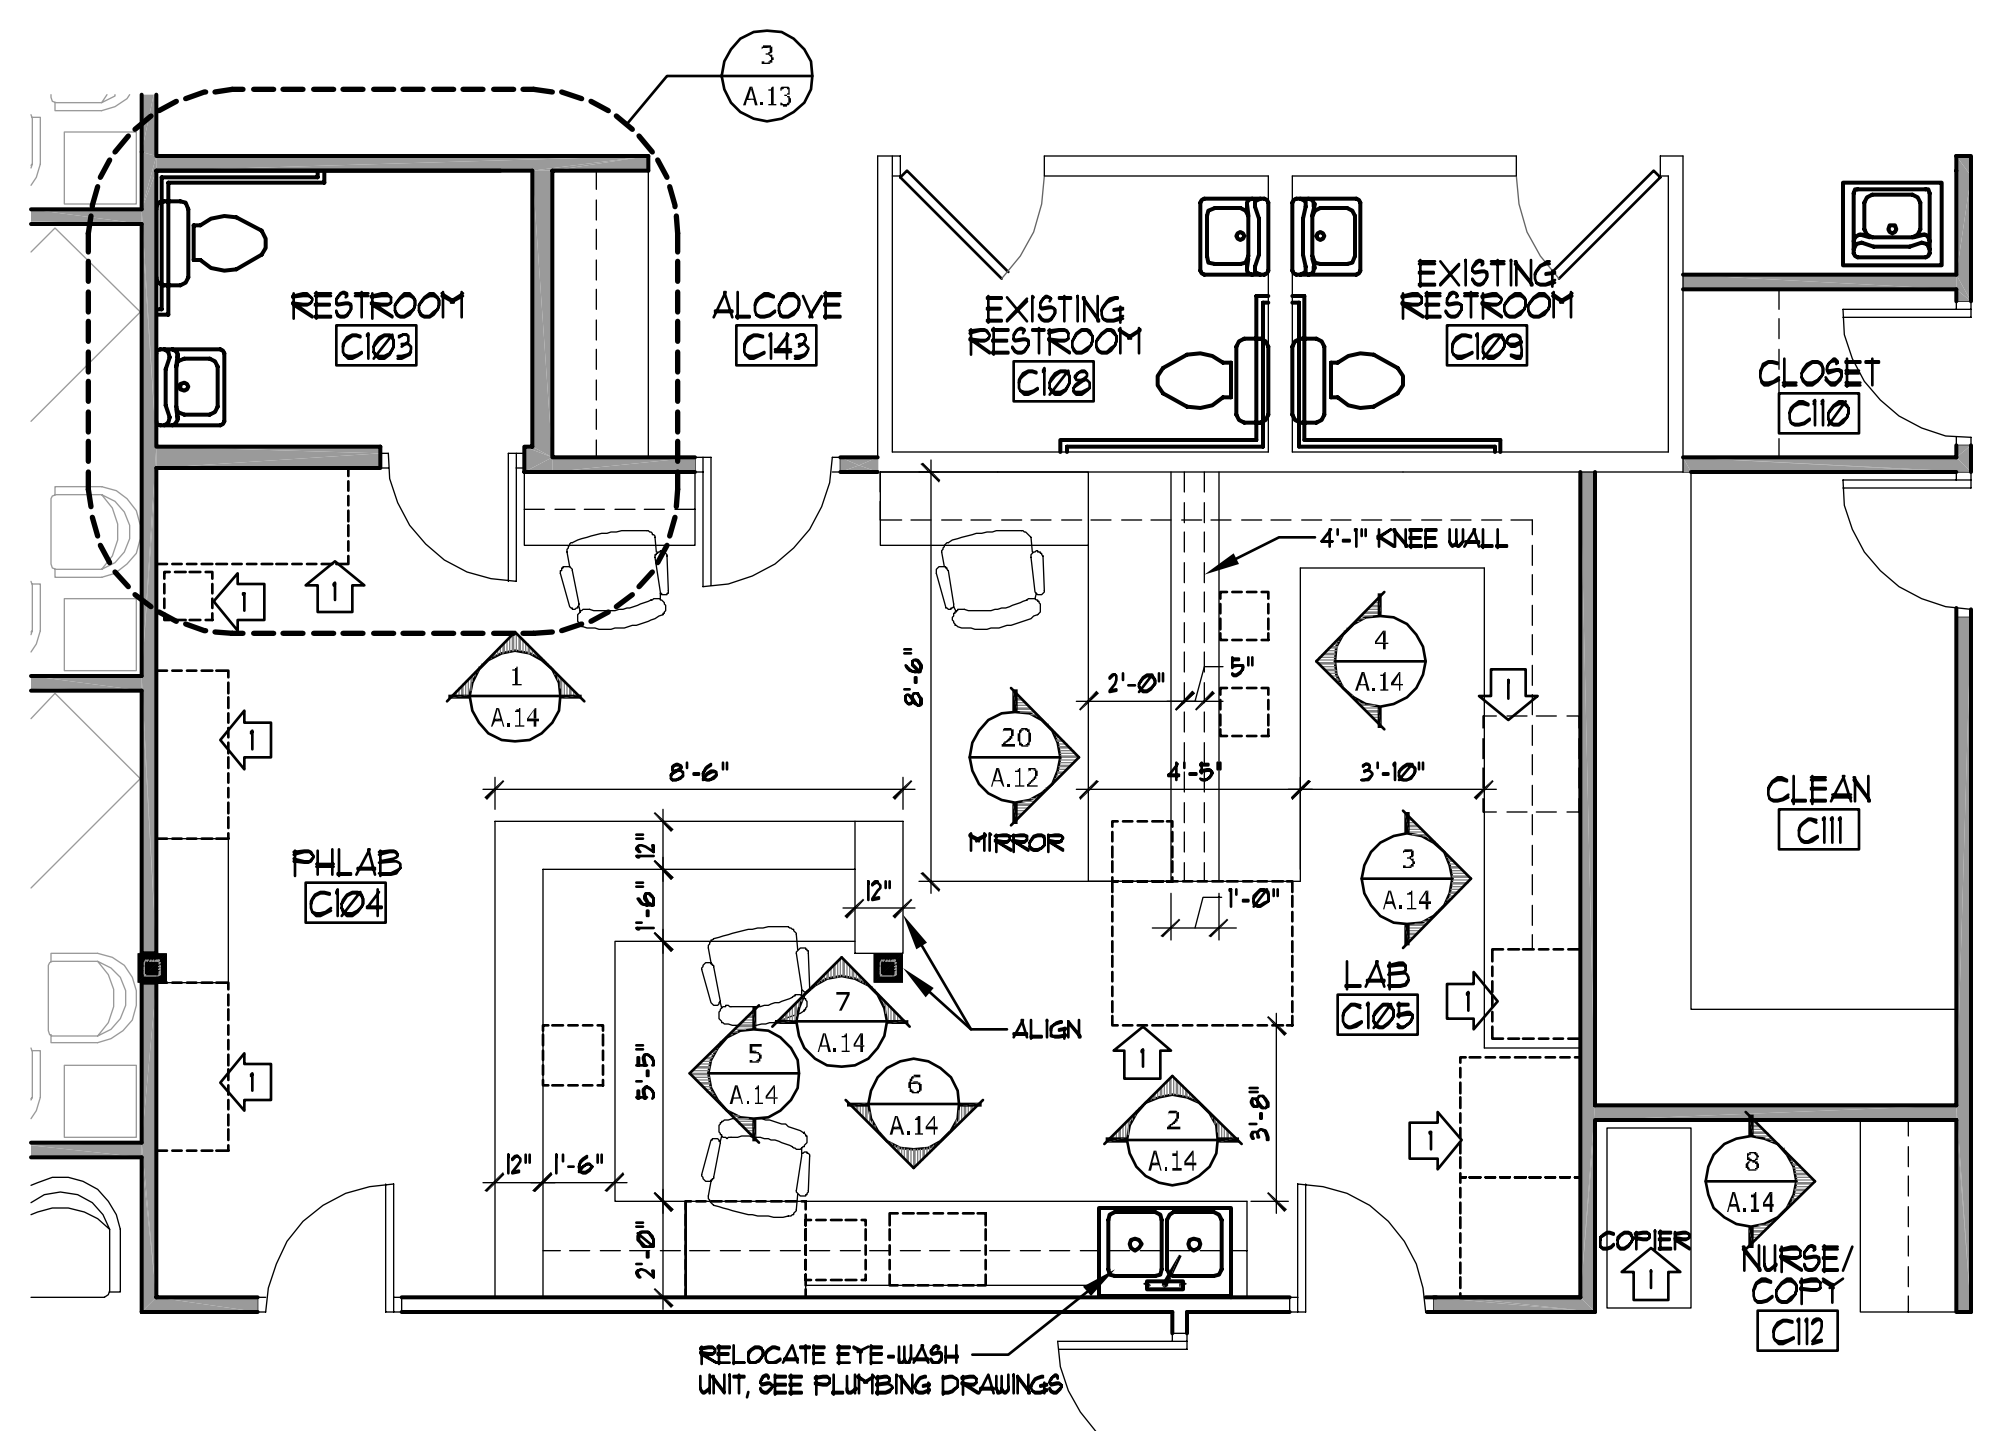
12 ADMINISTRATION  
A.12 SCALE: 1/4" = 1'-0" 111



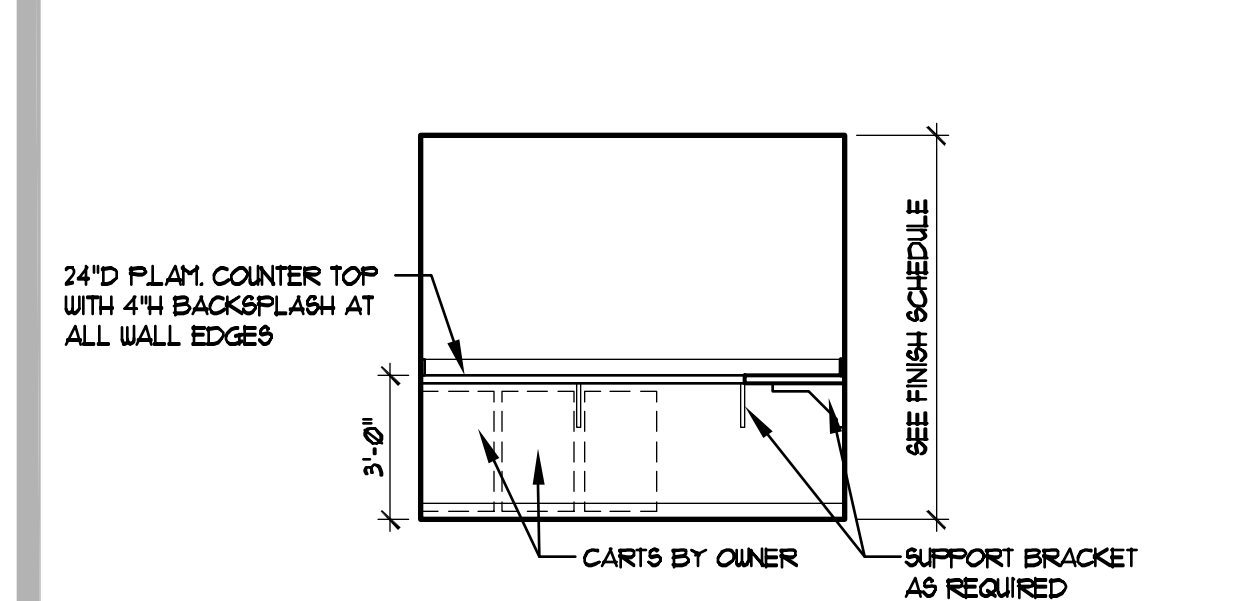5 ENLARGED LAB PLAN  
A.12 SCALE: 1/4" = 1'-0" 128



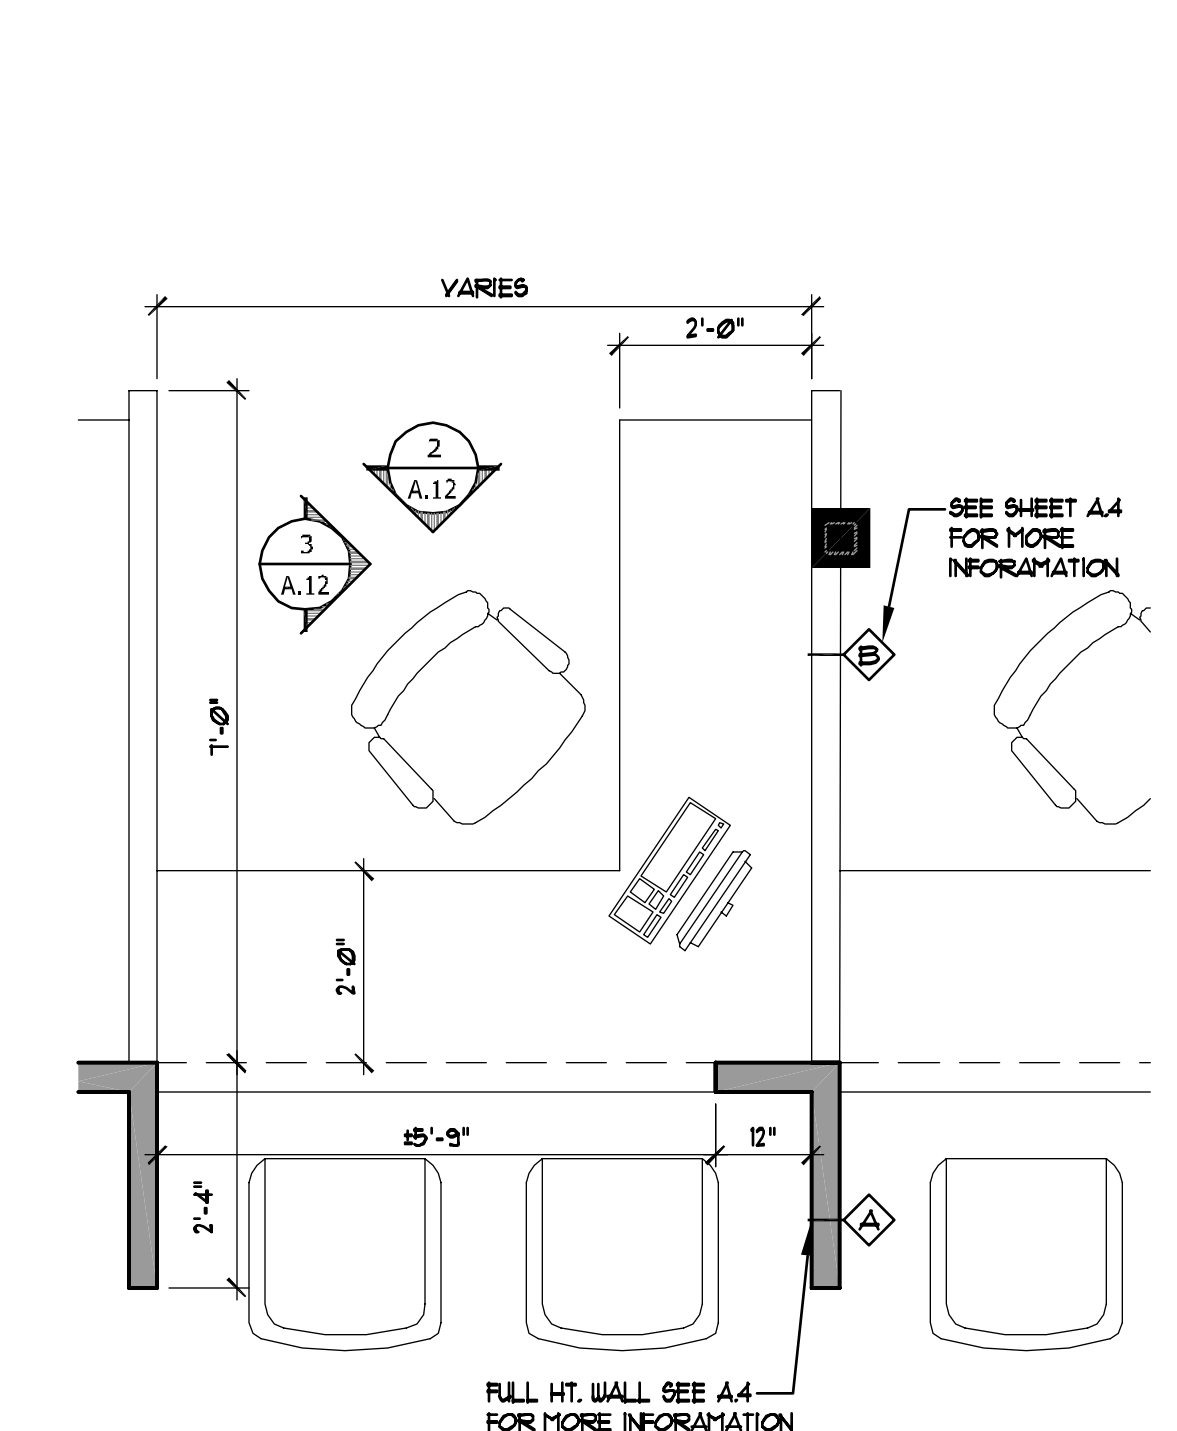
17 MA STAGING  
A.12 SCALE: 1/4" = 1'-0" 106



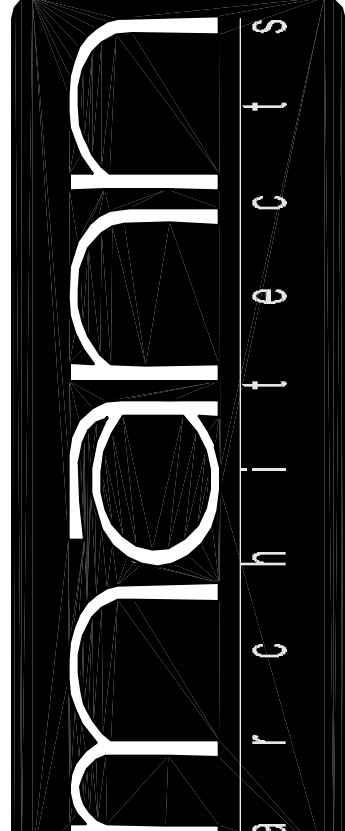1 REGISTER/SCHEDULE  
A.12 SCALE: 1/4" = 1'-0" 128

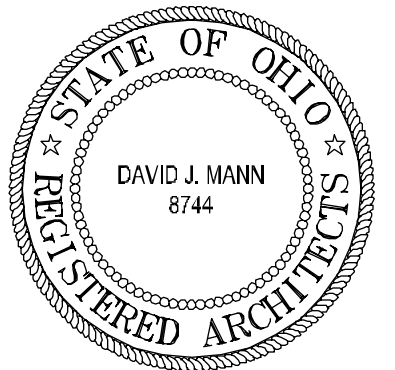
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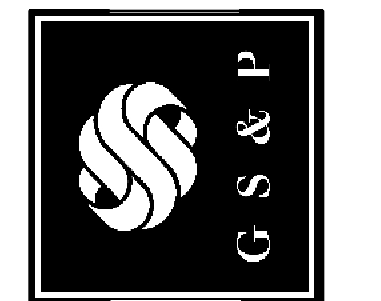
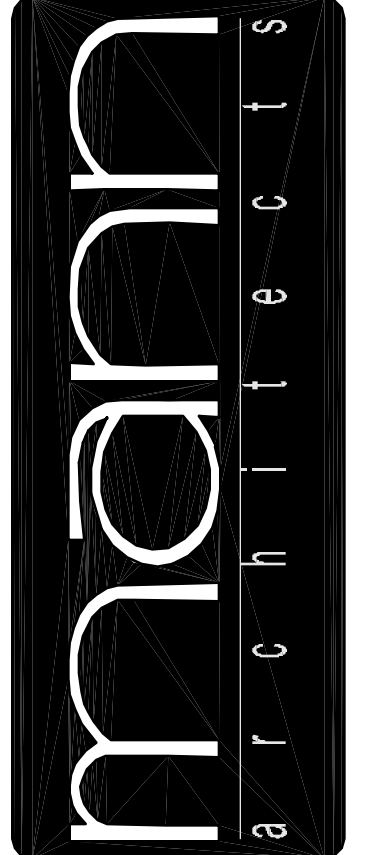
drawing  
ENLARGED ROOMS & INTERIOR ELEV.  
project no. 11406  
date OCTOBER 23, 2001  
scale AS NOTED  
AS NOTED  
COLUMBUS ONCOLOGY  
JASONIAT PROFESSIONAL BUILDING  
810 JASONIAT AVENUE SUITE A  
COLUMBUS, OHIO 43214-2329  
project

A.12  
OF 18  
sheet no.



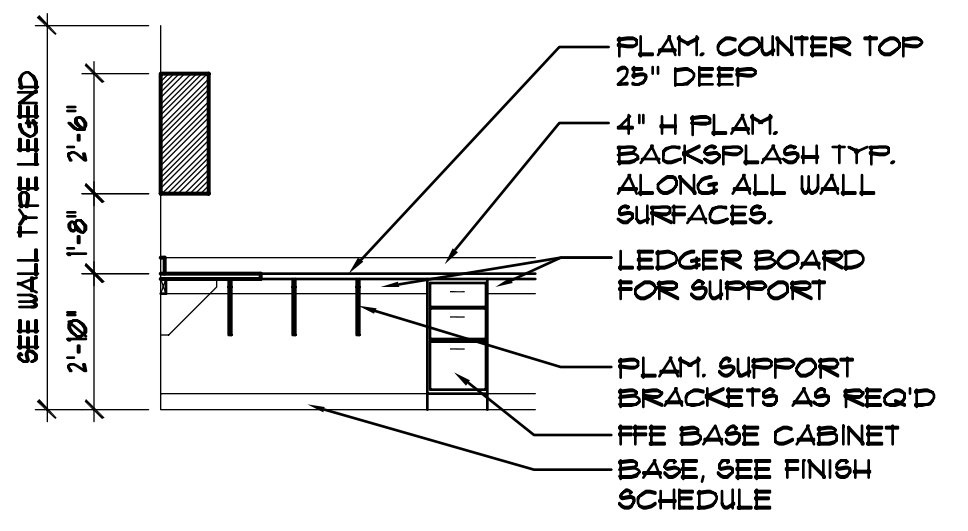
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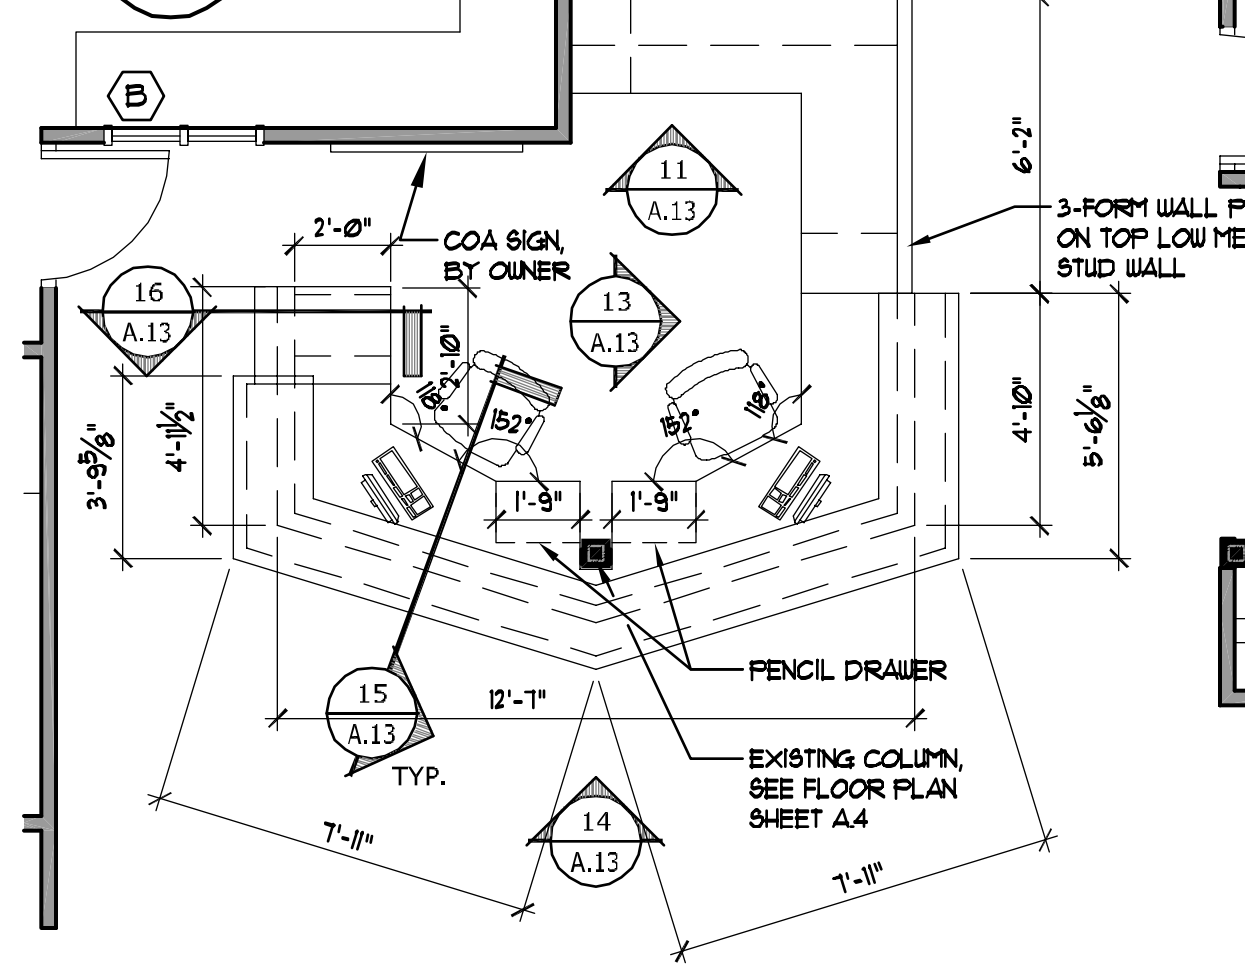


drawing  
ENLARGED ROOMS & INTERIOR ELV.  
project no. 11406  
date OCTOBER 23, 2001  
scale AS NOTED  
AS NOTED  
COLUMBUS ONCOLOGY  
JASONIAT PROFESSIONAL BUILDING  
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COLUMBUS, OHIO 43214-2329  
project

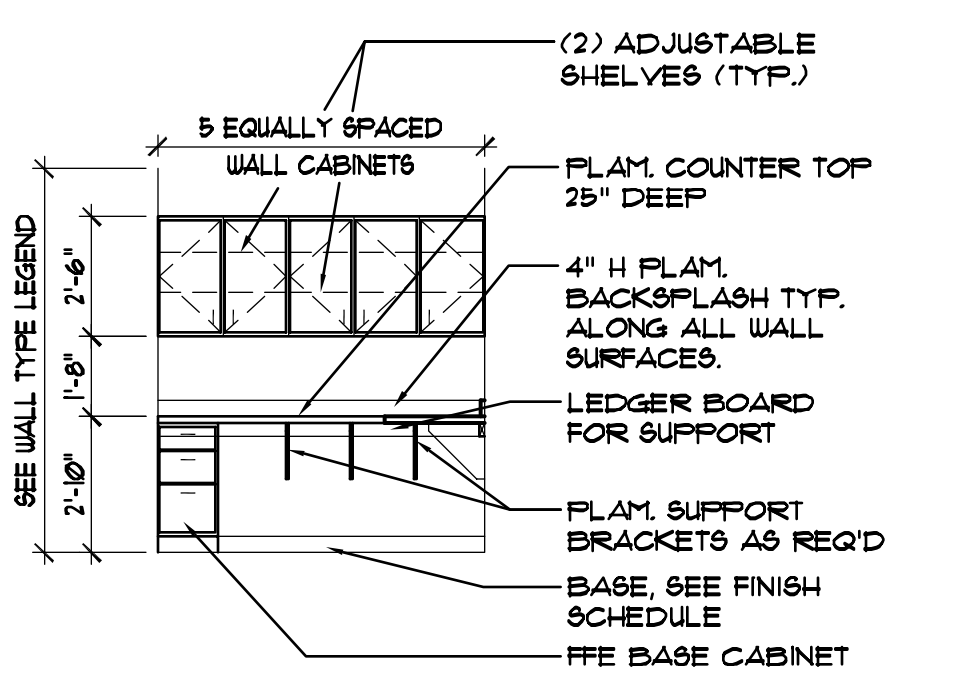
A.13  
OF 18  
sheet no.




13 RECEPTION ELEVATION  
A.13 SCALE: 1/4" = 1'-0"



12 RECEPTION RM 103  
A.13 SCALE: 1/4" = 1'-0"




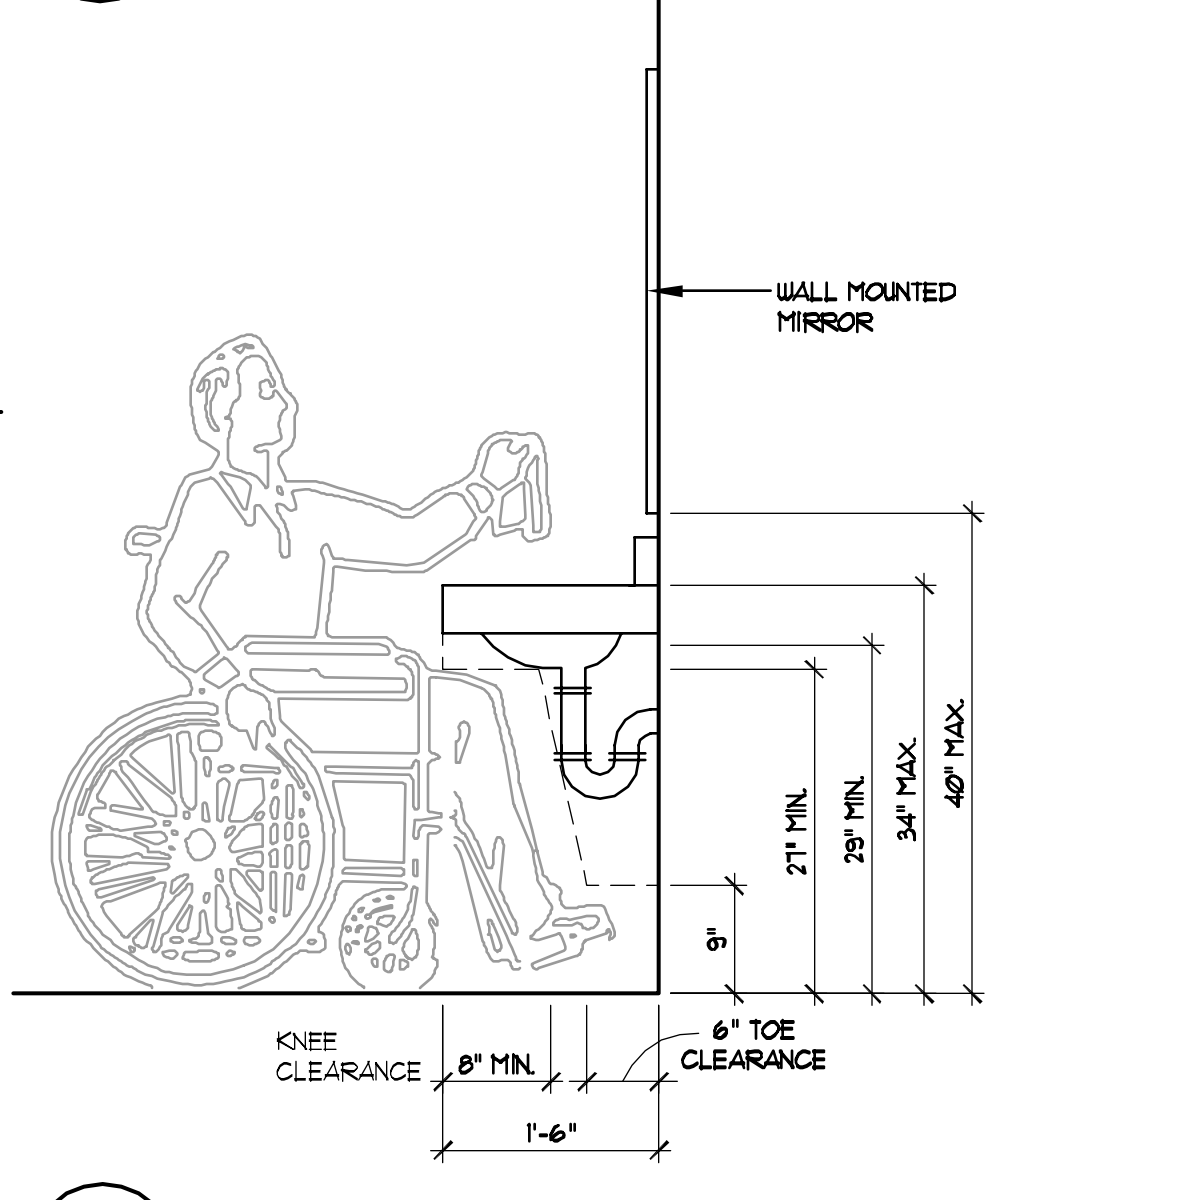11 RECEPTION ELEVATION  
A.13 SCALE: 1/4" = 1'-0"




10 RESTROOM ELEVATION, TYPICAL  
A.13 SCALE: 3/4" = 1'-0"

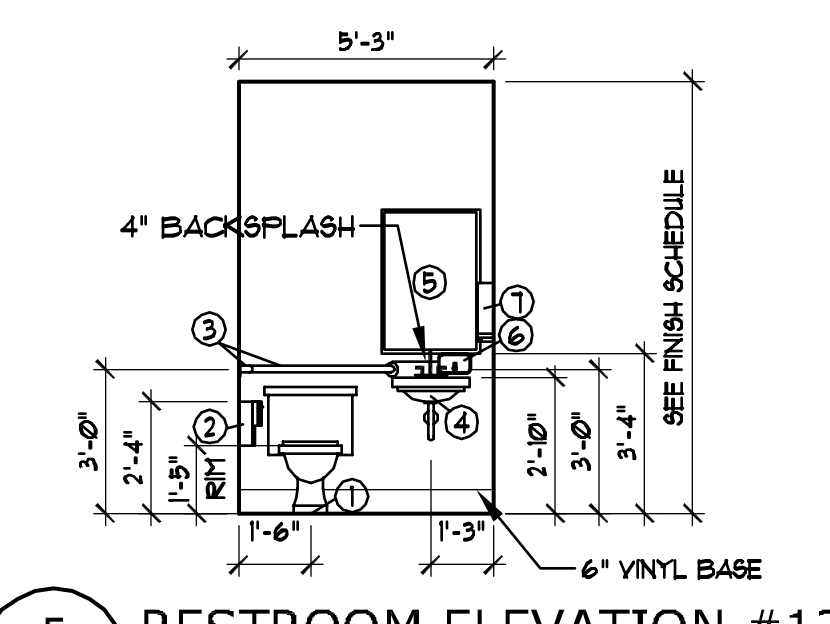
- INTERIOR ELEVATIONS)
- H.C. TOILET W/ ELONGATED OPEN FRONT SEAT, RE-USE EXISTING. SEE PLUMBING DRAWINGS.
  - TOILET TISSUE DISPENSER (MTD. 36" FROM PLUMBING WALL, RE-USE EXISTING, SEE PLUMBING DRAWINGS.
  - STAINLESS STEEL H.C. TOILET GRAB BAR SET W/ SATIN FINISHED SURFACE. ONE 36" L. BEHIND WATER CLOSET (MTD. MAX 6" FROM SIDE WALL AND 36" AFF. TO Ⓡ), ONE 42" L. GRAB BAR ON SIDE WALL (MTD. 12" MIN. FROM BACK OF WATER CLOSET AND 36" AFF. TO Ⓡ), RE-USE EXISTING, SEE PLUMBING DRAWINGS.
  - WALL MOUNTED LAVATORY, PROVIDE SUPPORT BRACKETS AS REQUIRED (MTD. TOP OF LAVATORY 34" AFF.). RE-USE EXISTING, SEE PLUMBING DRAWINGS.
  - MIRROR, MOUNT BOTTOM 40" AFF. MAX, RE-USE EXISTING.
  - SOAP DISPENSER, (MOUNT 36" AFF. TO HIGHEST OPERABLE PART), RE-USE EXISTING.
  - PAPER TOWEL DISPENSER IN RESTROOMS AND ALL EXAM ROOMS, (MOUNT 44" AFF. TO HIGHEST OPERABLE PART/DISPENSER OPENING), RE-USE EXISTING.
- \* PROVIDE FRUW BLOCKING BEHIND ALL ACCESSORIES BEING ATTACHED TO THE WALL. MOUNT W/ CONCEALED FASTENERS WHENEVER POSSIBLE.
- \* CONTRACTOR SHALL REFER TO PLUMBING DRAWINGS AND SPECIFICATIONS FOR SPECIFIC INFORMATION ON THE ABOVE PLUMBING FIXTURES.



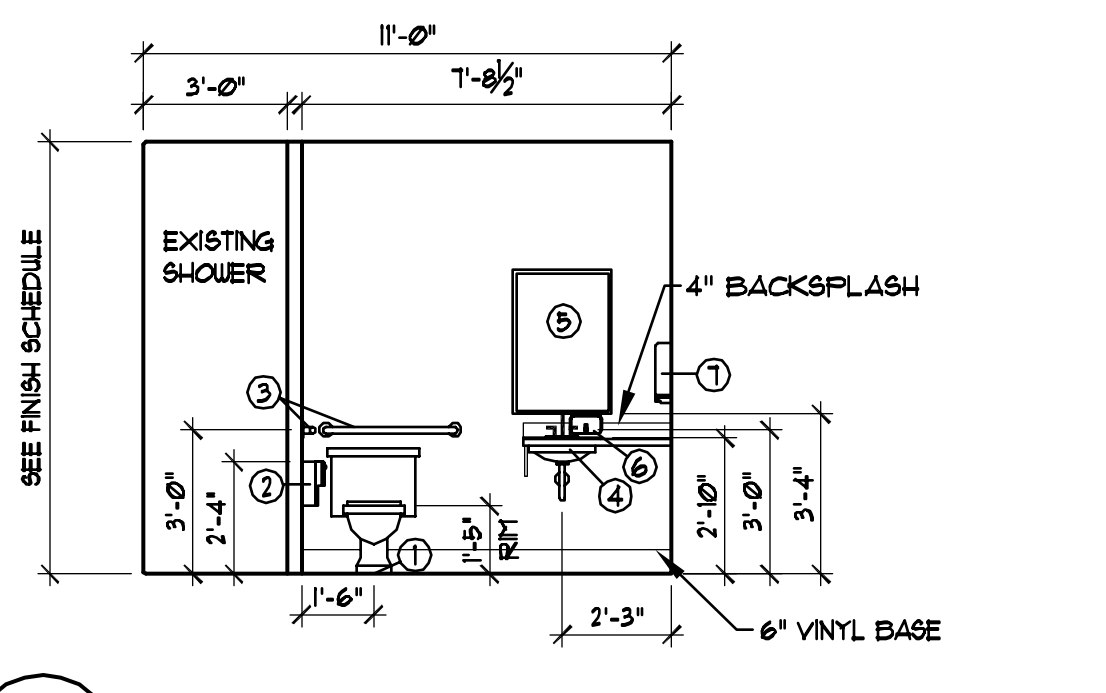
5 RESTROOM ELEVATION #135  
A.13 SCALE: 1/4" = 1'-0"



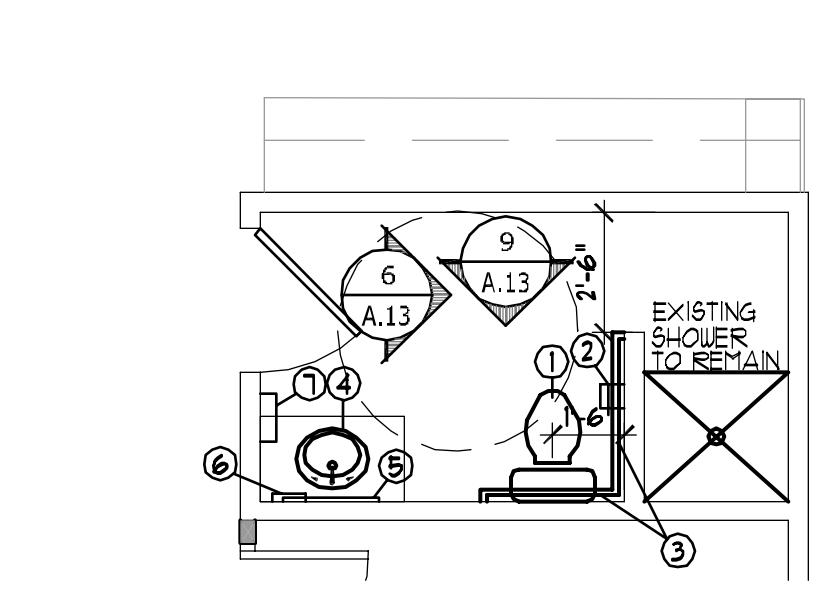
9 RESTROOM ELEVATION #213  
A.13 SCALE: 1/4" = 1'-0"



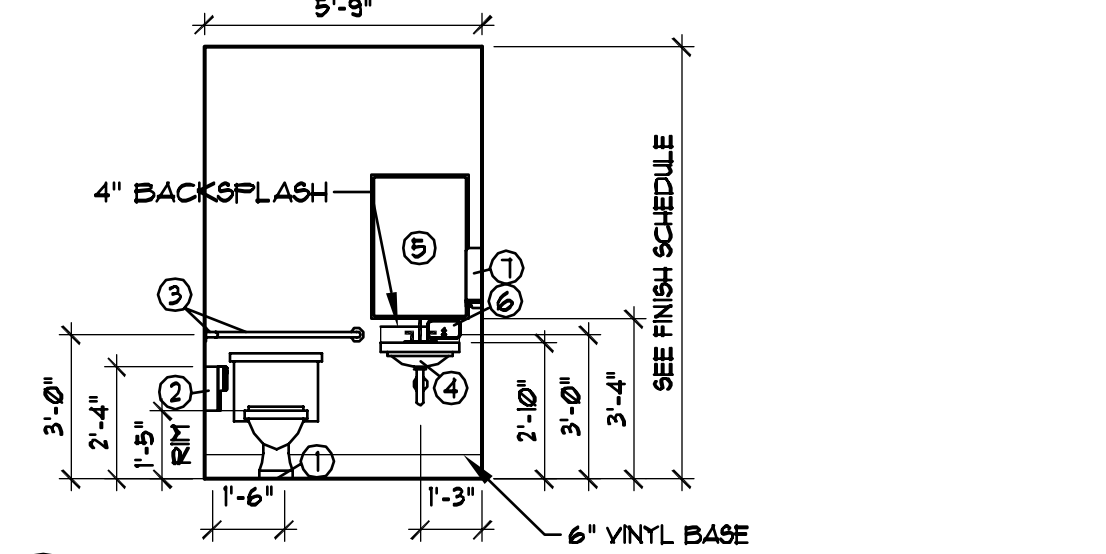
4 RESTROOM #207 (EXISTING RESTROOM - SEE ROOM FINISH SCHEDULE)  
A.13 SCALE: 1/4" = 1'-0"



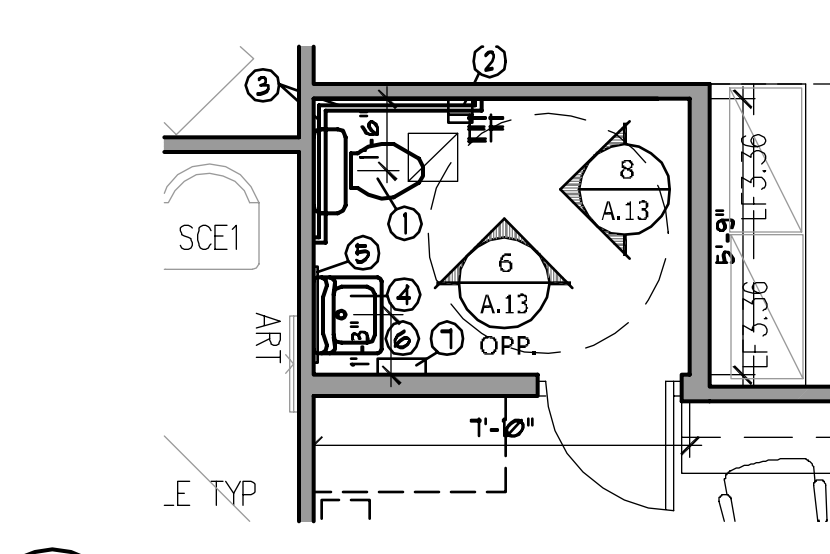
8 RESTROOM ELEVATION #C103  
A.13 SCALE: 1/4" = 1'-0"



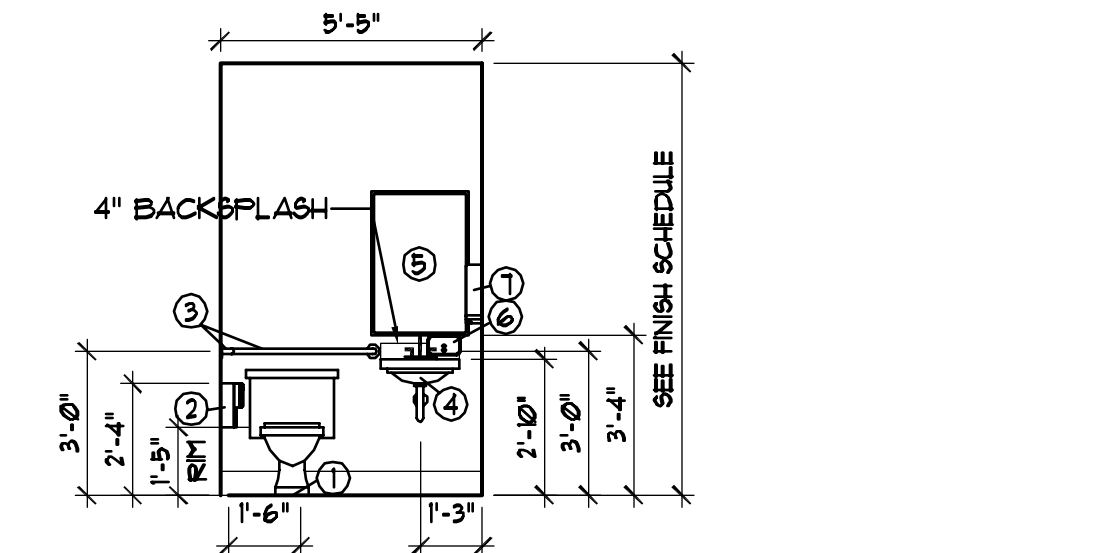
3 STAFF RESTROOM #C103  
A.13 SCALE: 1/4" = 1'-0"



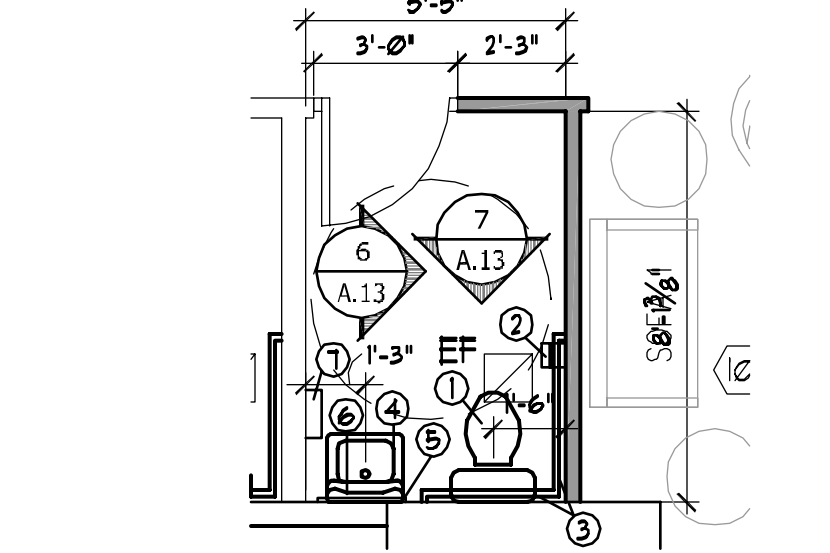
7 RESTROOM ELEVATION #181  
A.13.0 SCALE: 1/4" = 1'-0"



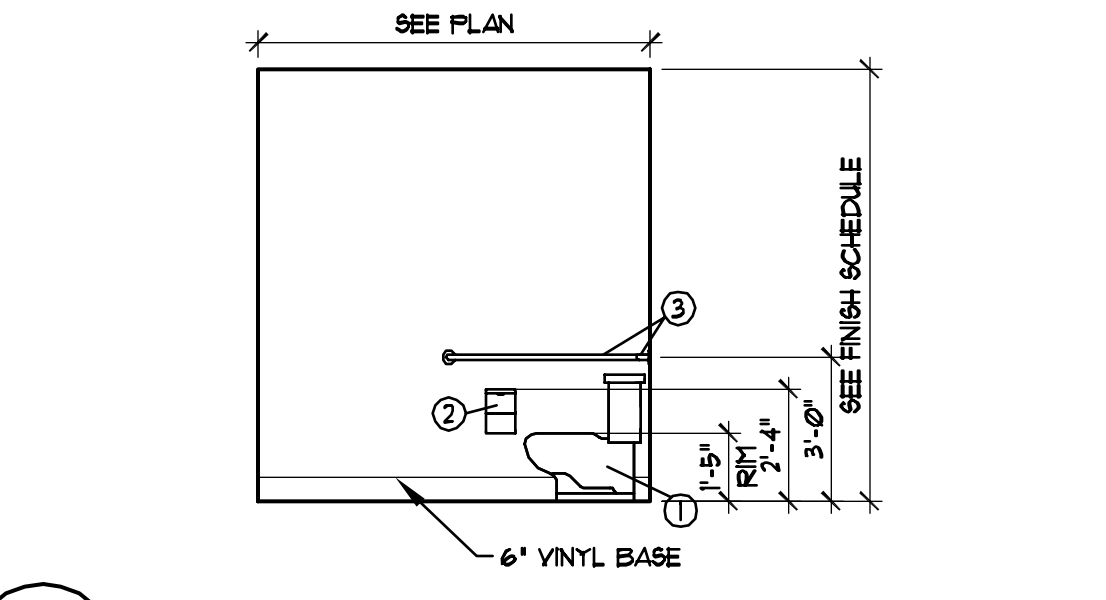
2 MEN'S RESTROOM #181  
A.13 SCALE: 1/4" = 1'-0"



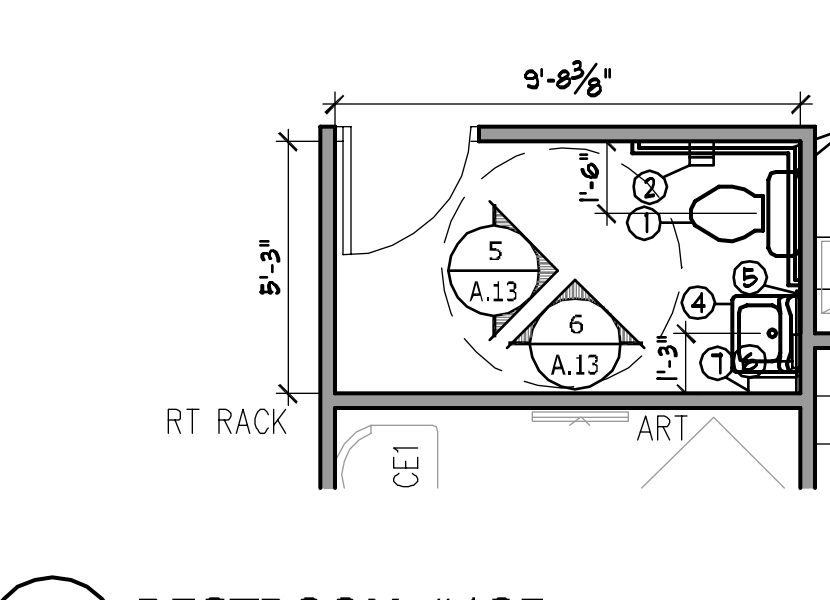
6 TOILET ELEVATION TYPICAL  
A.13 SCALE: 1/4" = 1'-0"



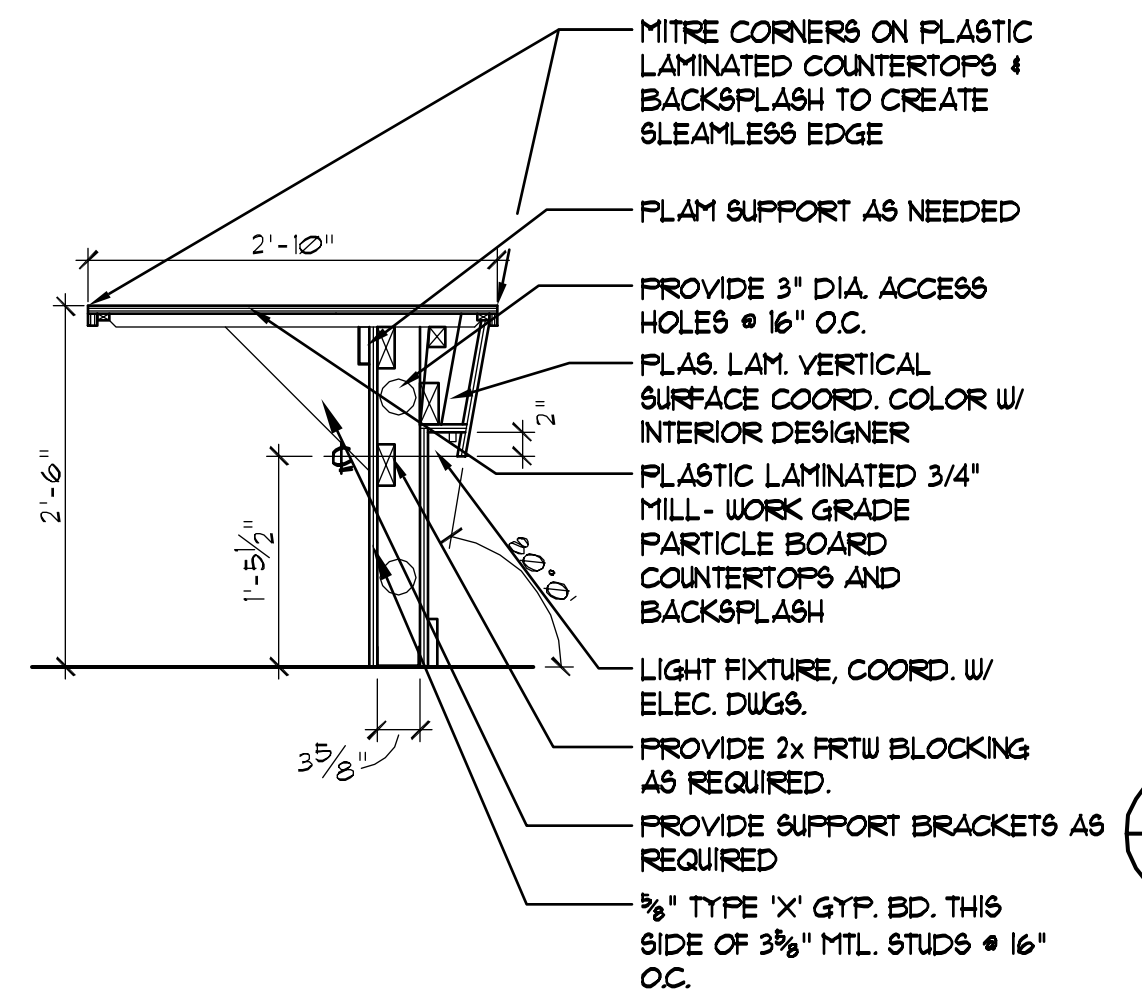
1 RESTROOM #135  
A.13 SCALE: 1/4" = 1'-0"



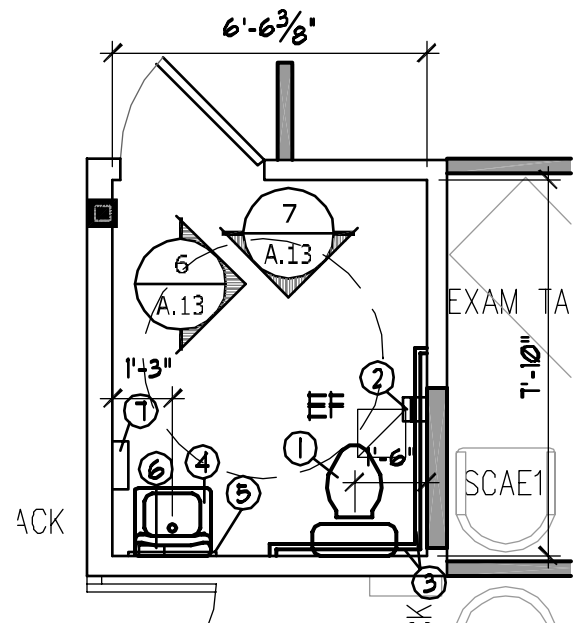
18 CASEWORK SECTION  
A.13 SCALE: 3/4" = 1'-0"



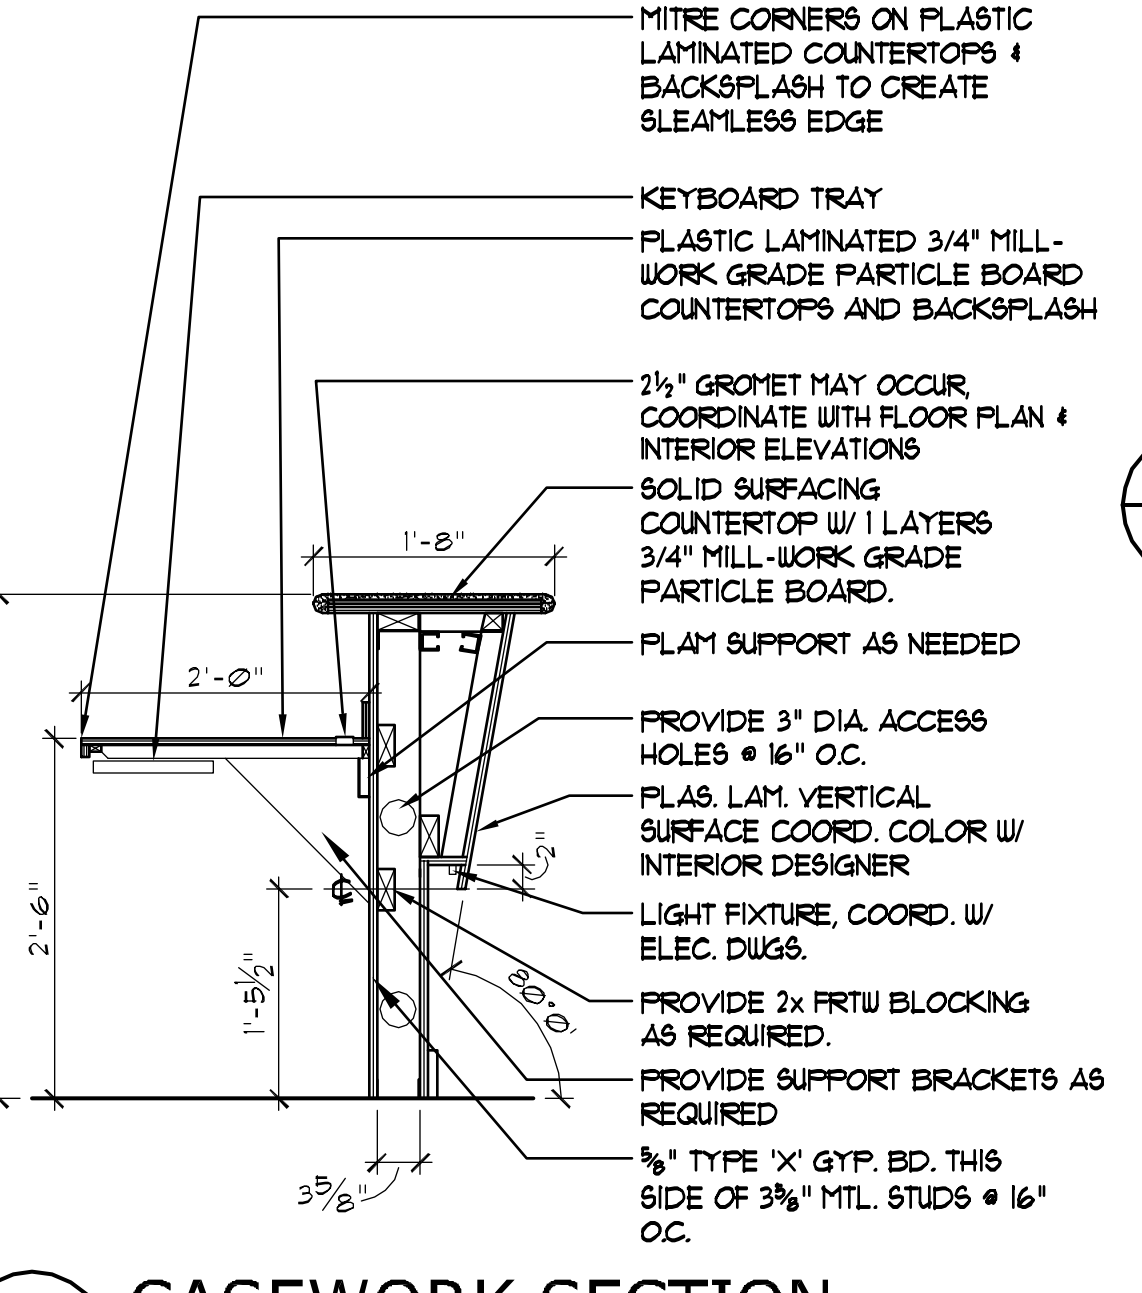16 RESTROOM #173  
A.13 SCALE: 1/4" = 1'-0"




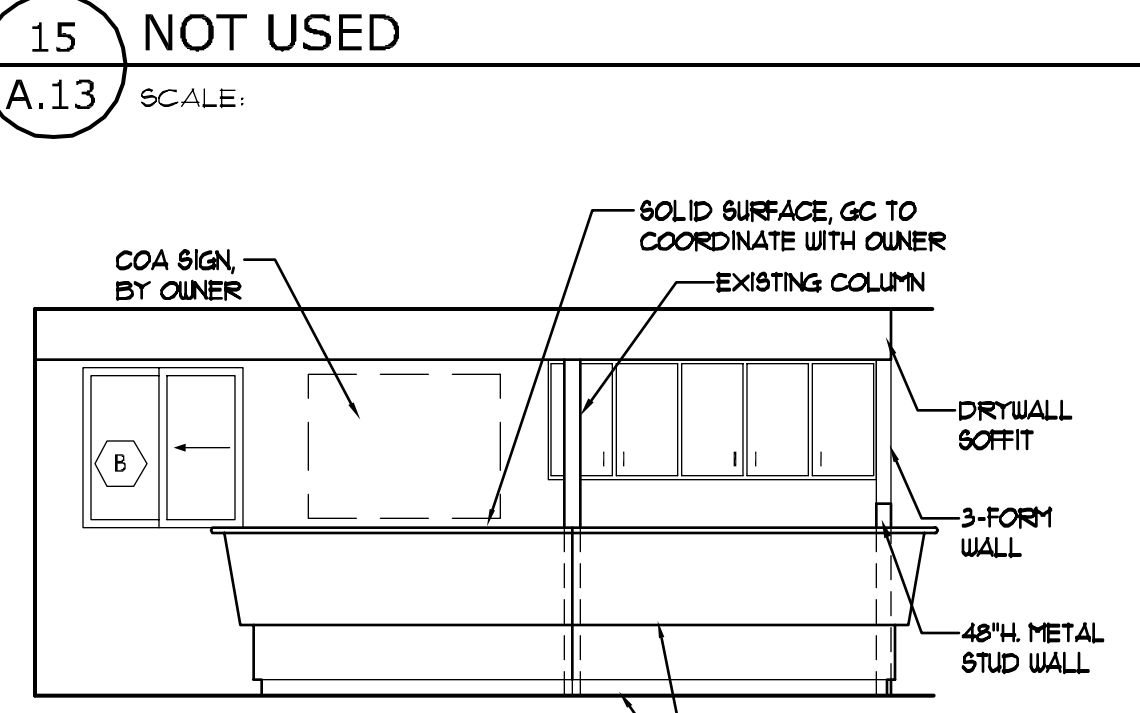17 CASEWORK SECTION  
A.13 SCALE: 3/4" = 1'-0"




14 RECEPTION ELEVATION  
A.13 SCALE: 1/4" = 1'-0"

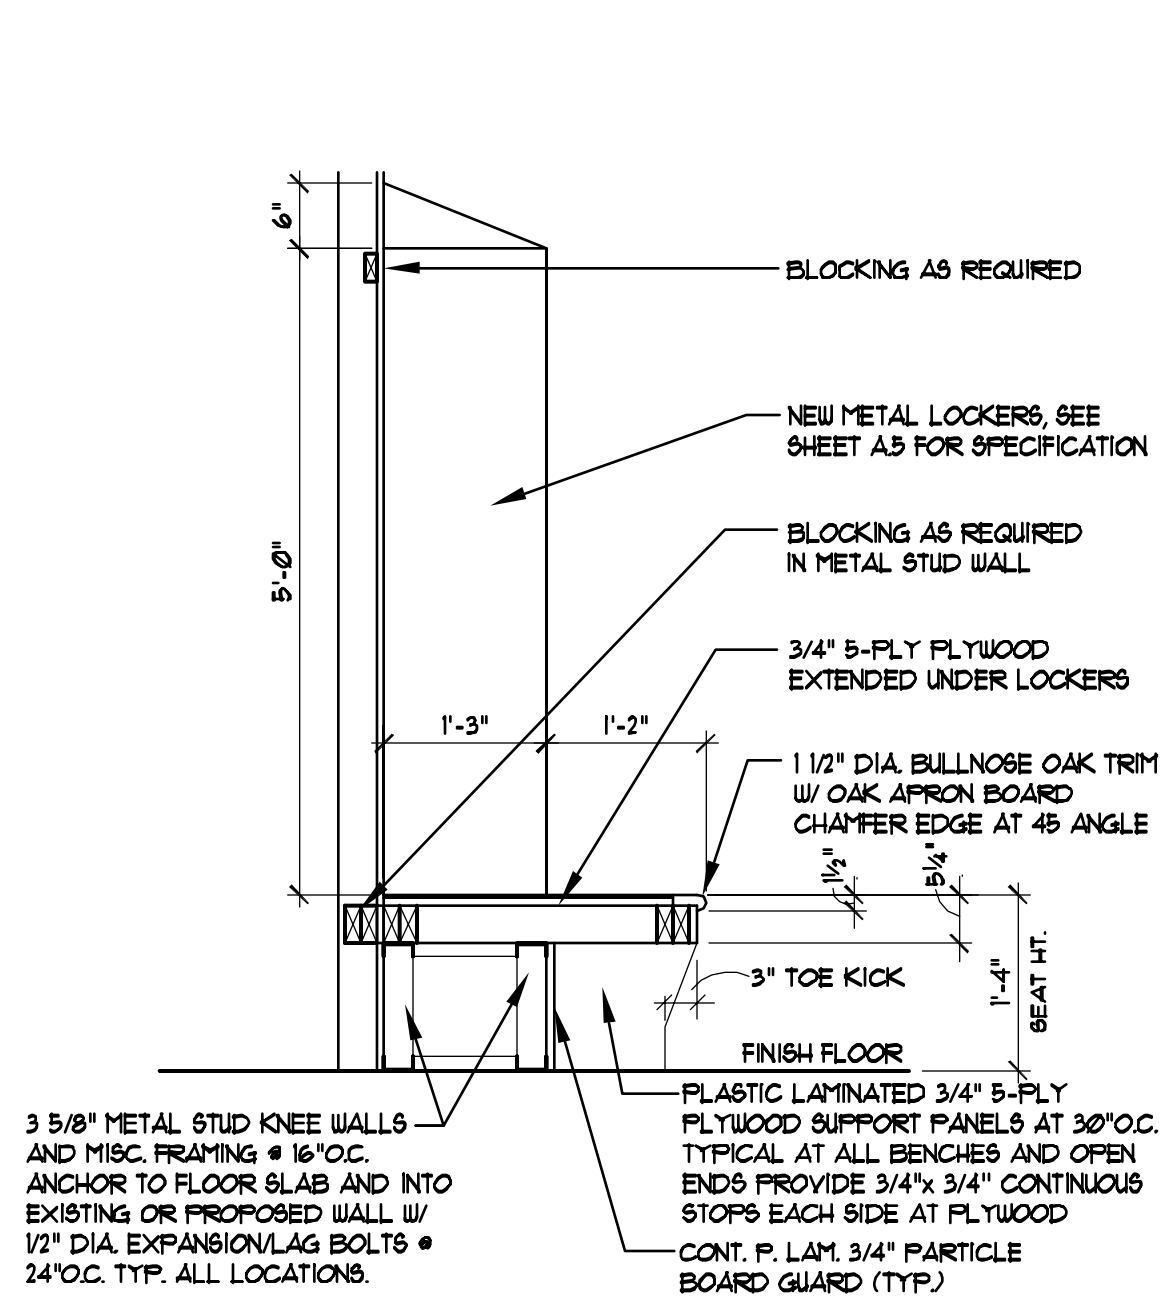
15 NOT USED  
A.13 SCALE:



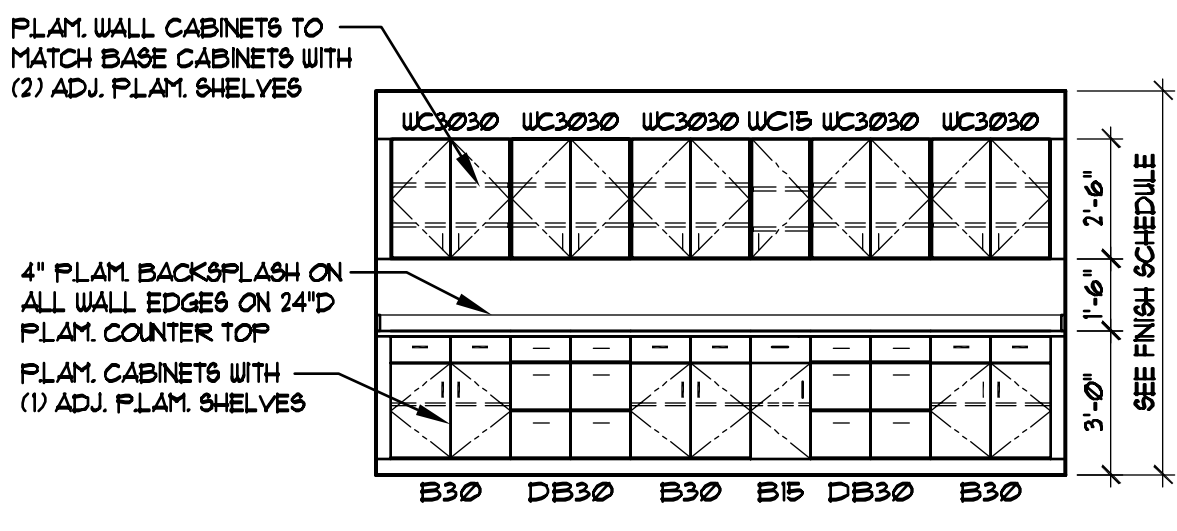
19 LOKER BENCH SECTION  
A.14 SCALE: 1/2" = 1'-0"  
C102



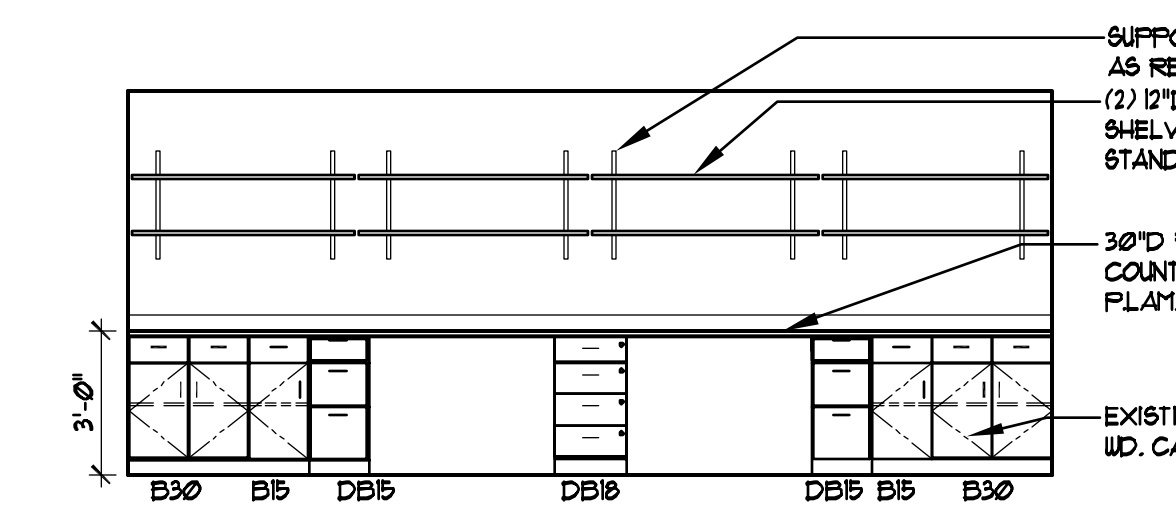
15 REGISTER/SCHEDULE  
A.14 SCALE: 1/4" = 1'-0"  
120



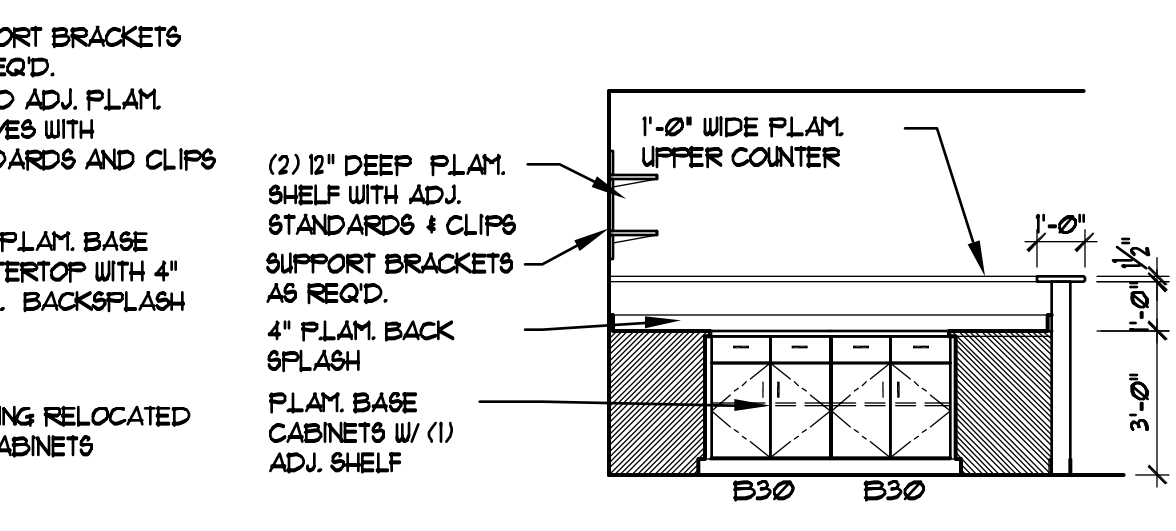
10 COPY/WORK  
A.14 SCALE: 1/4" = 1'-0"  
131




5 LAB  
A.14 SCALE: 1/4" = 1'-0"  
C105

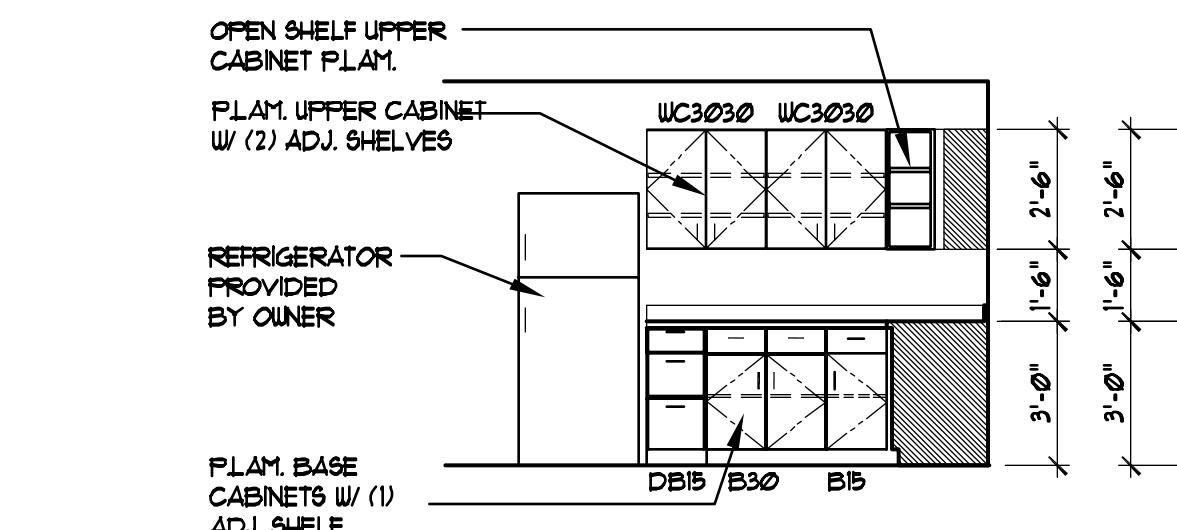

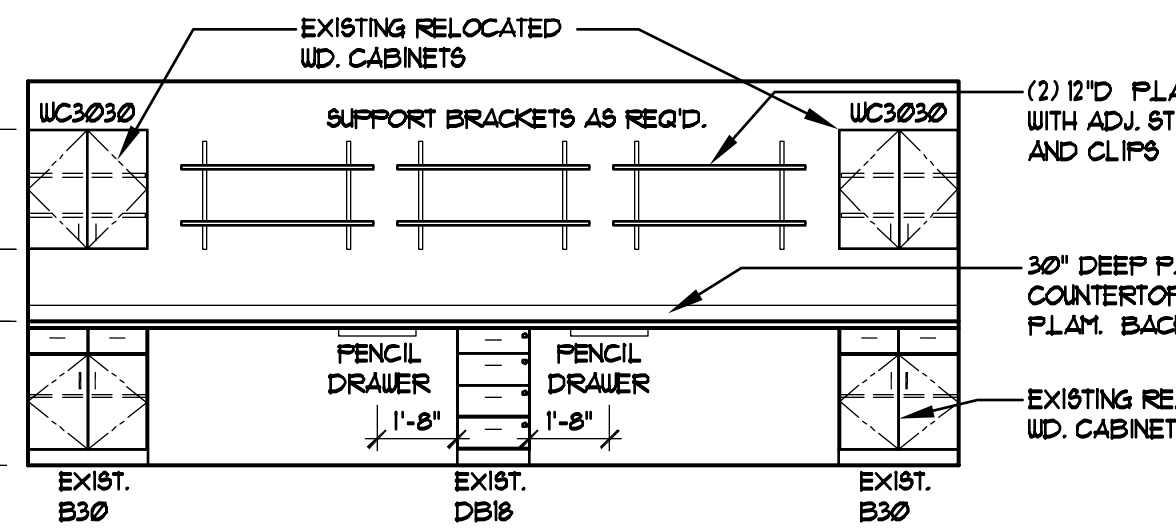
14 STAFF LOUNGE  
A.14 SCALE: 1/4" = 1'-0"  
150



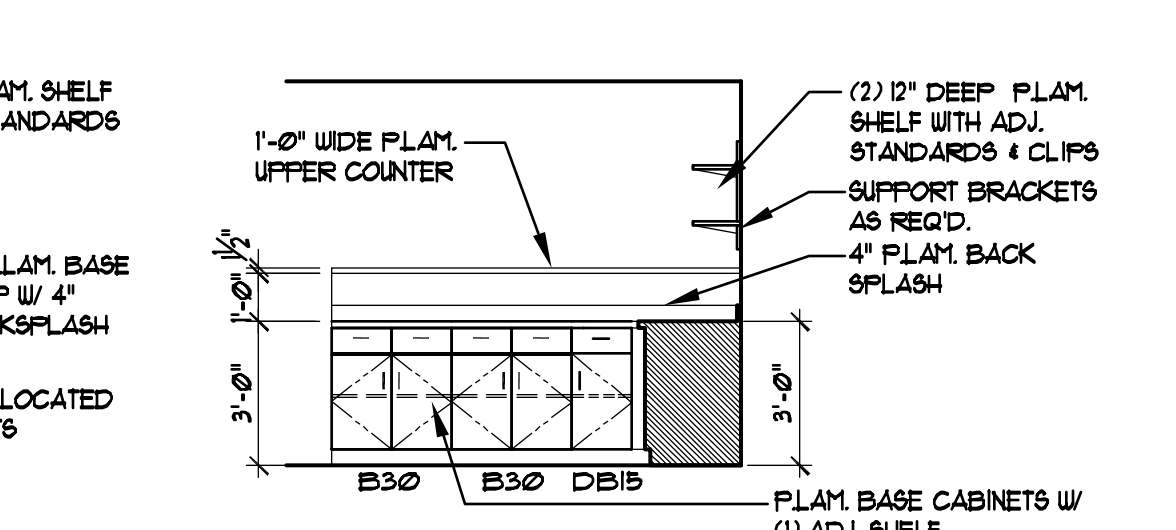
9 MA  
A.14 SCALE: 1/4" = 1'-0"  
130 & 179




4 LAB  
A.14 SCALE: 1/4" = 1'-0"  
C105

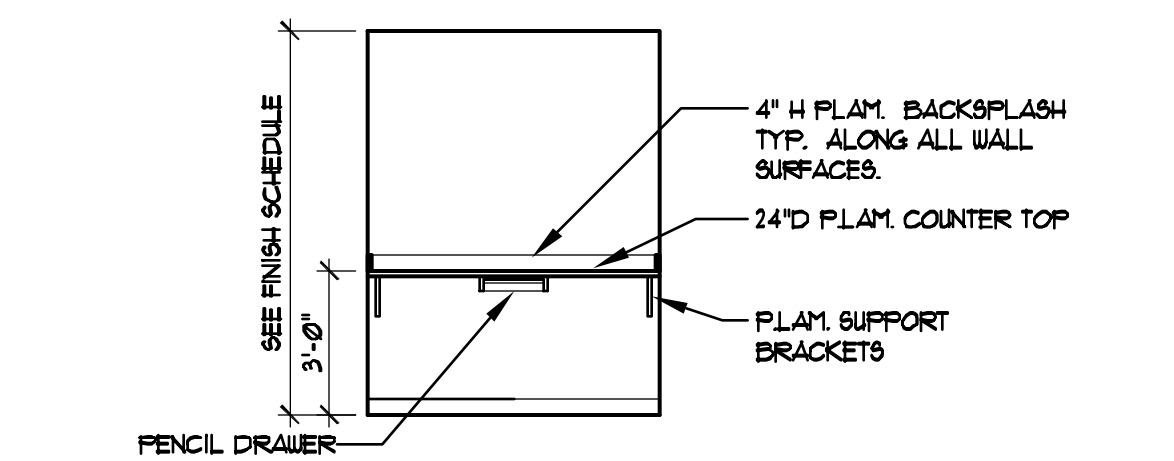

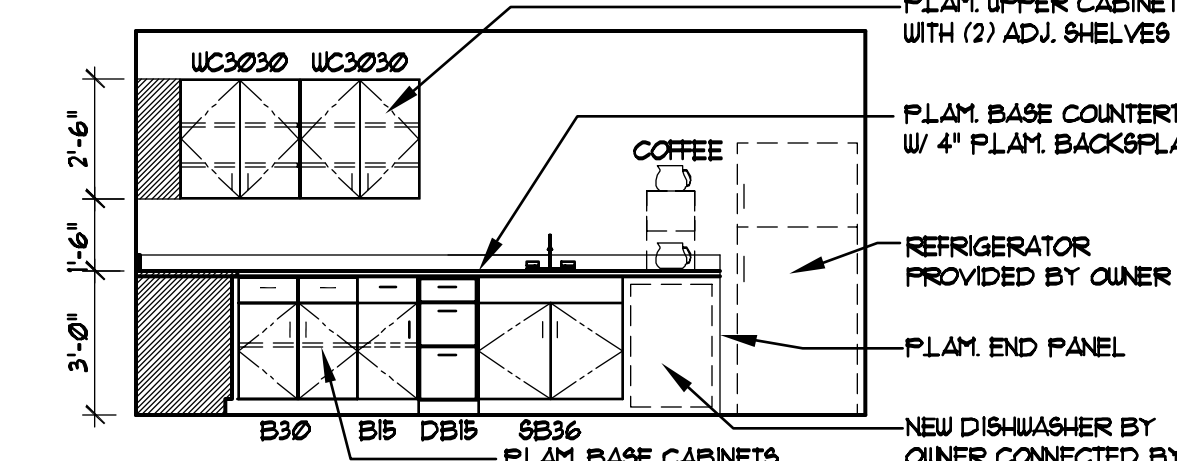
18 NURSE STATION  
A.14 SCALE: 1/4" = 1'-0"  
C114



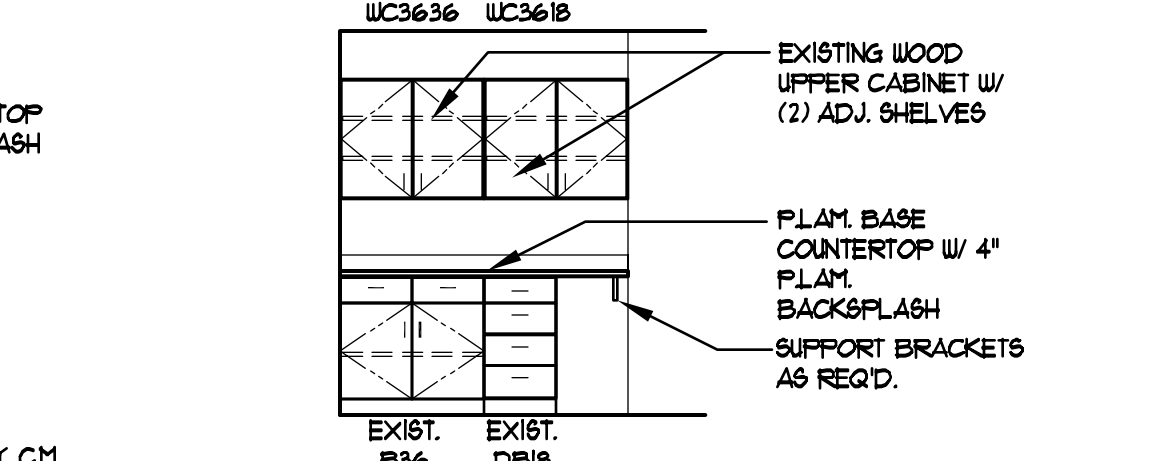
13 STAFF LOUNGE  
A.14 SCALE: 1/4" = 1'-0"  
150



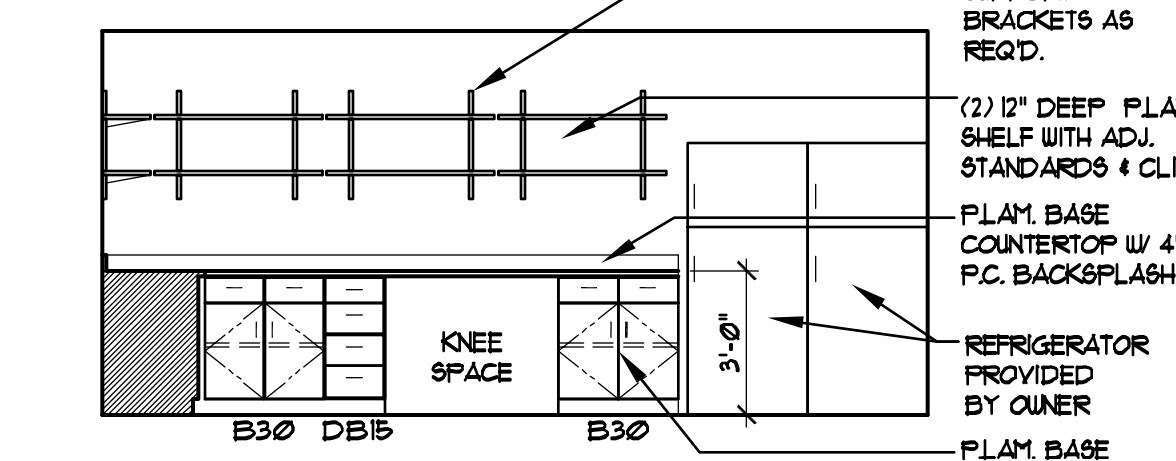
8 NURSE/COPY  
A.14 SCALE: 1/4" = 1'-0"  
C114




3 LAB  
A.14 SCALE: 1/4" = 1'-0"  
C105

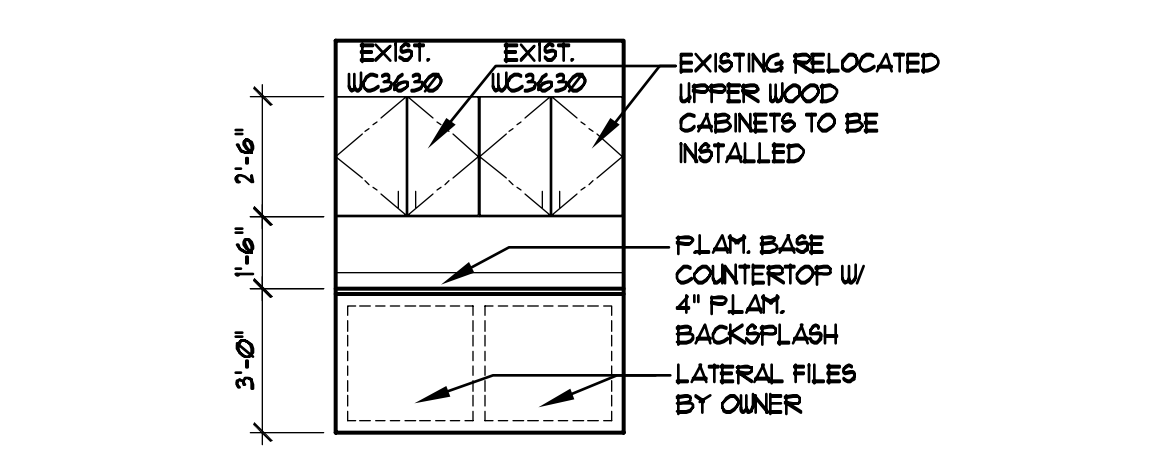

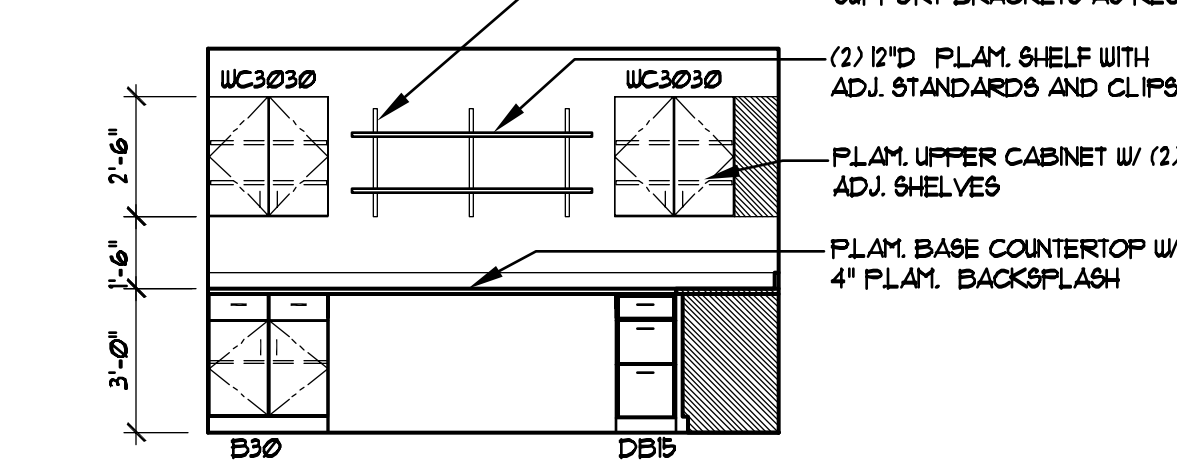
17 ALCOVE  
A.14 SCALE: 1/4" = 1'-0"  
C143



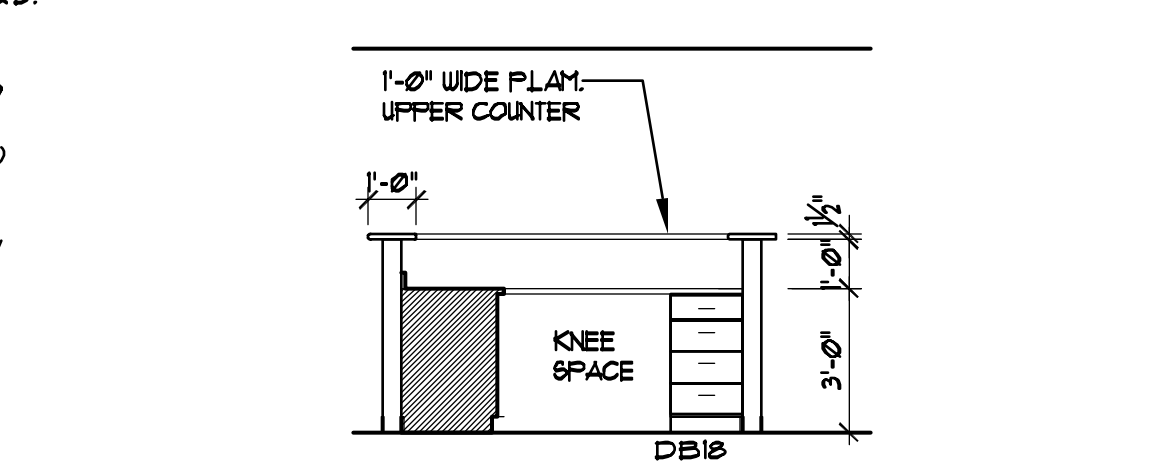
12 CANCER RESEARCH CENTER  
A.14 SCALE: 1/4" = 1'-0"  
140




7 LAB  
A.14 SCALE: 1/4" = 1'-0"  
C105

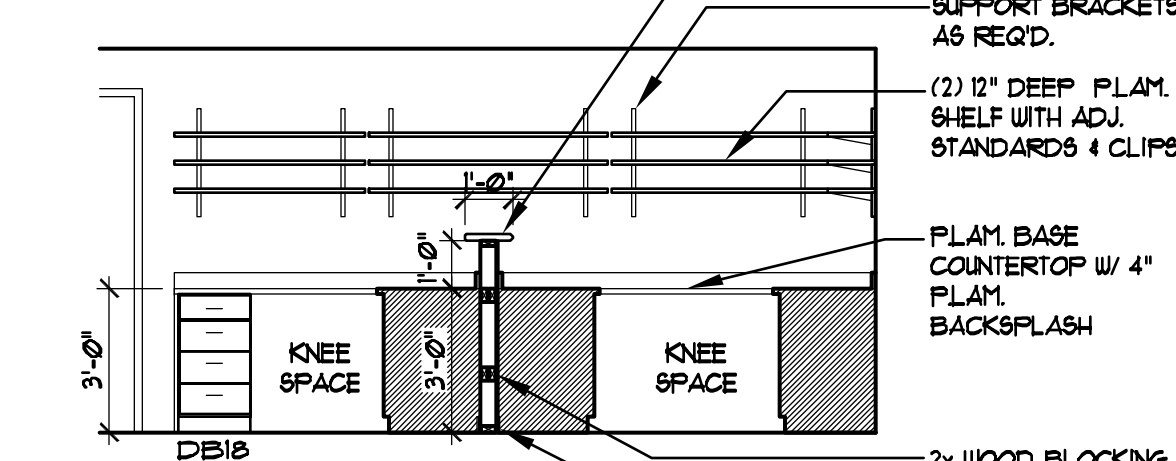

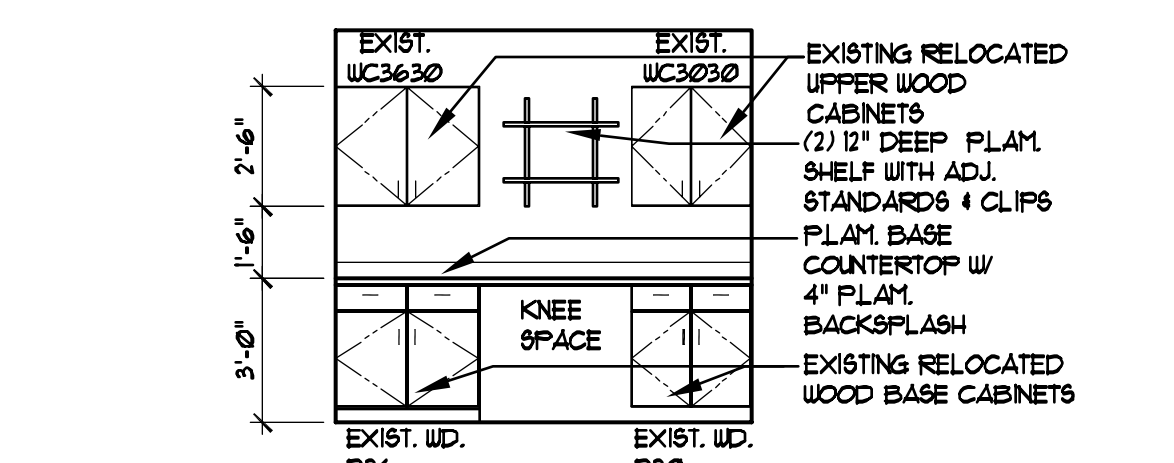
2 PHLAB  
A.14 SCALE: 1/4" = 1'-0"  
C104



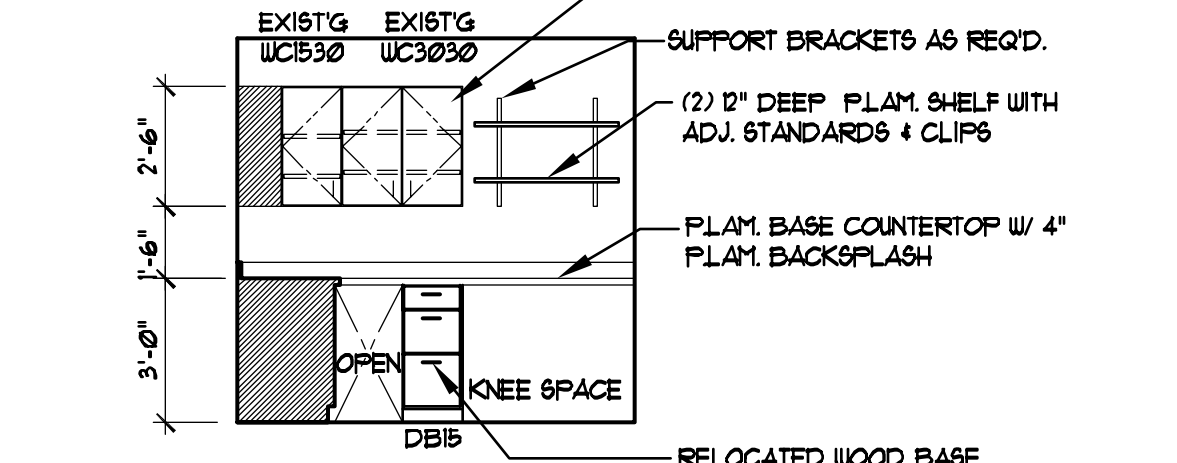
16 CANCER WORK  
A.14 SCALE: 1/4" = 1'-0"  
C101



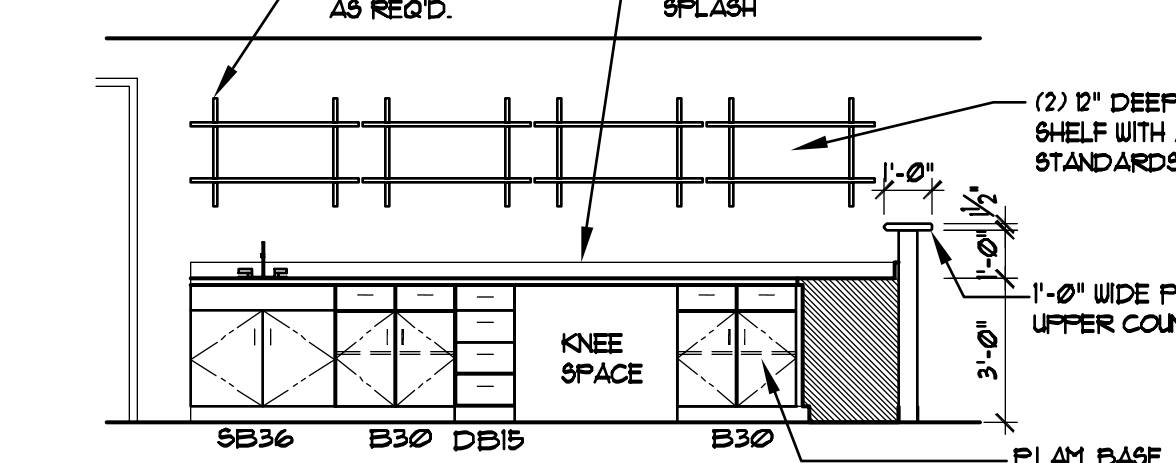11 CANCER RESEARCH CENTER  
A.14 SCALE: 1/4" = 1'-0"  
140




6 LAB  
A.14 SCALE: 1/4" = 1'-0"  
C105

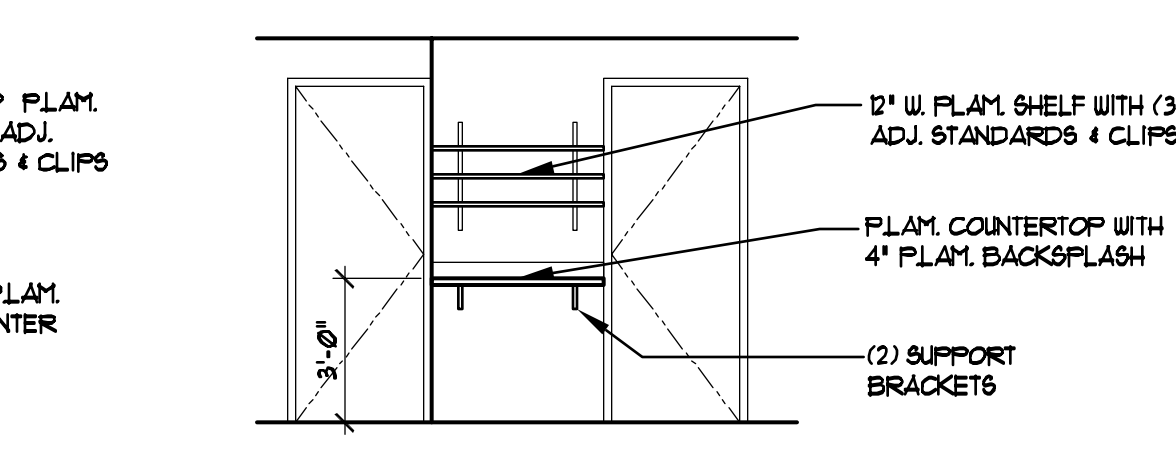

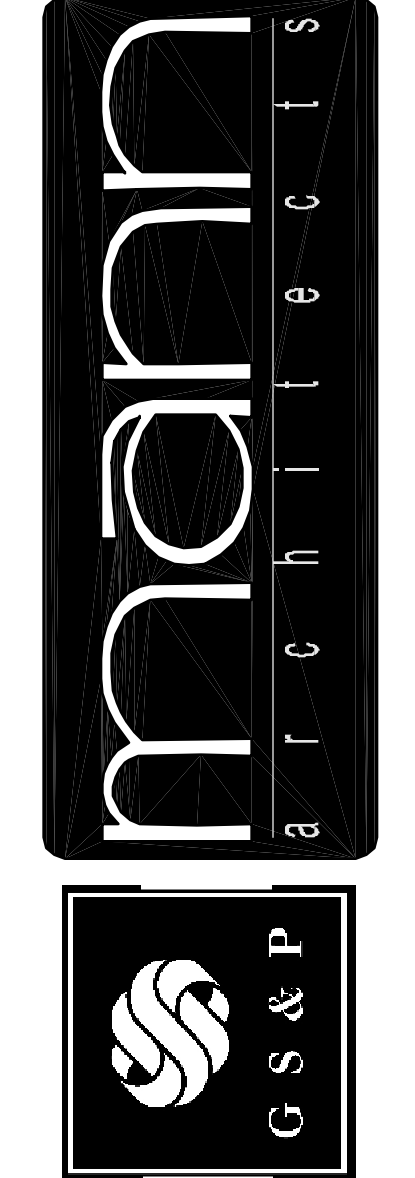1 PHLAB  
A.14 SCALE: 1/4" = 1'-0"  
C104

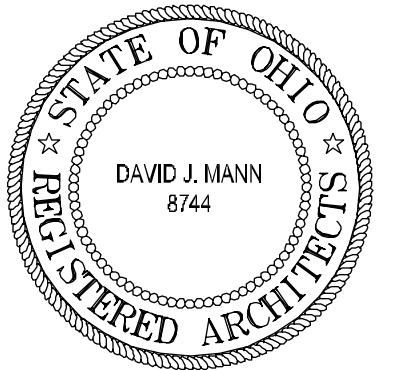
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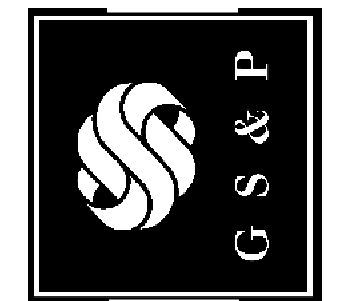
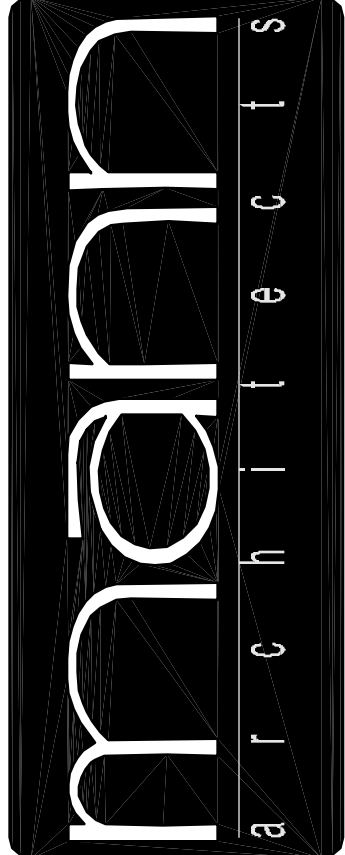
drawing enlarged rooms & interior elev. scale project no. 11406 date OCTOBER 23, 2007 AS NOTED

COLUMBUS ONCOLOGY  
JASONWAY PROFESSIONAL BUILDING  
810 JASONWAY AVENUE SUITE A  
COLUMBUS, OHIO 43214-2329

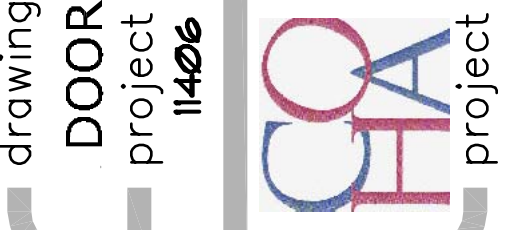


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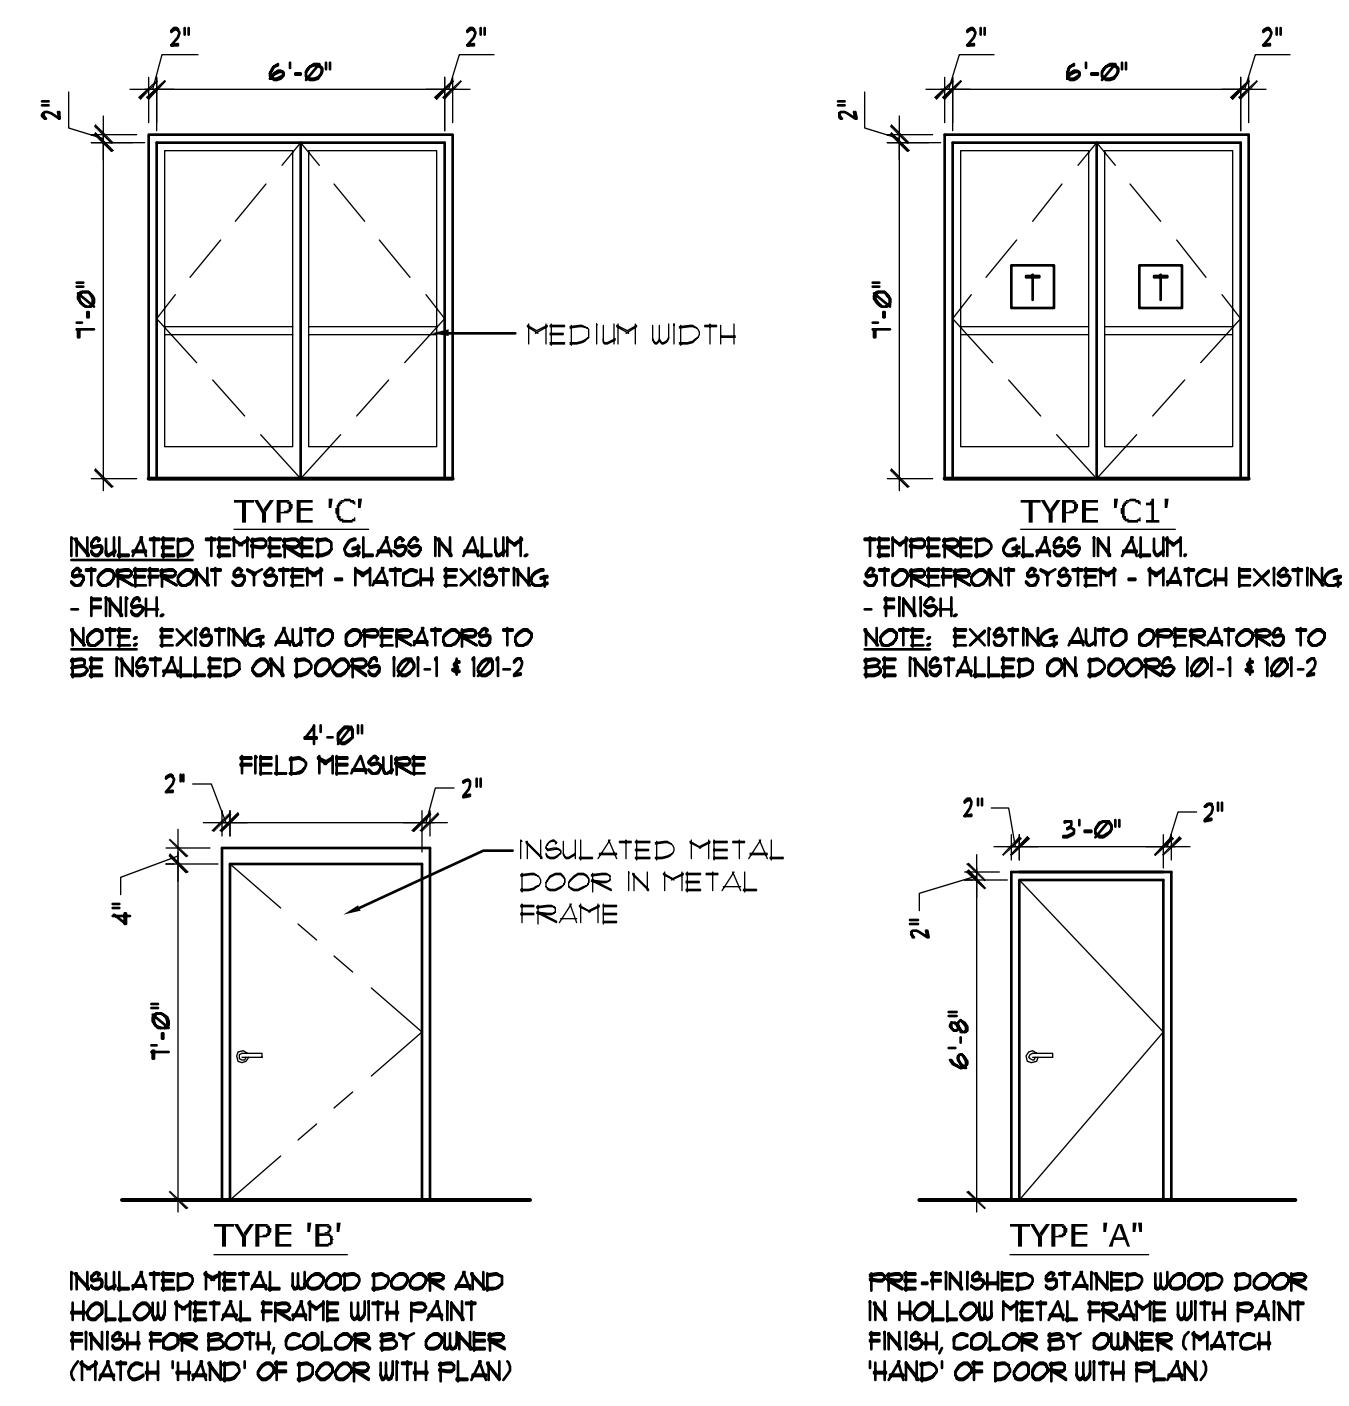


drawing DOOR SCHEDULE & NOTES scale AS NOTED  
project no. 11406 date OCTOBER 23, 2007  
COLUMBUS ONCOLOGY  
JASONIAT PROFESSIONAL BUILDING  
810 JASONIAT AVENUE SUITE A  
COLUMBUS, OHIO 43214-2329



project

DOOR SCHEDULE										NOTE: CONTRACTOR & SUPPLIER SHALL COORDINATE ALL ASPECTS OF HARDWARE SCHEDULE WITH FABRICATION & INSTALLATION OF DOORS & FRAMES.	
DOOR	DOOR		FRAME		RATING	GLAZING	HDWR. SET	REMARKS			
	SIZE	DR. MATL. (SEE NOTES)	TYPE	MATL.							
<b>FIRST FLOOR</b>											
101-1	PAIR 3'-0" x 6'-8" x 1 3/4"	ALUM	C	ALUM	----	INSUL/TEMP	7	INSTALL EXIST. AUTO OPERATORS			
101-2	PAIR 3'-0" x 6'-8" x 1 3/4"	ALUM	C1	ALUM	----	TEMP	7	INSTALL EXIST. AUTO OPERATORS			
111-1	3'-0" x 6'-8" x 1 3/4"	WOOD	A	MTL	Ø HR	----	4				
113-1	3'-0" x 6'-8" x 1 3/4"	REUSED DOOR - SEE DOOR SCHEDULE "WU" SHEET D.1 DOOR# 18									
114-1	3'-0" x 6'-8" x 1 3/4"	REUSED DOOR - SEE DOOR SCHEDULE "WU" SHEET D.1 DOOR# 25									
115a-1	3'-0" x 6'-8" x 1 3/4"	REUSED DOOR - SEE DOOR SCHEDULE "WU" SHEET D.1 DOOR# 3									
116-1	EXISTING TO REMAIN	----	----	----	----	----	----				
117-1	3'-0" x 6'-8" x 1 3/4"	REUSED DOOR - SEE DOOR SCHEDULE "WU" SHEET D.1 DOOR# 31									
118-1	3'-0" x 6'-8" x 1 3/4"	REUSED DOOR - SEE DOOR SCHEDULE "WU" SHEET D.1 DOOR# 5									
121-1	3'-0" x 6'-8" x 1 3/4"	REUSED DOOR - SEE DOOR SCHEDULE "WU" SHEET D.1 DOOR# 12									
122-1	3'-0" x 6'-8" x 1 3/4"	REUSED DOOR - SEE DOOR SCHEDULE "WU" SHEET D.1 DOOR# 33									
123-1	3'-0" x 6'-8" x 1 3/4"	REUSED DOOR - SEE DOOR SCHEDULE "WU" SHEET D.1 DOOR# 13									
125-1	3'-0" x 6'-8" x 1 3/4"	REUSED DOOR - SEE DOOR SCHEDULE "WU" SHEET D.1 DOOR# 16									
126-1	3'-0" x 6'-8" x 1 3/4"	REUSED DOOR - SEE DOOR SCHEDULE "WU" SHEET D.1 DOOR# 7									
121-1	3'-0" x 6'-8" x 1 3/4"	REUSED DOOR - SEE DOOR SCHEDULE "WU" SHEET D.1 DOOR# 38									
128-1	3'-0" x 6'-8" x 1 3/4"	REUSED DOOR - SEE DOOR SCHEDULE "WU" SHEET D.1 DOOR# 36									
128-2	3'-0" x 6'-8" x 1 3/4"	REUSED DOOR - SEE DOOR SCHEDULE "WU" SHEET D.1 DOOR# 28									
132-1	3'-0" x 6'-8" x 1 3/4"	REUSED DOOR - SEE DOOR SCHEDULE "WU" SHEET D.1 DOOR# 14									
134-1	3'-0" x 6'-8" x 1 3/4"	REUSED DOOR - SEE DOOR SCHEDULE "WU" SHEET D.1 DOOR# 10									
135-1	3'-0" x 6'-8" x 1 3/4"	WOOD	A	MTL	Ø HR	----	2				
137-1	3'-0" x 6'-8" x 1 3/4"	REUSED DOOR - SEE DOOR SCHEDULE "WU" SHEET D.1 DOOR# 4									
138-1	3'-0" x 6'-8" x 1 3/4"	REUSED DOOR - SEE DOOR SCHEDULE "WU" SHEET D.1 DOOR# 1									
143-1	3'-0" x 6'-8" x 1 3/4"	REUSED DOOR - SEE DOOR SCHEDULE "WU" SHEET D.1 DOOR# 24									
144-1	3'-0" x 6'-8" x 1 3/4"	REUSED DOOR - SEE DOOR SCHEDULE "WU" SHEET D.1 DOOR# 21									
145-1	3'-0" x 6'-8" x 1 3/4"	REUSED DOOR - SEE DOOR SCHEDULE "WU" SHEET D.1 DOOR# 8									
146-1	3'-0" x 6'-8" x 1 3/4"	REUSED DOOR - SEE DOOR SCHEDULE "WU" SHEET D.1 DOOR# 9									
147-1	3'-0" x 6'-8" x 1 3/4"	REUSED DOOR - SEE DOOR SCHEDULE "WU" SHEET D.1 DOOR# 15									
148-1	3'-0" x 6'-8" x 1 3/4"	REUSED DOOR - SEE DOOR SCHEDULE "WU" SHEET D.1 DOOR# 19									
149-1	3'-0" x 6'-8" x 1 3/4"	REUSED DOOR - SEE DOOR SCHEDULE "WU" SHEET D.1 DOOR# 29									
150-1	3'-0" x 6'-8" x 1 3/4"	REUSED DOOR - SEE DOOR SCHEDULE "WU" SHEET D.1 DOOR# 11									
150-2	EXISTING TO REMAIN	----	----	----	----	----	----				
156-1	3'-0" x 6'-8" x 1 3/4"	REUSED DOOR - SEE DOOR SCHEDULE "WU" SHEET D.1 DOOR# 22									
156-2	3'-0" x 6'-8" x 1 3/4"	REUSED DOOR - SEE DOOR SCHEDULE "WU" SHEET D.1 DOOR# 27									
160-1	3'-0" x 6'-8" x 1 3/4"	REUSED DOOR - SEE DOOR SCHEDULE "EU" SHEET D.2 DOOR# 12									
161-1	3'-0" x 6'-8" x 1 3/4"	REUSED DOOR - SEE DOOR SCHEDULE "EU" SHEET D.2 DOOR# 14									
162-1	3'-0" x 6'-8" x 1 3/4"	REUSED DOOR - SEE DOOR SCHEDULE "EU" SHEET D.2 DOOR# 1									
163-1	3'-0" x 6'-8" x 1 3/4"	REUSED DOOR - SEE DOOR SCHEDULE "EU" SHEET D.2 DOOR# 3									
164-1	3'-0" x 6'-8" x 1 3/4"	REUSED DOOR - SEE DOOR SCHEDULE "EU" SHEET D.2 DOOR# 35									
166-1	(2) 3'-0" x 6'-8" x 1 3/4"	WOOD	A	MTL.	Ø HR	---	3				
167-1	3'-0" x 6'-8" x 1 3/4"	REUSED DOOR - SEE DOOR SCHEDULE "EU" SHEET D.2 DOOR# 5									
168-1	(2) 3'-0" x 6'-8" x 1 3/4"	WOOD	A	MTL.	Ø HR	---	3				
169-1	3'-0" x 6'-8" x 1 3/4"	REUSED DOOR - SEE DOOR SCHEDULE "EU" SHEET D.2 DOOR# 2									
170-1	3'-0" x 6'-8" x 1 3/4"	REUSED DOOR - SEE DOOR SCHEDULE "EU" SHEET D.2 DOOR# 4									
173-1	3'-0" x 6'-8" x 1 3/4"	WOOD	A	MTL.	Ø HR	---	2				
174-1	3'-0" x 6'-8" x 1 3/4"	REUSED DOOR - SEE DOOR SCHEDULE "EU" SHEET D.2 DOOR# 25									
175-1	3'-0" x 6'-8" x 1 3/4"	REUSED DOOR - SEE DOOR SCHEDULE "EU" SHEET D.2 DOOR# 19									
176-1	3'-0" x 6'-8" x 1 3/4"	REUSED DOOR - SEE DOOR SCHEDULE "EU" SHEET D.2 DOOR# 30									
177-1	3'-0" x 6'-8" x 1 3/4"	REUSED DOOR - SEE DOOR SCHEDULE "EU" SHEET D.2 DOOR# 22									
178-1	3'-0" x 6'-8" x 1 3/4"	REUSED DOOR - SEE DOOR SCHEDULE "EU" SHEET D.2 DOOR# 32									
179-1	3'-0" x 6'-8" x 1 3/4"	REUSED DOOR - SEE DOOR SCHEDULE "EU" SHEET D.2 DOOR# 48									
179-2	3'-0" x 6'-8" x 1 3/4"	REUSED DOOR - SEE DOOR SCHEDULE "EU" SHEET D.2 DOOR# 46									
181-1	3'-0" x 6'-8" x 1 3/4"	WOOD	A	MTL.	Ø HR	---	2				
184-1	3'-0" x 6'-8" x 1 3/4"	REUSED DOOR - SEE DOOR SCHEDULE "EU" SHEET D.2 DOOR# 34									
185-1	3'-0" x 6'-8" x 1 3/4"	WOOD	A	MTL.	Ø HR	---	4				
186-1	3'-0" x 6'-8" x 1 3/4"	WOOD	A	MTL.	Ø HR	---	4				
189-1	3'-0" x 6'-8" x 1 3/4"	REUSED DOOR - SEE DOOR SCHEDULE "EU" SHEET D.2 DOOR# 7									
190-1	3'-0" x 6'-8" x 1 3/4"	REUSED DOOR - SEE DOOR SCHEDULE "EU" SHEET D.2 DOOR# 6									
191-1	3'-0" x 6'-8" x 1 3/4"	REUSED DOOR - SEE DOOR SCHEDULE "EU" SHEET D.2 DOOR# 8									
191-2	4'-0" x 7'-0" x 1 3/4"	WOOD	B	MTL.	Ø HR	---	6	FIELD MEASURE DOOR WIDTH			
C103-1	3'-0" x 6'-8" x 1 3/4"	WOOD	A	MTL.	Ø HR	---	2				
C104-1	3'-0" x 6'-8" x 1 3/4"	WOOD	A	MTL.	Ø HR	---	4				
C104-2	3'-0" x 6'-8" x 1 3/4"	REUSED DOOR - SEE DOOR SCHEDULE "EU" SHEET D.2 DOOR# 45									
C105-1	3'-0" x 6'-8" x 1 3/4"	REUSED DOOR - SEE DOOR SCHEDULE "EU" SHEET D.2 DOOR# 49									
C107-1	3'-0" x 6'-8" x 1 3/4"	REUSED DOOR - SEE DOOR SCHEDULE "EU" SHEET D.2 DOOR# 41									
C110-1	3'-0" x 6'-8" x 1 3/4"	WOOD	A	MTL.	Ø HR	---	1				
C111-1	3'-0" x 6'-8" x 1 3/4"	WOOD	A	MTL.	Ø HR	---	1				
C115-1	3'-0" x 6'-8" x 1 3/4"	REUSED DOOR - SEE DOOR SCHEDULE "EU" SHEET D.2 DOOR# 9									
C116-1	3'-0" x 6'-8" x 1 3/4"	REUSED DOOR - SEE DOOR SCHEDULE "EU" SHEET D.2 DOOR# 52									
C117-1	3'-0" x 6'-8" x 1 3/4"	REUSED DOOR - SEE DOOR SCHEDULE "EU" SHEET D.2 DOOR# 39									
206-1	3'-0" x 6'-8" x 1 3/4"	REUSED DOOR - SEE DOOR SCHEDULE "WU" SHEET D.1 DOOR# 11									
208-1	3'-0" x 6'-8" x 1 3/4"	REUSED DOOR - SEE DOOR SCHEDULE "WU" SHEET D.3 DOOR# 2									
210-1	3'-0" x 6'-8" x 1 3/4"	REUSED DOOR - SEE DOOR SCHEDULE "WU" SHEET D.1 DOOR# 17									



**DOOR TYPE**  
SCALE 1/4" = 1'-0"





**NOTE:**  
HARDWARE FINISHES FOR WEST PORTION OF FIRST FLOOR IS BRUSHED BRASS. FOR THE EAST HALF IT IS BRUSHED CHROME FINISH.

**GLAZING LEGEND**  
T INDICATES TEMPERED GLAZING

**DOOR HARDWARE SCHEDULE:**

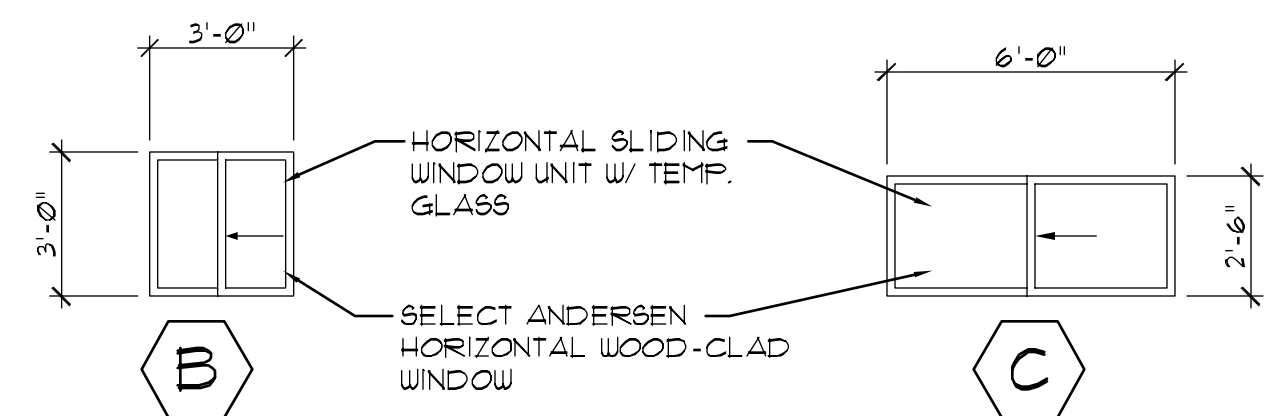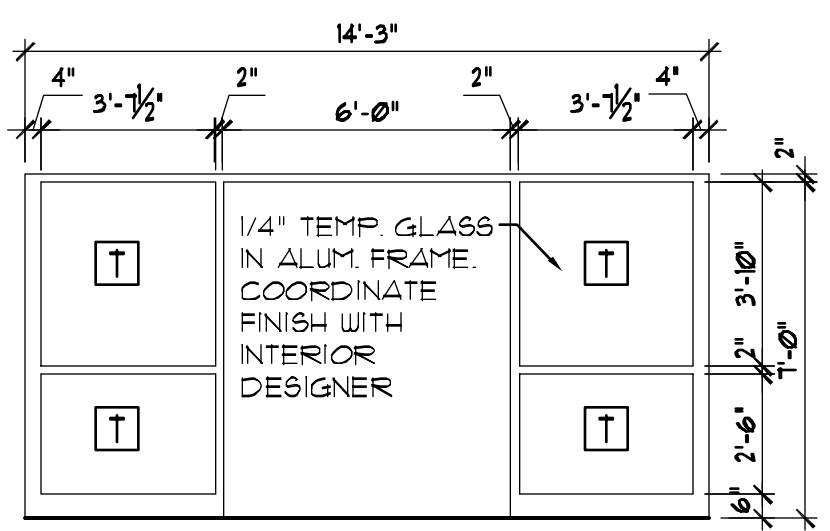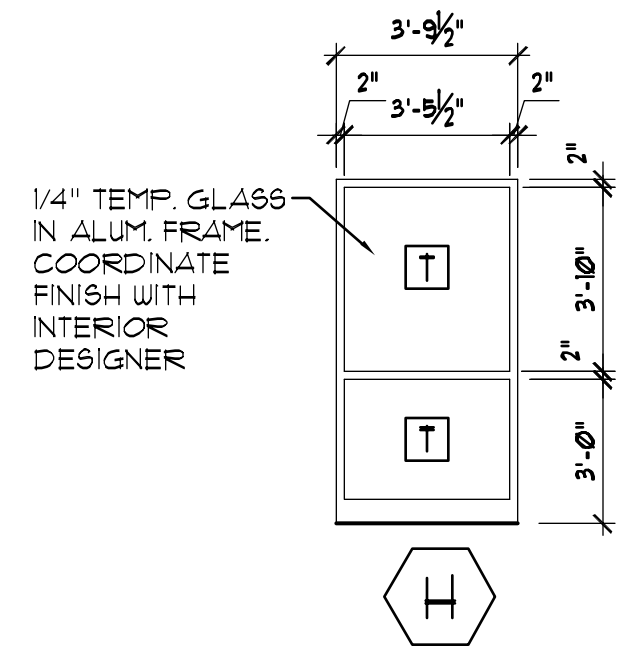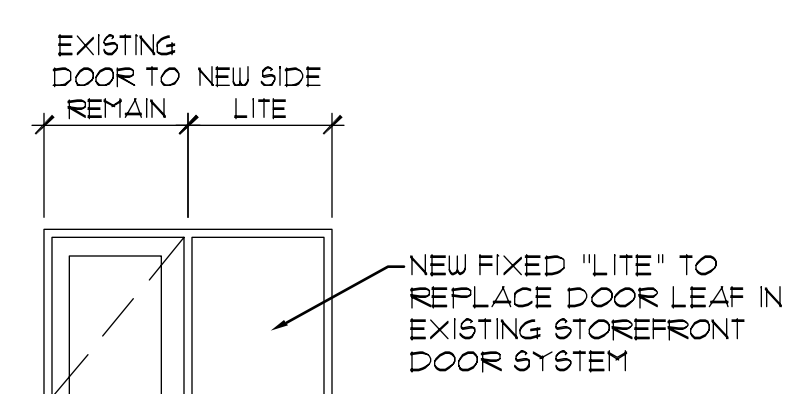MFR	QTY	SUBTYPE	SET #2
<b>SET #1</b>			
FBB	3.0	HINGES	FBB 3.0 HINGES
SCH	1.0	PASSAGE SETS	SCH 1.0 PRIVACY SETS
HAG	1.0	WALL STOP	HAG 1.0 WALL STOP
<b>SET #3</b>			
FBB	6.0	HINGES	FBB 3.0 HINGES
SCH	1.0	THROW BOLT	SCH 1.0 OFFICE LOCK
SCH	1.0	OFFICE LOCK	HAG 1.0 WALL STOP
<b>SET #5</b>			
FBB	3.0	HINGES	FBB 3.0 HINGES
SCH	1.0	CLASSROOM LOCK	SCH 1.0 ENTRANCE LOCK
HAG	1.0	WALL STOP	1.0 CARD READER FOR ACCESS
<b>SET #7</b>			
HARDWARE BY DOOR MANUFACTURER			
1.0 ALUM. ADA THRESHOLD			
1.0 HEAD DRIP EDGE TRIM			
1.0 PEEP HOLE			

**DOOR NOTES:**  
1. ALL DOOR HARDWARE TO BE LEVER TYPE AS REQUIRED TO MEET ADAAG ACCESSIBILITY REQUIREMENTS.



**WINDOW/STOREFRONT**  
SCALE 1/4" = 1'-0"



**A.15**

DF 18  
sheet no.



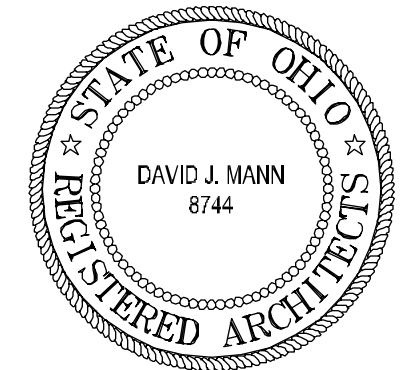
- GENERAL REFLECTED CEILING PLAN NOTES**
1. CENTERLINES OF ROOMS SHALL BE STARTING POINT OF CEILING GRID LAYOUT, UNLESS NOTED OTHERWISE.
  2. SPRINKLER HEADS, INCANDESCENT DOWNLIGHTS, DIFFUSERS, ETC. SHALL BE CENTERED IN CEILING PANELS IN BOTH DIRECTIONS, UNLESS OTHERWISE INDICATED.
  3. ALL SOFFITS AND VERTICAL SURFACES CONNECTING CEILINGS AND/OR SOFFITS AT DIFFERENT ELEVATIONS SHALL BE CONSTRUCTED OF 3/8" METAL STUDS (22 GAGE) AT 16" O.C. W/ 3/8" GYP. BD. (TYPE 'X'), U.N.O.
  4. ALL ELECTRICAL AND MECHANICAL DEVICES SHOWN ON REFLECTED CEILING PLANS ARE FOR GRAPHICAL REPRESENTATION ONLY; SEE ELECTRICAL AND MECHANICAL SHEETS FOR FURTHER INFORMATION.

**FLAG NOTES**

◻ DENOTES EXISTING 3 5/8" MTL. STUD HEADER W/ GYP. BD. FINISH - 1" BELOW PROPOSED ADJACENT LAY-IN CEILING PLANE.

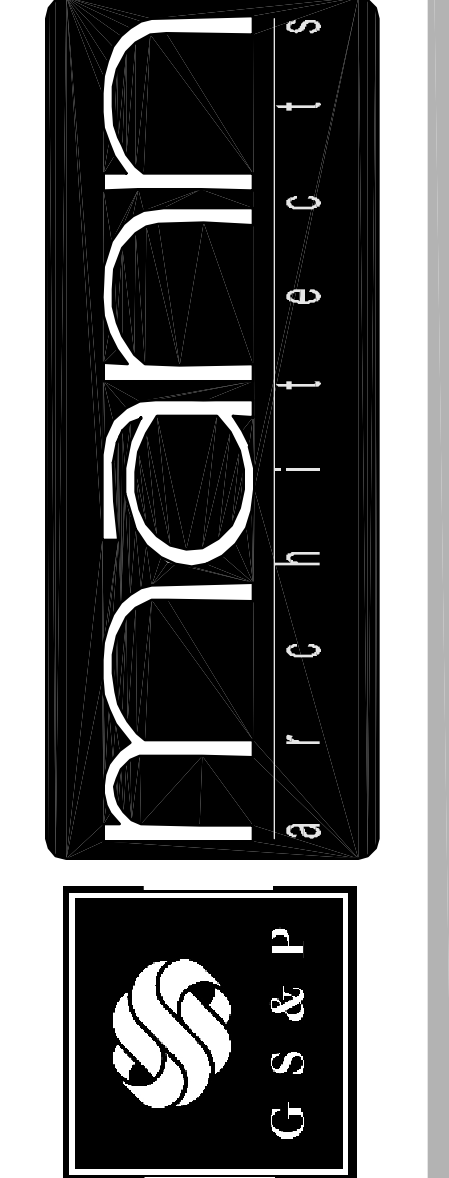
**LEGEND (REFER TO ELECTRICAL DRAWINGS FOR FURTHER INFORMATION)**

	FLUOR 2x2, RECESSED INDIRECT, PERF BASKET
	FLUOR 2x4, RECESSED INDIRECT, PERF BASKET, OR FLUOR 2x4, PRISMATIC, RECESSED, 2 BALLASTS
	FLUOR 1x4, SURFACE WRAP
	OVER MIRROR LIGHT, TOILETS, DECORATIVE
	WALL SCONCE
	COMPACT FLUOR, RECESSED, SUSPENDED ELEMENT
	PENDANT MOUNTED, MONO-POINT
	1x4 SURFACE STRIP
	CURVABLE TRACK
	EXIT, LED, BATTERY
	BATTERY LIGHT UNIT
	2 HEADS W/ 2 W.P. REMOTE HEADS
	BATTERY LIGHT, RECESSED
	HVAC SUPPLY GRILL
	HVAC RETURN GRILL
	EXHAUST FAN



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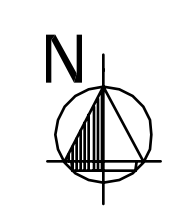
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akron, ohio 44333  
tel. 330.666.5770  
fax. 330.666.8812  
web site www.mann-architects.com




drawing  
1ST FLOOR REFL. CLG. PLAN - WEST  
project no. 11406  
date OCTOBER 23, 2007  
scale AS NOTED

COLUMBUS ONCOLOGY  
JASONIAT PROFESSIONAL BUILDING  
810 JASONIAT AVENUE, SUITE A  
COLUMBUS, OHIO 43214-2329

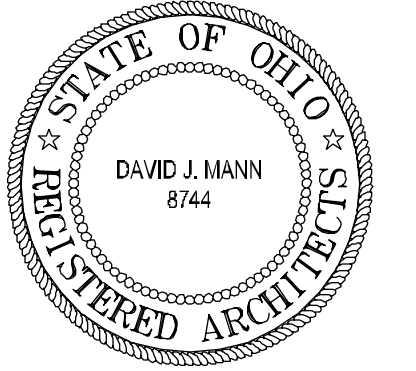**FIRST FLOOR REFLECTED CLG. PLAN - WEST**  
SCALE: 3/16" = 1' - 0"





**FLAG NOTES**

□ DENOTES EXISTING 3 5/8" MTL. STUD HEADER W/ GYP. BD. FINISH - 1" BELOW PROPOSED ADJACENT LAY-IN CEILING PLANE.

**GENERAL REFLECTED CEILING PLAN NOTES**

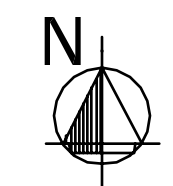
- CENTERLINES OF ROOM SHALL BE STARTING POINT OF CEILING GRID LAYOUT, UNLESS NOTED OTHERWISE.
- SPRINKLER HEADS, INCANDESCENT DOWNLIGHTS, DIFFUSERS, ETC. SHALL BE CENTERED IN CEILING PANELS IN BOTH DIRECTIONS, UNLESS OTHERWISE INDICATED.
- ALL SOFFITS AND VERTICAL SURFACES CONNECTING CEILING AND/OR SOFFITS AT DIFFERENT ELEVATIONS SHALL BE CONSTRUCTED OF 3/8" METAL STUDS (22 GAGE) AT 16" O.C. W/ 5/8" GYP. BD. (TYPE 'X'), U.N.O.
- ALL ELECTRICAL AND MECHANICAL DEVICES SHOWN ON REFLECTED CEILING PLANS ARE FOR GRAPHICAL REPRESENTATION ONLY. SEE ELECTRICAL AND MECHANICAL SHEETS FOR FURTHER INFORMATION.

**LEGEND** (REFER TO ELECTRICAL DRAWINGS FOR FURTHER INFORMATION)

	FLUOR, 2x2, RECESSED INDIRECT, PERF BASKET
	FLUOR, 2x4, RECESSED INDIRECT, PERF BASKET, OR FLUOR, 2x4, PRISMATIC, RECESSED, 2 BALLASTS
	FLUOR, 1x4, SURFACE WRAP
	OVER MIRROR LIGHT, TOILETS, DECORATIVE
	WALL SCONCE
	COMPACT FLUOR, RECESSED, SUSPENDED ELEMENT
	PENDANT MOUNTED, MONO-POINT
	1x4 SURFACE STRIP
	CURVABLE TRACK
	EXIT, LED, BATTERY
	BATTERY LIGHT UNIT
	2 HEADS W/ 2 WP. REMOTE HEADS
	BATTERY LIGHT, RECESSED
	HVAC SUPPLY GRILL
	HVAC RETURN GRILL
	EXHAUST FAN




**FIRST FLOOR REFLECTED CLG. PLAN - EAST**  
SCALE: 3/16" = 1' - 0"



revisions

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akron, ohio 44333  
tel. 330.666.5770  
fax. 330.666.8812  
web site www.mann-architects.com

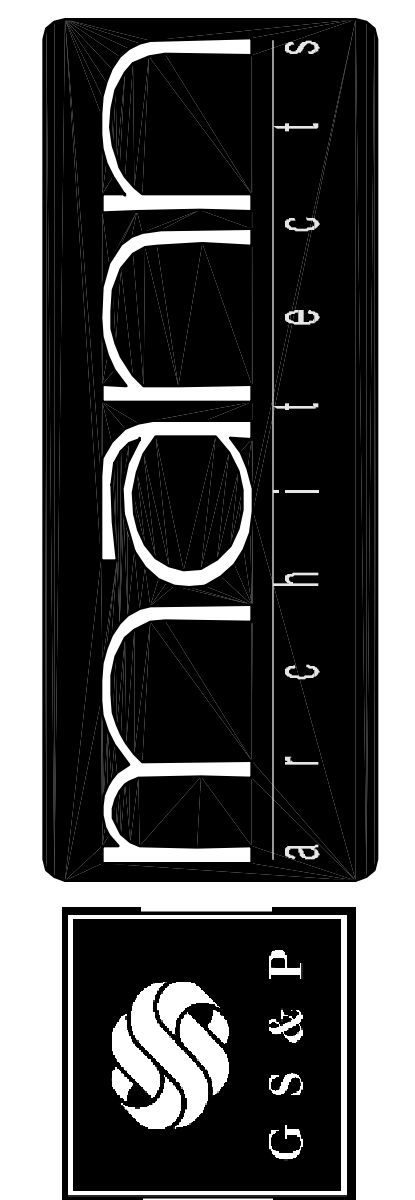

drawing  
**1ST FLOOR REFL. CLG. PLAN - EAST**  
project no. 11406  
date OCTOBER 23, 2007  
scale AS NOTED

**COLUMBUS ONCOLOGY**  
JASONIWAY PROFESSIONAL BUILDING  
810 JASONIWAY AVENUE, SUITE A  
COLUMBUS, OHIO 43214-2329

**A.17**  
OF 18  
sheet no.




**GENERAL REFLECTED CEILING PLAN NOTES**

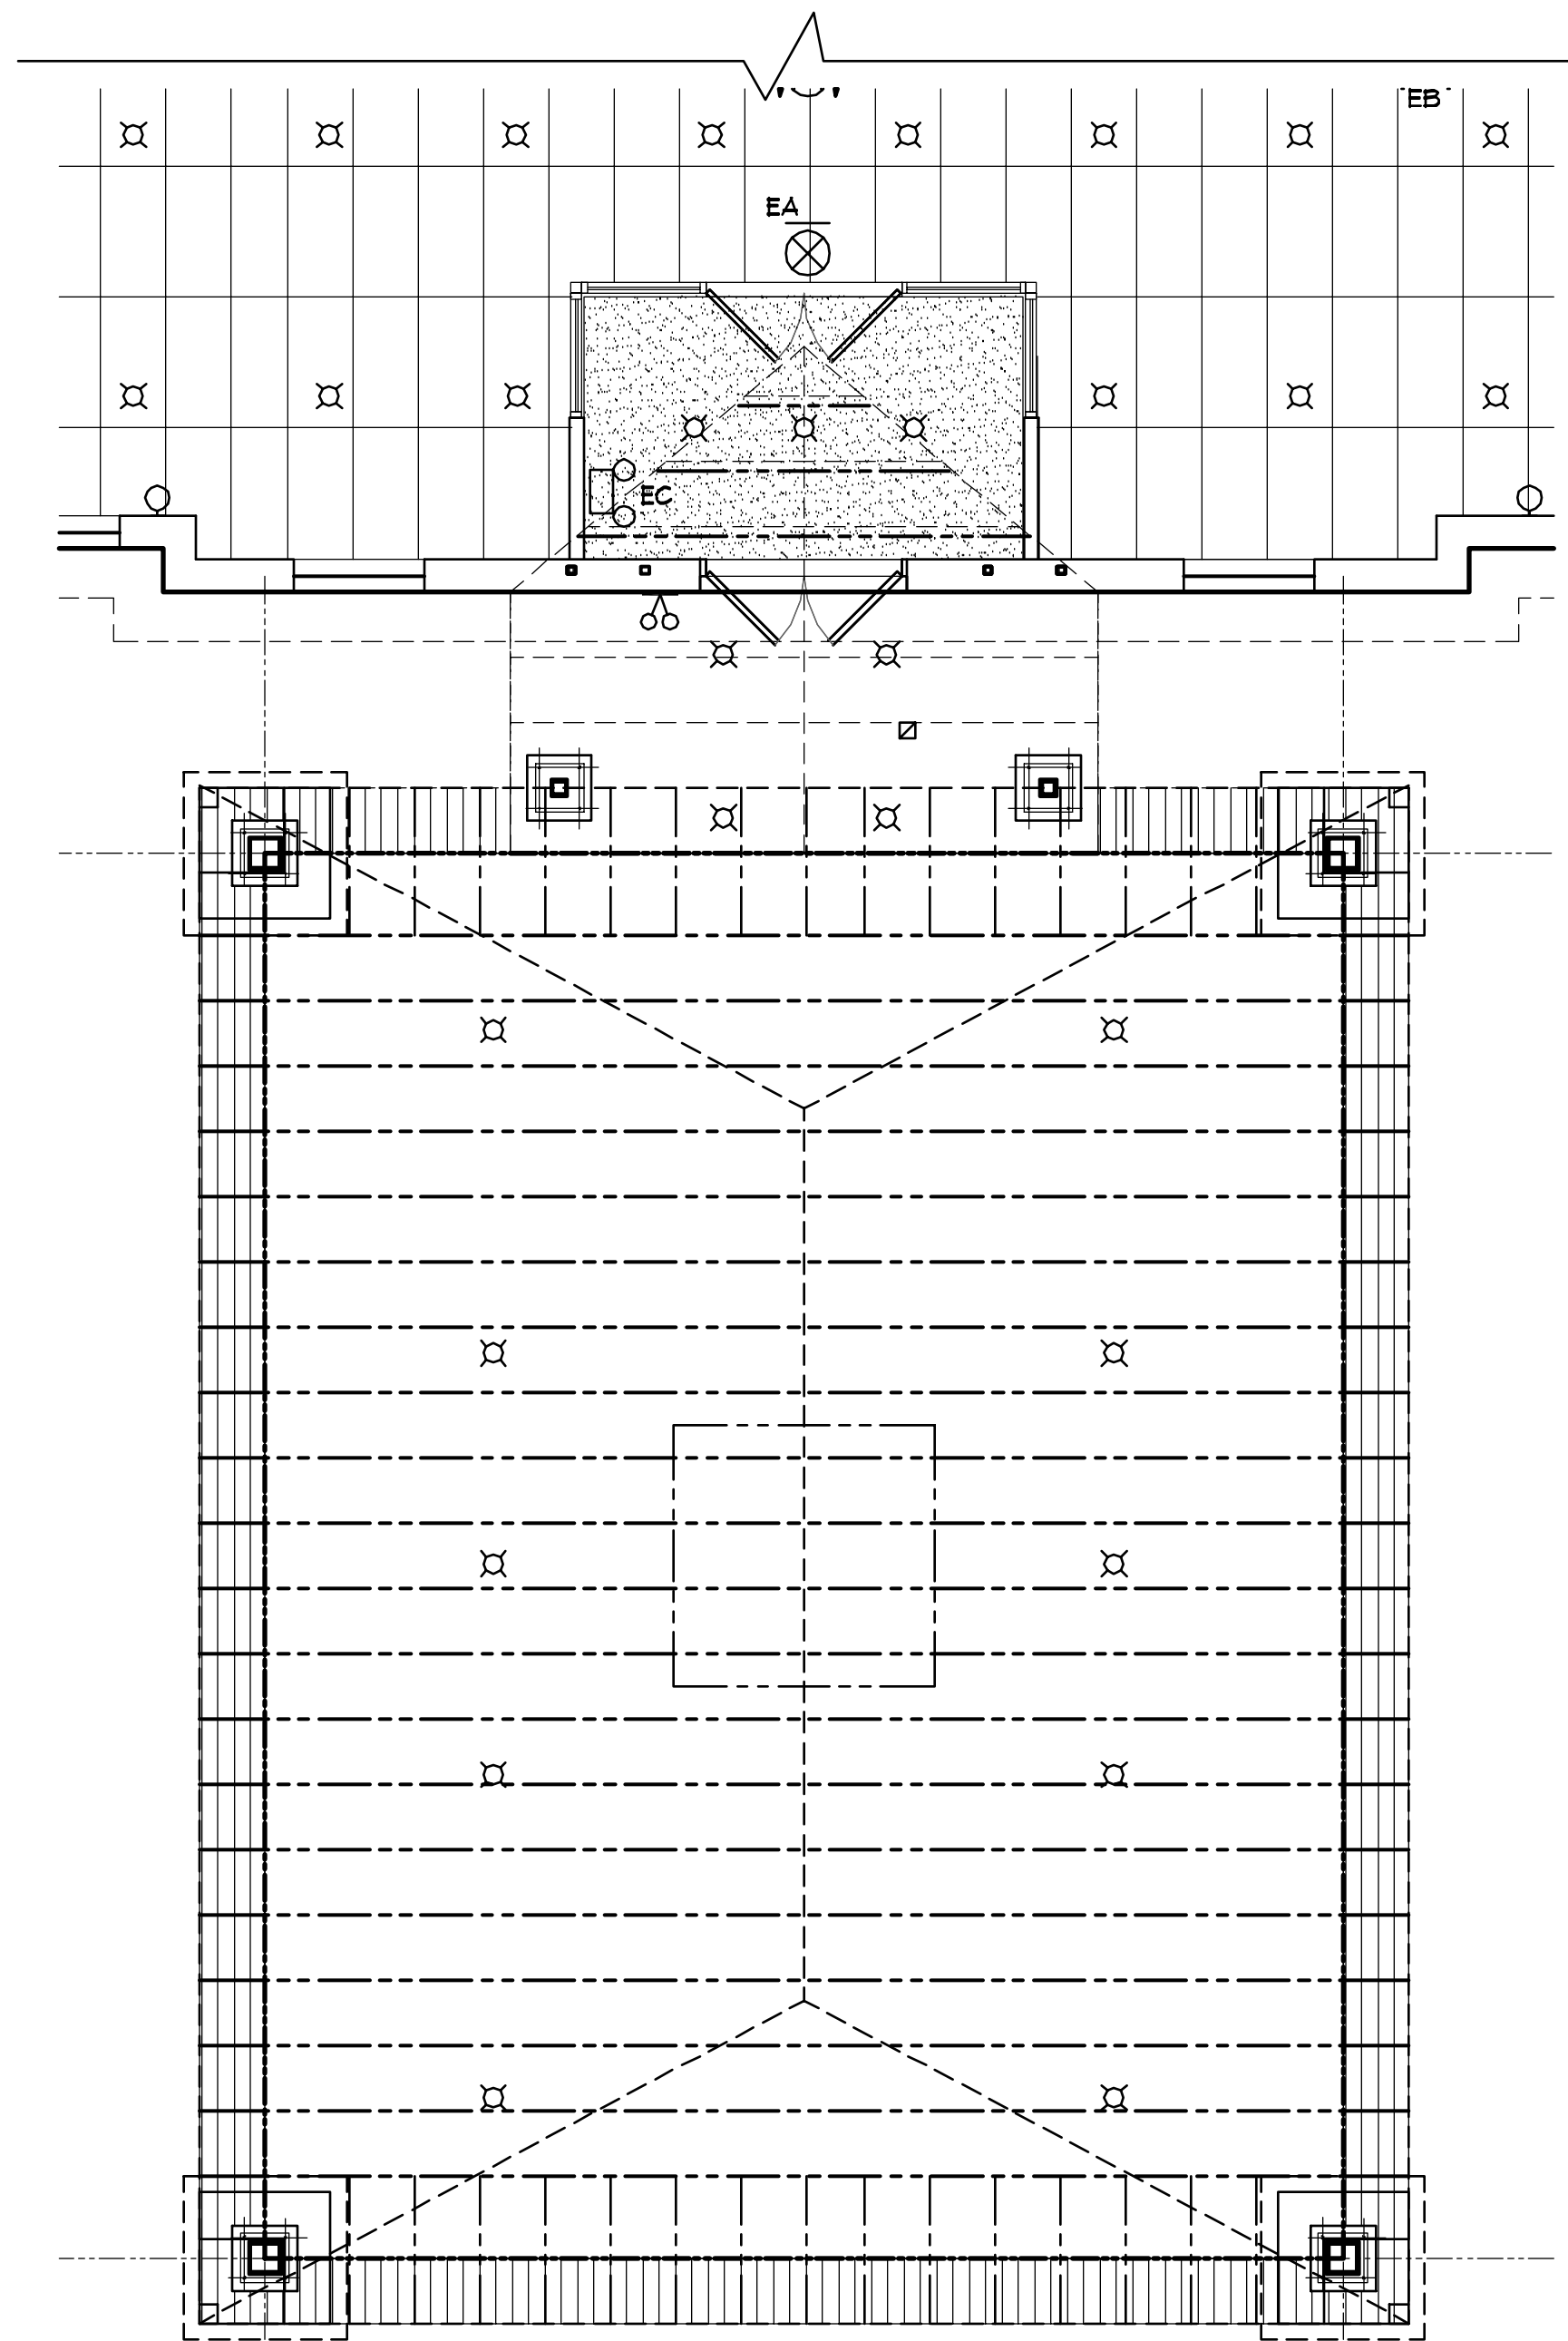1. CENTERLINES OF ROOMS SHALL BE STARTING POINT OF CEILING GRID LAYOUT, UNLESS NOTED OTHERWISE.
2. SPRINKLER HEADS, INCANDESCENT DOWNLIGHTS, DIFFUSERS, ETC. SHALL BE CENTERED IN CEILING PANELS IN BOTH DIRECTIONS, UNLESS OTHERWISE INDICATED.
3. ALL SOFFITS AND VERTICAL SURFACES CONNECTING CEILINGS AND/OR SOFFITS AT DIFFERENT ELEVATIONS SHALL BE CONSTRUCTED OF 3/8" METAL STUDS (22 GAGE) AT 16" O.C. W/ 3/8" GYP. BD. (TYPE 'X'), U.N.O.
4. ALL ELECTRICAL AND MECHANICAL DEVICES SHOWN ON REFLECTED CEILING PLANS ARE FOR GRAPHICAL REPRESENTATION ONLY. SEE ELECTRICAL AND MECHANICAL SHEETS FOR FURTHER INFORMATION.


**LEGEND (REFER TO ELECTRICAL DRAWINGS FOR FURTHER INFORMATION)**

	FLUOR, 2x2, RECESSED INDIRECT, PERF BASKET
	FLUOR, 2x4, RECESSED INDIRECT, PERF BASKET, OR FLUOR, 2x4, PRISMATIC, RECESSED, 2 BALLASTS
	FLUOR, 1x4, SURFACE WRAP
	OVER MIRROR LIGHT, TOILETS, DECORATIVE
	WALL SCONCE
	COMPACT FLUOR, RECESSED, SUSPENDED ELEMENT
	PENDANT MOUNTED, MONO-POINT
	1x4 SURFACE STRIP
	CURVABLE TRACK
	EA EXIT, LED, BATTERY
	EB BATTERY LIGHT UNIT
	EC 2 HEADS W/ 2 WP. REMOTE HEADS
	BATTERY LIGHT, RECESSED
	HVAC SUPPLY GRILL
	HVAC RETURN GRILL
	EF EXHAUST FAN




**CANOPY REFLECTED CEILING PLAN**

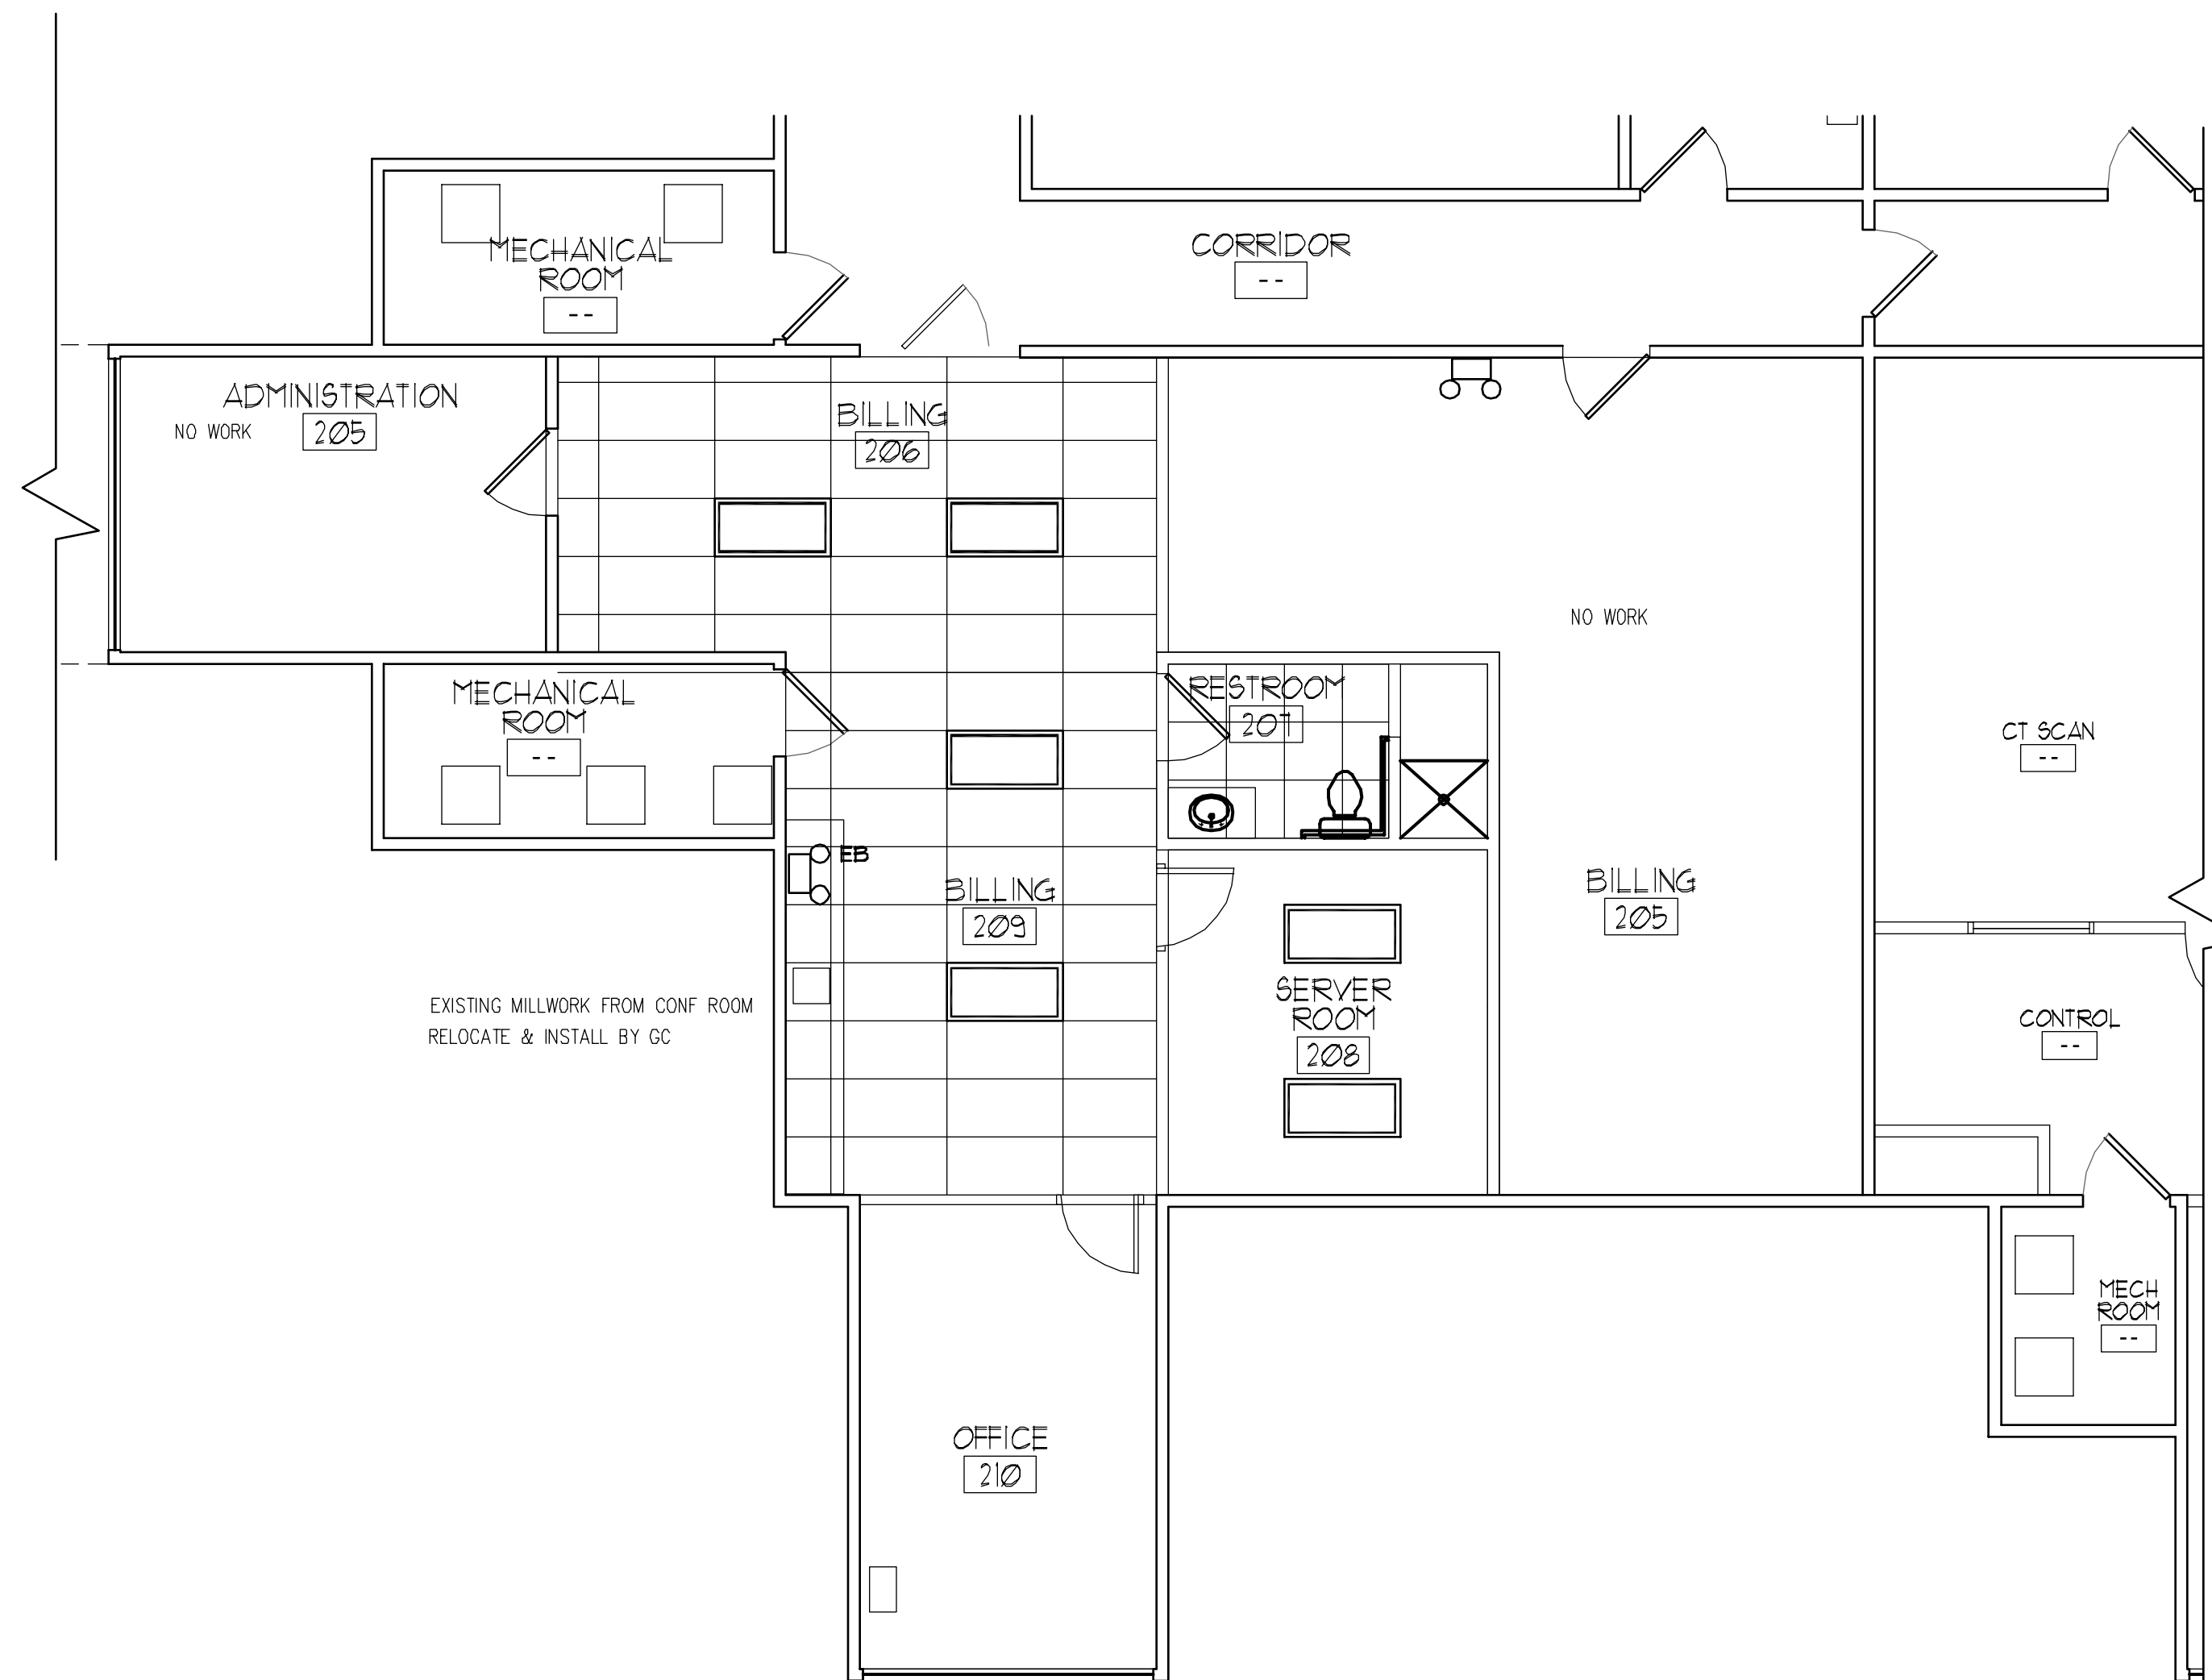SCALE: 1/8" = 1' - 0"



**PARTIAL SECOND FLOOR REFLECTED CEILING PLAN**

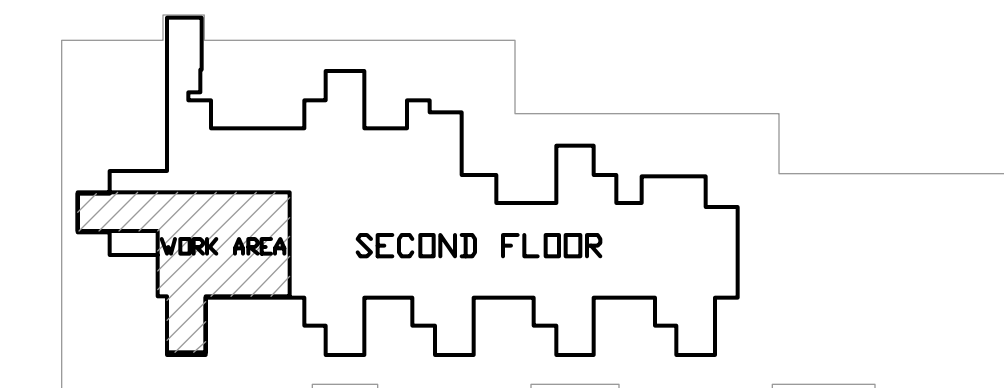SCALE: 3/16" = 1' - 0"




**KEY PLAN**

SCALE: N.T.S.



revisions

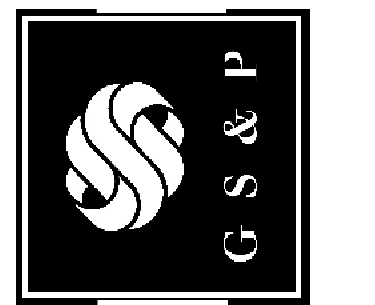
3660 embassy parkway  
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tel. 330.666.5770  
fax. 330.666.8812  
web site www.mann-architects.com



drawing  
PARTIAL 2ND FLOOR REFL. CLG.  
project no. 11406  
date OCTOBER 23, 2007  
scale AS NOTED

COLUMBUS ONCOLOGY

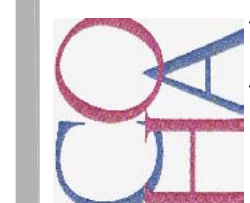JASONIAT PROFESSIONAL BUILDING  
810 JASONIAT AVENUE SUITE A  
COLUMBUS, OHIO 43214-2329




**A.18**

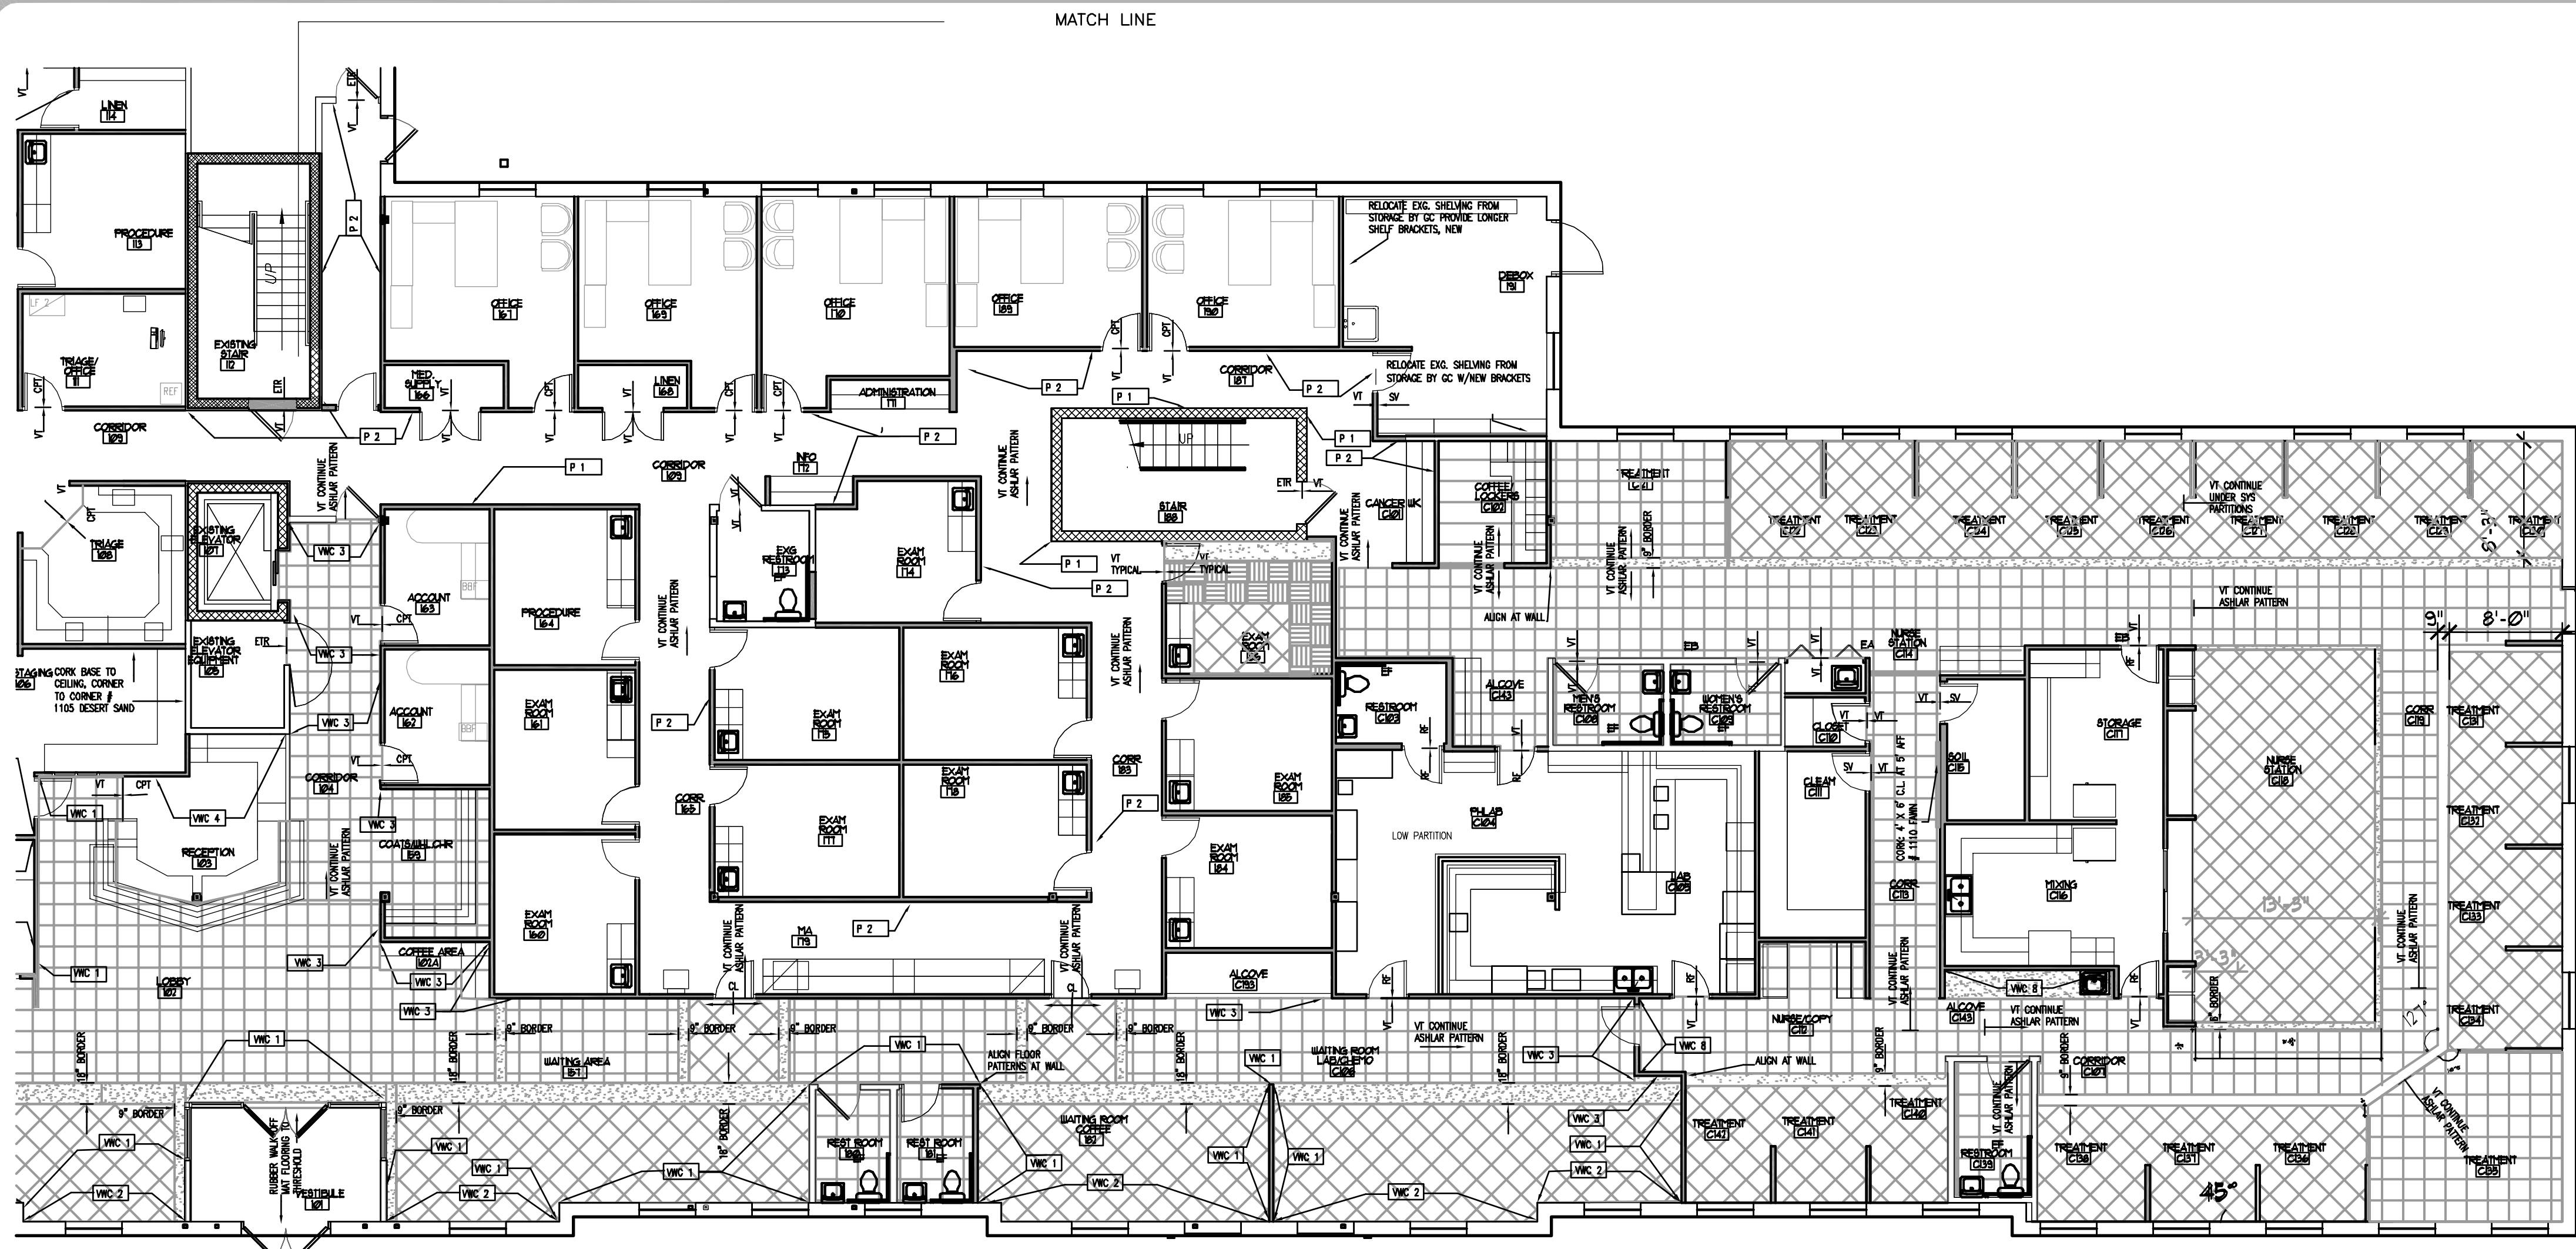OF 18  
sheet no.








**FIRST FLOOR EAST FINISHES LOCATION**

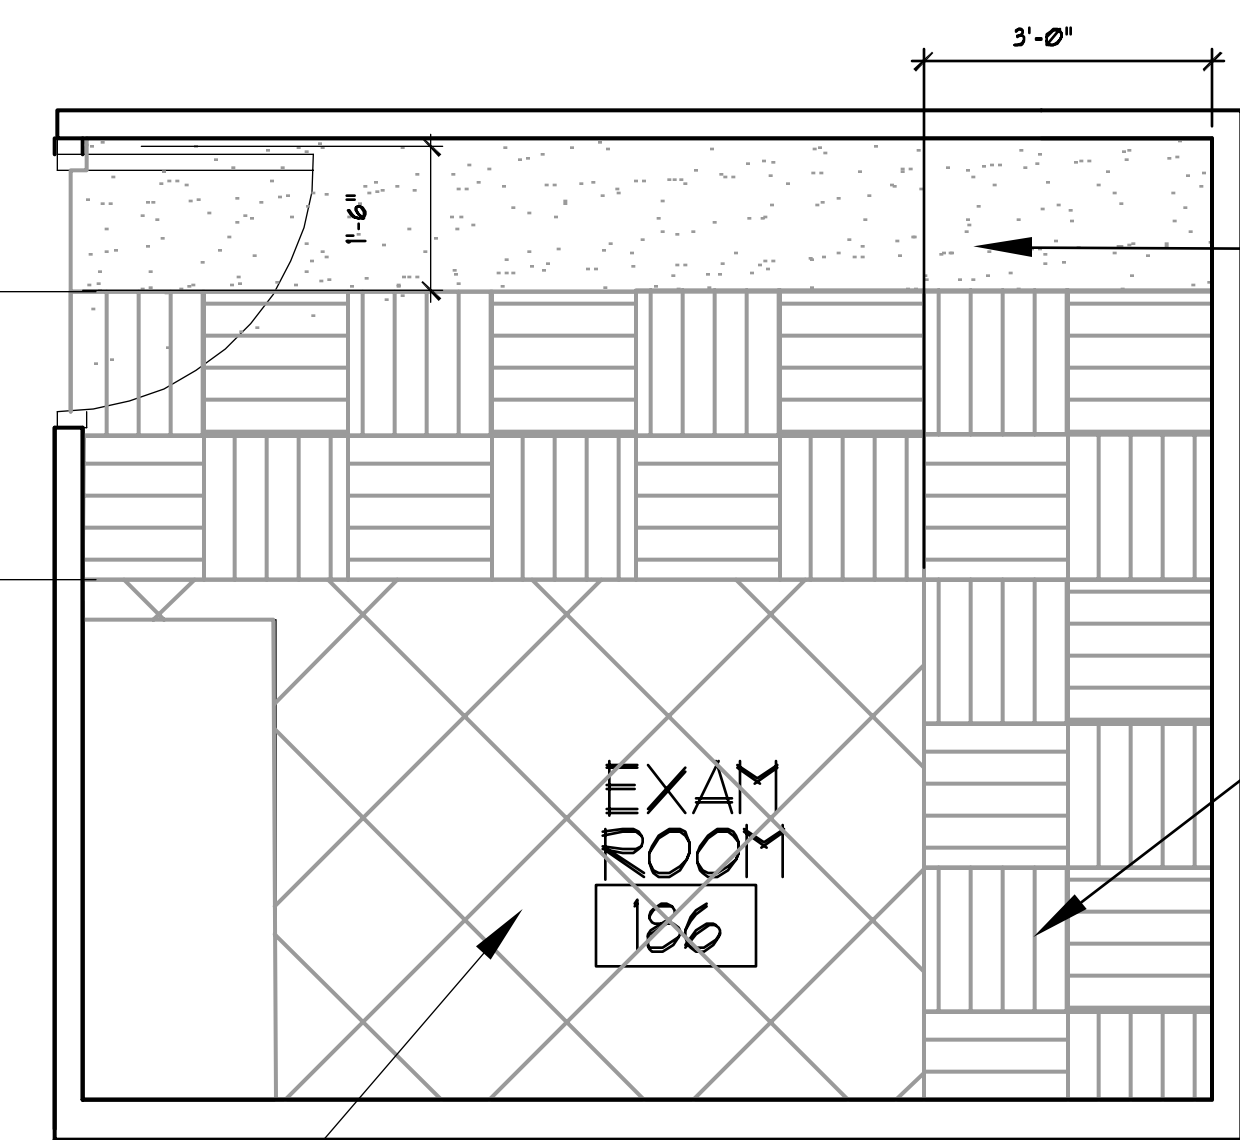SCALE : 1/8" = 1' - 0"



**TYPICAL EXAM/PROCEDURE ROOM**

**FIRST FLOOR FINISHES LOCATION**

SCALE : 1/2" = 1' - 0"

**FINISHES LEGEND AND NOTES**

- ① 18" X 18" VINYL TILE
- ② 18" X 18" VINYL TILE TYPE 1 ASHLAR PATTERN TYPICAL. RIGHT PATTERN INDICATES DIRECTION OF STRIPES IN VINYL TILE; ASHLAR LAID
- ③ VINYL TILE TYPE 2 BORDER AND SEPARATION STRIPS
- ④ VINYL TILE TYPE 3 45° ANGLE INSTALLATION.

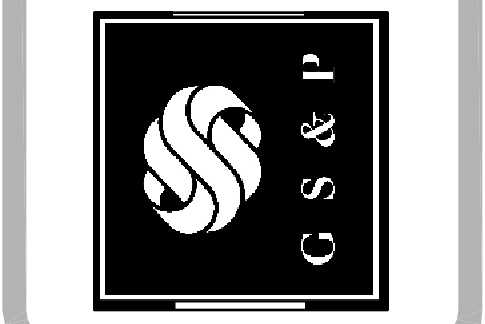
- ⑤ EXTENT OF FINISHES AND FINISH TYPE OR COLOR
- ⑥ FLOOR FINISHES INDICATED BY LOCATION ARE REPRESENTATIONAL. ALL FINISHES ARE TO BE LAID WITH MANUFACTURERS' RECOMMENDED INSTALLATION METHODS AND SHALL INCLUDE LAYING UNDER OVERHANGING MILLWORK, EQUIPMENT, CASEWORK, AND MOVABLE FURNISHINGS BUT NOT UNDER BUILT-IN CABINERY UNLESS DIRECTED OTHERWISE BY ARCHITECTURAL SPECIFICATIONS AND/OR DOCUMENTS. ALL CHANGES IN FINISHES ARE TO MEET AT THE CENTERLINE OF THE DOOR UNLESS EXISTING OR DIRECTED OTHERWISE AND SHALL INCLUDE THOSE CONDITIONS ENCOUNTERED AS DICTATED BY AND ACCORDING TO FIELD CONDITIONS, THRESHOLD CONDITIONS OR REQUIREMENTS, OR BY MANUFACTURER'S RECOMMENDATIONS. FEATHERING OF THRESHOLDS AT RUBBER FLOORING AND WALK OFF MATS AS WELL AS FROM EXISTING TO NEW WORK SHALL BE REQUIRED DUE TO DEPTH OF SURFACE MATERIALS (FLOORING) USED. INSTALLER IS CAUTIONED TO VISIT THE SITE AND OBTAIN A SAMPLE OF EACH MATERIAL PRIOR TO INSTALLATION TO ACQUAINT HIM/HERSELF WITH THE THICKNESS OF THE MATERIAL AND THE TRANSITION REQUIREMENTS.
- ⑦ CONTRACTOR IS TO SUBMIT PHYSICAL SAMPLES OF MANUFACTURER'S FULL RANGE OF COLORS AND STYLES USED FOR EACH TRANSITION STRIP REQUIREMENT, RUBBER OR VINYL BASE, AND OTHER MISCELLANEOUS ACCESSORIES UPON AWARD OF CONTRACT AND NO LESS THAN ONE MONTH PRIOR TO BEGINNING INSTALLATION OF FLOORING.
- ⑧ CONTRACTOR TO SUBMIT FULL SIZE PHYSICAL SAMPLES OF EACH MATERIAL FOR APPROVAL PRIOR TO ORDERING.
- ⑨ ABBREVIATIONS  
 SV SHEET VINYL  
 VT VINYL TILE  
 RT RUBBER TILE  
 SCNG SEALED CONCRETE  
 WDM WALK OFF MAT  
 MEXG MATCH EXISTING  
 ETR EXISTING TO REMAIN  
 VCT VINYL COMPOSITION TILE  
 RF RUBBER FLOOR - ACOUSTIC  
 B BASE  
 P PAINT  
 WC WALLCOVERING
- ⑩ SUBMIT MILLWORK DRAWINGS AND MANUFACTURER'S PHYSICAL SAMPLES OF LAMINATE OR OTHER FINISHES FOR REVIEW AND SELECTION IF NOT NOTED
- ⑪ REFERENCE ARCHITECTURAL DRAWINGS FOR ALL CEILING CONDITIONS.
- ⑫ CORK WALLCOVERING PROVIDE 3/4" UNMOUNTED TACKWALL WITH BUTT JOINTS; APPLY TACK WALL DIRECTLY TO WALL THEN APPLY BASE PER MFG. INSTALLATION INSTRUCTIONS AT RM 106. PROVIDE MFG STD. TRIM AT OTHER LOCATIONS

**NOTES:**  
 THESE DRAWINGS ARE TO BE USED FOR THE PURPOSE OF IDENTIFYING LOCATIONS OF FURNISHINGS AND FINISHES ONLY. THESE DRAWINGS ARE NOT TO BE USED FOR THE PURPOSE OF CONSTRUCTION. REFERENCE ARCHITECTURAL DRAWINGS FOR ANY ITEM OR CONDITION FOR CONSTRUCTION. DO NOT SCALE THESE DRAWINGS FOR CONSTRUCTION OR INSTALLATION.



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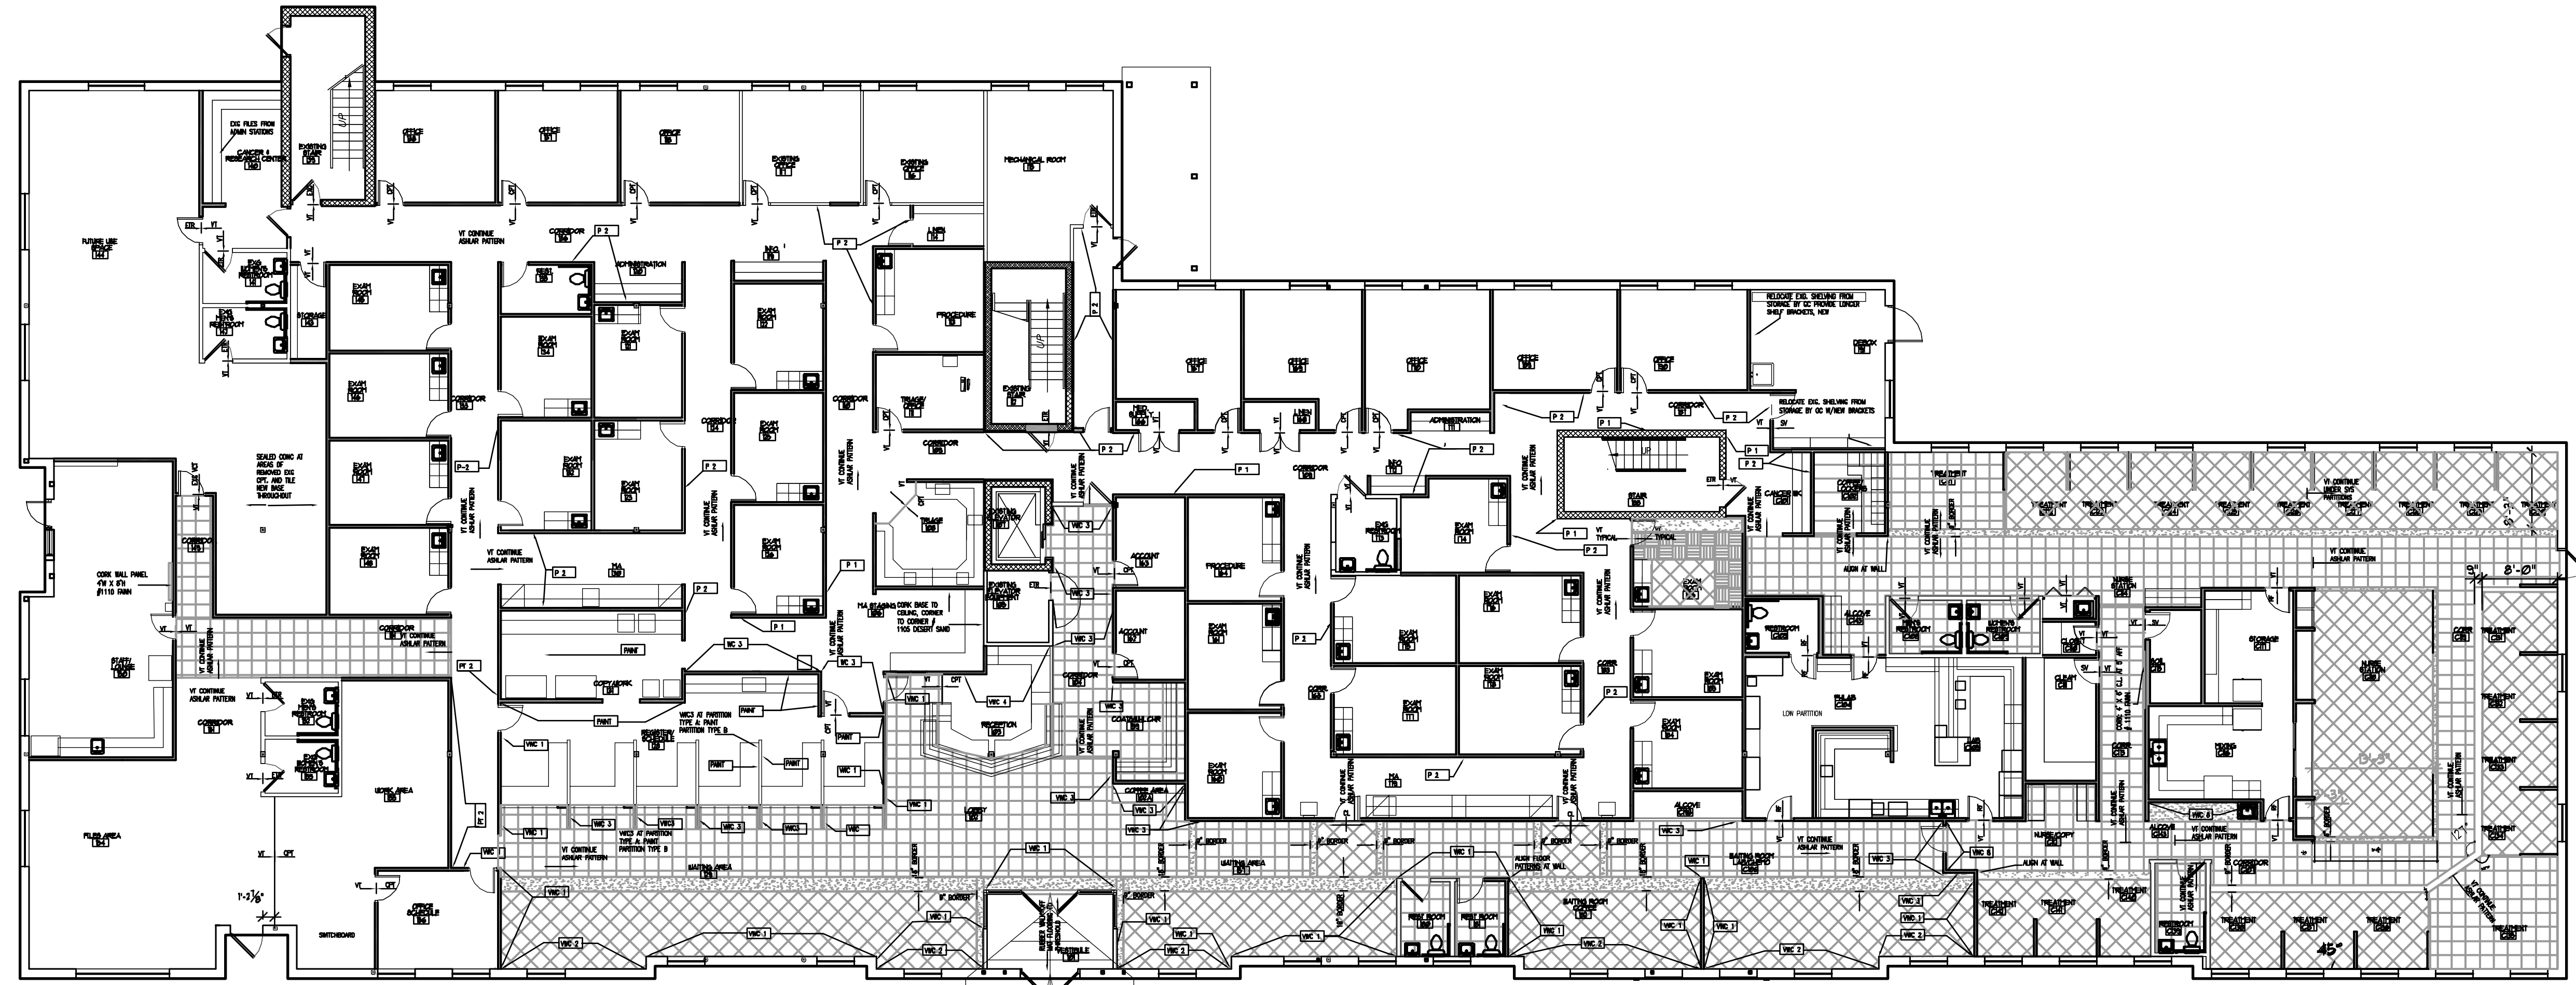
3660 embassy parkway  
 akron, ohio 44333  
 tel. 330.666.5770  
 fax. 330.666.8812  
 web site www.mann-architects.com



drawing  
**FIRST FLOOR INTERIORS - EAST**  
 project no. 11406  
 date OCTOBER 23, 2007  
 scale AS NOTED  
**COLUMBUS ONCOLOGY**  
 JASONIAT PROFESSIONAL BUILDING  
 810 JASONIAT AVENUE, SUITE A  
 COLUMBUS, OHIO 43214-2393

Interior Designer  
 Martha Allison,  
 Consultant  
 2734 E Main St. Box 210  
 Columbus, Oh 43209

**ID-2**  
 OF 5  
 sheet no.

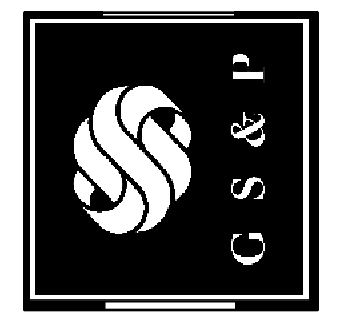
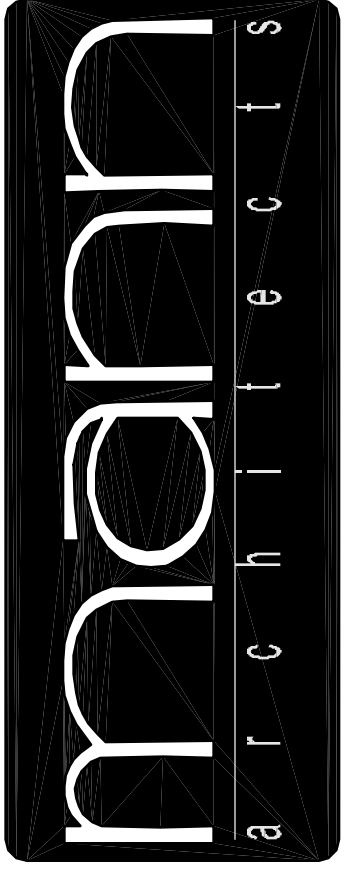


**FIRST FLOOR FINISHES - OVERALL**  
 SCALE : 3/32" = 1' - 0"

NOTES:  
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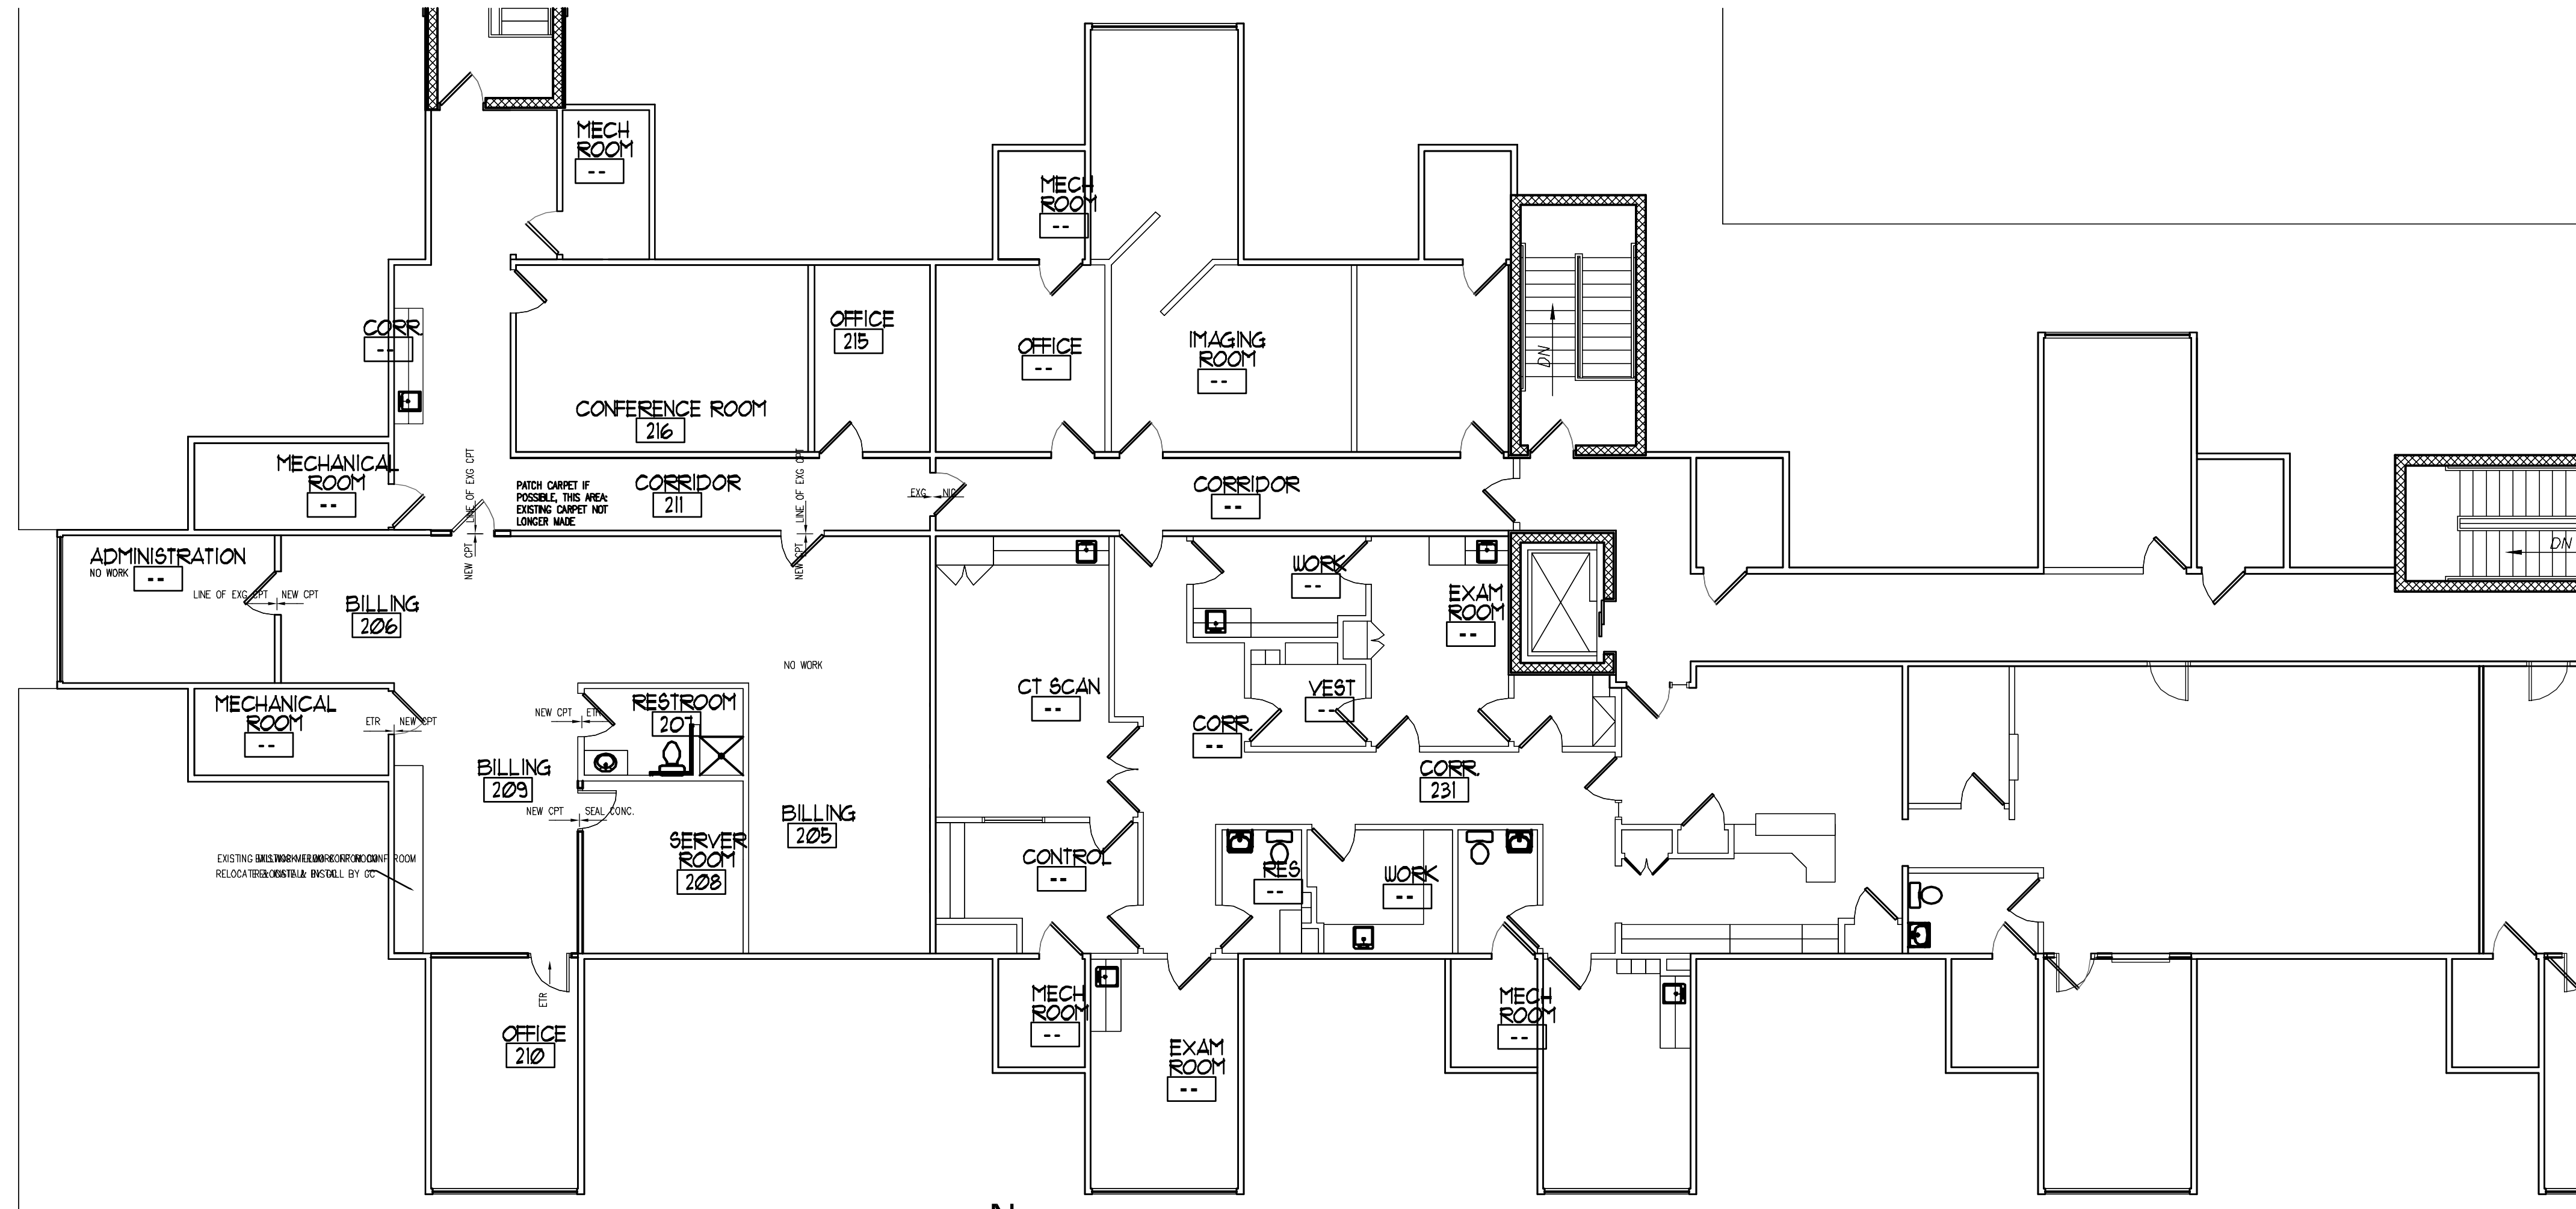
drawing  
**FIRST FLOOR INTERIORS - OVERALL**  
 project no. 11406  
 date OCTOBER 23, 2001  
 scale AS NOTED  
**COLUMBUS ONCOLOGY**  
 JASONIAT PROFESSIONAL BUILDING  
 810 JASONIAT AVENUE, SUITE A  
 COLUMBUS, OHIO 43214-2393  
 project

**ID-3**  
 OF 5  
 sheet no.

Interior Designer  
 Martha Allison,  
 Consultant  
 2734 E Main St. Box 210  
 Columbus, Oh 43209

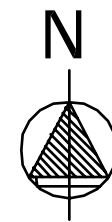


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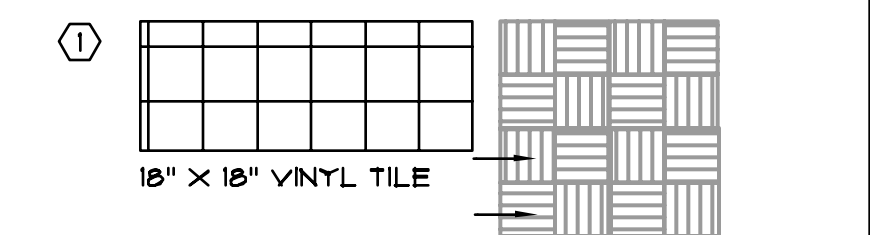


**SECOND FLOOR FINISHES - WEST**

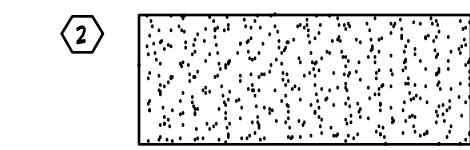
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**FINISHES LEGEND AND NOTES**




18" X 18" VINYL TILE  
3' X3' ASHLAR PATTERN



VINYL TILE TYPE 2 BORDER AND SEPARATION STRIPS



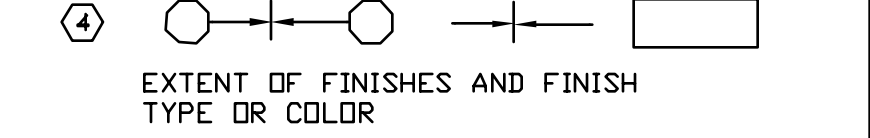VINYL TILE TYPE 3 45° ANGLE INSTALLATION.



EXTENT OF FINISHES AND FINISH TYPE OR COLOR

5 FLOOR FINISHES INDICATED BY LOCATION ARE REPRESENTATIONAL. ALL FINISHES ARE TO BE LAID WITH MANUFACTURER'S RECOMMENDED INSTALLATION METHODS AND SHALL INCLUDE LAYING UNDER OVERHANGING MILLWORK, EQUIPMENT, CASEWORK, AND MOVABLE FURNISHINGS BUT NOT UNDER BUILT-IN CABINERY UNLESS DIRECTED OTHERWISE BY ARCHITECTURAL SPECIFICATIONS AND/OR DOCUMENTS. ALL CHANGES IN FINISHES ARE TO MEET AT THE CENTERLINE OF THE DOOR UNLESS EXISTING OR DIRECTED OTHERWISE AND SHALL INCLUDE THOSE CONDITIONS ENCOUNTERED AS DICTATED BY AND ACCORDING TO FIELD CONDITIONS, THRESHOLD CONDITIONS OR REQUIREMENTS, OR BY MANUFACTURER'S RECOMMENDATIONS. FEATHERING OF THRESHOLDS AT RUBBER FLOORING AND WALK OFF MATS AS WELL AS FROM EXISTING TO NEW WORK SHALL BE REQUIRED DUE TO DEPTH OF SURFACE MATERIALS (FLOORING) USED. INSTALLER IS CAUTIONED TO VISIT THE SITE AND OBTAIN A SAMPLE OF EACH MATERIAL PRIOR TO INSTALLATION TO ACQUAINT HIM/HERSELF WITH THE THICKNESS OF THE MATERIAL AND THE TRANSITION REQUIREMENTS.

6 CONTRACTOR IS TO SUBMIT PHYSICAL SAMPLES OF MANUFACTURER'S FULL RANGE OF COLORS AND STYLES USED FOR EACH TRANSITION STRIP REQUIREMENT, RUBBER OR VINYL BASE, AND OTHER MISCELLANEOUS ACCESSORIES UPON AWARD OF CONTRACT AND NO LESS THAN ONE MONTH PRIOR TO BEGINNING INSTALLATION OF FLOORING.

7 CONTRACTOR TO SUBMIT FULL SIZE PHYSICAL SAMPLES OF EACH MATERIAL FOR APPROVAL PRIOR TO ORDERING.


- 8 ABBREVIATIONS  
 SV SHEET VINYL  
 VT VINYL TILE  
 RT RUBBER TILE  
 SCNC SEALED CONCRETE  
 WOM WALK OFF MAT  
 MEXG MATCH EXISTING  
 ETR EXISTING TO REMAIN  
 VCT VINYL COMPOSITION TILE  
 RF RUBBER FLOOR - ACOUSTIC  
 B BASE  
 P PAINT  
 WC WALLCOVERING

9 SUBMIT MILLWORK DRAWINGS AND MANUFACTURER'S PHYSICAL SAMPLES OF LAMINATE OR OTHER FINISHES FOR REVIEW AND SELECTION IF NOT NOTED

10 REFERENCE ARCHITECTURAL DRAWINGS FOR ALL CEILING CONDITIONS.


11 CORK WALLCOVERING PROVIDE 1/2" UNMOUNTED TACKWALL WITH BUTT JOINTS; APPLY TACK WALL DIRECTLY TO WALL THEN APPLY BASE PER MFG. INSTALLATION INSTRUCTIONS AT RM 106. PROVIDE MFG STD. TRIM AT OTHER LOCATIONS

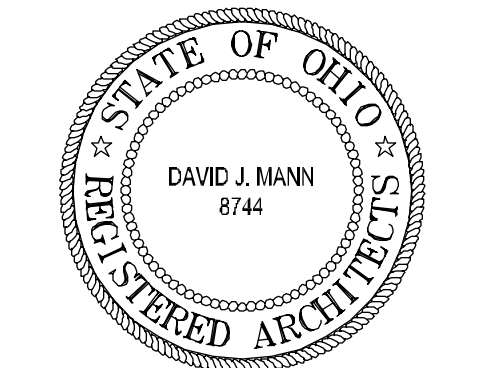NOTES:  
 THESE DRAWINGS ARE TO BE USED FOR THE PURPOSE OF IDENTIFYING LOCATIONS OF FURNISHINGS AND FINISHES ONLY. THESE DRAWINGS ARE NOT TO BE USED FOR THE PURPOSE OF CONSTRUCTION. REFERENCE ARCHITECTURAL DRAWINGS FOR ANY ITEM OR CONDITION FOR CONSTRUCTION. DO NOT SCALE THESE DRAWINGS FOR CONSTRUCTION OR INSTALLATION.



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drawing  
 SECOND FLOOR FINISHES - WEST scale  
 project no. 11406 date OCTOBER 23, 2007 AS NOTED  
 COLUMBUS ONCOLOGY  
 JASONIAT PROFESSIONAL BUILDING  
 810 JASONIAT AVENUE, SUITE A  
 COLUMBUS, OHIO 43214-2393  
 project

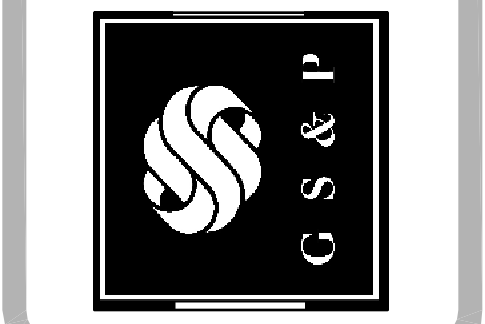sheet no. ID-4 OF 5

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USER  
 REV/DATE  
 FNAME

FINISH SCHEDULE LEGEND: ROOM FINISH SCHEDULE

Table with columns: ROOM NO., ROOM NAME, FLOOR, BASE, WALLS (NORTH, EAST, SOUTH, WEST), CEILING MATL., CEILING HT., REMARKS. Lists various rooms like RESTROOM, WAITING / COFFEE, CORRIDOR, EXAM ROOM, etc.

SECOND FLOOR

Table with columns: ROOM NO., ROOM NAME, FLOOR, BASE, WALLS, CEILING MATL., CEILING HT., REMARKS. Lists rooms on the second floor like STORAGE, BREAK ROOM, OFFICE, BILLING, RESTROOM, SERVER ROOM, CONFERENCE ROOM.

GENERAL NOTES:

ABBREVIATIONS
ETR EXISTING TO REMAIN
MEX MATCH EXISTING
OTHERS OTHER ABBREVIATIONS ARE LISTED IN THE SCHEDULE ON THIS SHEET AND ON THE ROOM FINISH DRAWINGS WITH THIS SET
LPM LOW PARTITIONS AT TREAT C21 THROUGH C43 SHALL MATCH THE WALL FINISH ADJACENT TO THE MAIN WALL BEHIND

FN1 UNLESS OTHERWISE NOTED PREFINISHED, OR EXTERIOR, ALL DOOR FRAMES SHALL BE P-2. SECOND FLOOR FRAMES SHALL MATCH EXISTING UNLESS OTHERWISE NOTED. ALL BASE BUILDING PAINT FINISHES SHALL BE P-1. PAINTED METALS SHALL MATCH THE WALL FINISH ON WHICH THEY OCCUR
FN2 SECOND FLOOR: MATCH EXISTING PAINT AND FINISHES THROUGHOUT. CONFIRM BASE AND PAINT COLORS BY SUPPLYING A 1' SQ. PAINT FINISH TO WALLS AND A 1' LONG PAINT FINISH TO FRAME FOR OWNER'S APPROVAL PRIOR TO PROCEEDING
FN3 REUSE EXISTING ACT IN GOOD SHAPE, WITHOUT CHIPS OR DAMAGES IN AREAS NOT EXPOSED TO THE PUBLIC SUCH AS CLOSETS, STORAGE, ETC. INVENTORY EXISTING ACT AND LABEL IF DIFFERENT ONE FROM ANOTHER. ACT 3 SHALL NOT BE SUBSTITUTED FOR RECYCLED TILES.

ROOM FINISH SCHEDULE

Table with columns: ROOM NO., ROOM NAME, FLOOR, BASE, WALLS (NORTH, EAST, SOUTH, WEST), CEILING MATL., CEILING HT., REMARKS. Lists various rooms like CANOPY, VESTIBULE, LOBBY, RECEPTION, CORRIDOR, ELEVATOR, etc.

FINISH SCHEDULE LEGEND:

CEILING:
ACT1 2'x4' ARMSTRONG OPTIMA, 15/16 SQ. REGULAR EDGE # 3253, 24X48
ACT2 2'x2' ARMSTRONG FINE FIGURED, SQUARE EDGE #8109P
ACT3 2'x4' ARMSTRONG FINE FIGURED, SQUARE EDGE #8109P
ACT4 REUSE EXISTING FROM THIS AREA OR USE SALVAGE FROM DEMO AT OTHER AREAS
WALL BASE:
WLB1 4" RESILIENT BASE, COVE, USE WITH RESILIENT FLOORING, JOHNSONITE 129 SILK
WLB2 4" RESILIENT BASE, COVE, USE CARPET, JOHNSONITE 129 SILK
WLB3 4" RESILIENT BASE, COVE, JOHNSONITE # 130 816AL, RUBBER FOR USE WITH RUBBER FLR
WLB4 4" RESILIENT BASE, STRAIGHT, MATCH EXISTING
WLB5 4" RESILIENT BASE, STRAIGHT, JOHNSONITE JET BLACK, RUBBER
WALL FINISHES:
PAINTED DRYWALL:
(1) COAT LATEX PRIMER/ SEALER, (1) COAT LATEX EGGSHELL LOW LUSTER FINISH, RESTROOMS-PROVIDE ALKYL EQUIVALENT
PAINTED FRAMES:
(1) COAT LATEX METAL PRIMER/ SEALER, (1-2) COATS LATEX EGGSHELL LOW LUSTER
PTD DRYWALL, SOFFITS AND CEILING ELEMENTS SHALL BE CEILING WHITE UNLESS NOTED OTHERWISE. PAINTED FRAMES SHALL BE P2 ON FIRST FLR THROUGHOUT. OBJECTS OCCURRING UPON WALLS ARE TO MATCH THE WALL COLOR UPON WHICH THEY OCCUR. BASE BUILDING PAINT IS P-1 ON FIRST FLOOR. CONTRACTOR SHALL MATCH ALL PAINTS ON THE SECOND FLOOR AND AT EXISTING CONDITIONS. SUPPLY ONE PHYSICAL SAMPLE OF EACH COLOR, 12"x12" AND MANUFACTURER'S COMPLETE FAN DECK FOR MATCHING AND APPROVAL PRIOR TO INSTALLATION OF ANY FINISH.
F1 SHERWIN WILLIAMS PAPER WHITE # 1105 (BASE BUILDING WHITE)
F2 SHERWIN WILLIAMS NAFERY #3386
CW CEILING WHITE
WALLCOVERINGS SHALL BE FROM MANUFACTURER AS LISTED BELOW. PROVIDE ONE 9"x9" PHYSICAL SAMPLE FOR MATCHING AND APPROVAL PRIOR TO ORDERING WALLCOVERING. INSTALL IN ACCORDANCE WITH MANUFACTURER'S RECOMMENDED METHODS, INCLUDING WALL PREPARATION AND ADHESIVES.
VWC1 MDC WALLCOVERINGS/GENON: RENEGADE, MOOSEWOOD W2 RG 11
VWC2 MDC WALLCOVERINGS: GENON RENEGADE SQUARE, MOOSEWOOD W2 RG11/434
VWC3 WOLF GORDON WALLCOVERINGS, BARBARY SAXONY # BRY 1-246
VWC4 WOLF GORDON WALLCOVERINGS, PERMAFROST MAMMOTH #ST-1-2650
VWC5 WOLF GORDON WALLCOVERINGS, BARBARY STENDAL # BRY 1-244
VWC6 NOT USED
VWC7 NOT USED
VWC8 WOLF GORDON SIMPLICITY VIDELLA # SM 1-319
VWC9 WOLF GORDON FEATHERS FLURAGE # FTR-1104
CORK CLARIDGE TACKWALL 4U X DIMENSION INDICATED. PROVIDE 1005 DESERT SAND AT R1 106 AND 110 FAUN AT OTHER LOC
FLOOR FINISHES:
VINYL TILE: TILE 1 IS TO BE LAID IN AN ASHLAR PATTERN THROUGHOUT. TILE 2 & 3 ARE RANDOM MATCH LAY. TILE SIZE IS 18" X 18" SQ. SEE FINISH DRAWINGS FOR ADDITIONAL INFORMATION. THIS IS A NEW TILE AND CONTRACTOR MUST CONTACT MANNINGTON REPRESENTATIVE FOR PRICING AND SCHEDULING.
VT1 MANNINGTON WORKS, NATURE'S PATHS SELECT, PARALLELS, GOLDEN HUBK
VT2 MANNINGTON WORKS NATURE'S PATHS SELECT, FIERA, YELLOWSTONE
VT3 MANNINGTON WORKS NATURE'S PATHS SELECT, FIERA, CONCRETE
CPT 1 CARPET BLUEBRIDGE 18"MODULAR 5450T SPINDELEBACK, #5012 METAL
SV ARMSTRONG MEDITECH TANDEM # 21496 TEA GARDEN GREEN
WOM RUBBER WALK OFF MAT, ROPPE RUBBER RIP CORD TILE, COLOR: DK GREEN
RS NORAPLAN MEGA HIGH PERFORMANCE RUBBER FLOORING #2613 TOFFEE
CPT 2 SECOND FLOOR ONLY: MANNINGTON CARTHAGE IV COLOR: CREST VALLEY
MISCELLANEOUS FINISHES:
FOR ALL OTHER FINISHES, SUBMIT FROM MANUFACTURER'S FULL RANGE OF COLORS AND TYPES, INCLUDING PREMIUM GRADE. SUBMIT PHYSICAL SAMPLES WHENEVER POSSIBLE.
FOR WOOD WORK THROUGHOUT, MATCH EXISTING WOOD DOORS AND CASEWORK FINISH AND SUBMIT NO LESS THAN 3 SAMPLES STAINED UPON THE SAME WOOD AS THE FINAL DOOR SPECIES BEING PROVIDED, TO REVIEW VARIATION IN GRAIN AND STAIN. STAIN SHALL MATCH OR BE SATIN FINISH. SUBMIT FINAL FINISH WITH STAINED SAMPLE

VERTICAL EXITS, EXITWAYS:

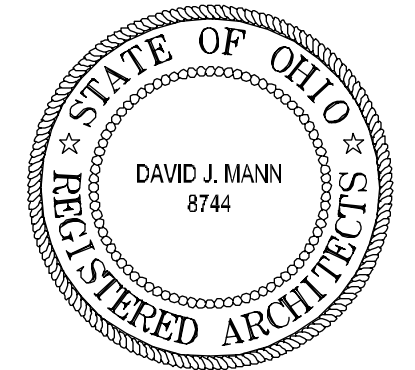
INTERIOR FINISH OF WALLS AND CEILING SHALL HAVE A FLAME SPREAD RATING NOT GREATER THAN THE FOLLOWING FOR USE GROUP B:
WALLS: CL486 C
CEILING: CL486 C
FLOORS: CL486 II

ENCLOSED AREAS, SPACES, OR ROOMS

INTERIOR FINISH OF WALLS AND CEILING SHALL HAVE A FLAME SPREAD RATING NOT GREATER THAN THE FOLLOWING FOR USE GROUP B:
WALLS & CEILING: CL486 C
FLOORS: CL486 I/OC FF-1

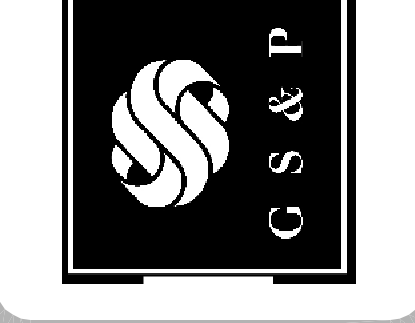
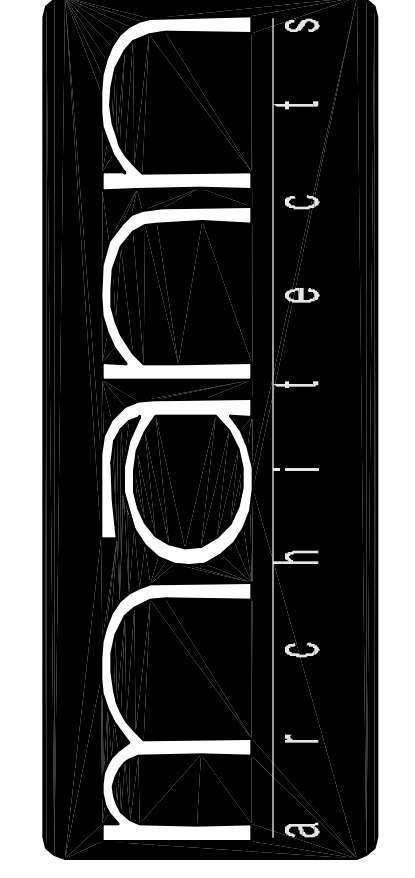
EXIT ACCESS CORRIDORS

INTERIOR FINISH OF INTERIOR ACCESS CORRIDORS SHALL HAVE A FLAME SPREAD RATING NOT GREATER THAN THE FOLLOWING FOR USE GROUP B:
WALLS: CL486 C
CEILING: CL486 C
FLOORS: CL486 II
ALL OTHER AREAS SHALL COMPLY WITH THE DOC FF-1 "FILL TEST" INCLUDING CARPET.



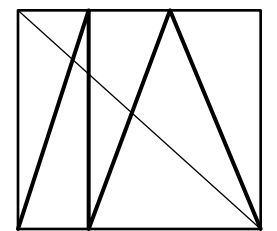
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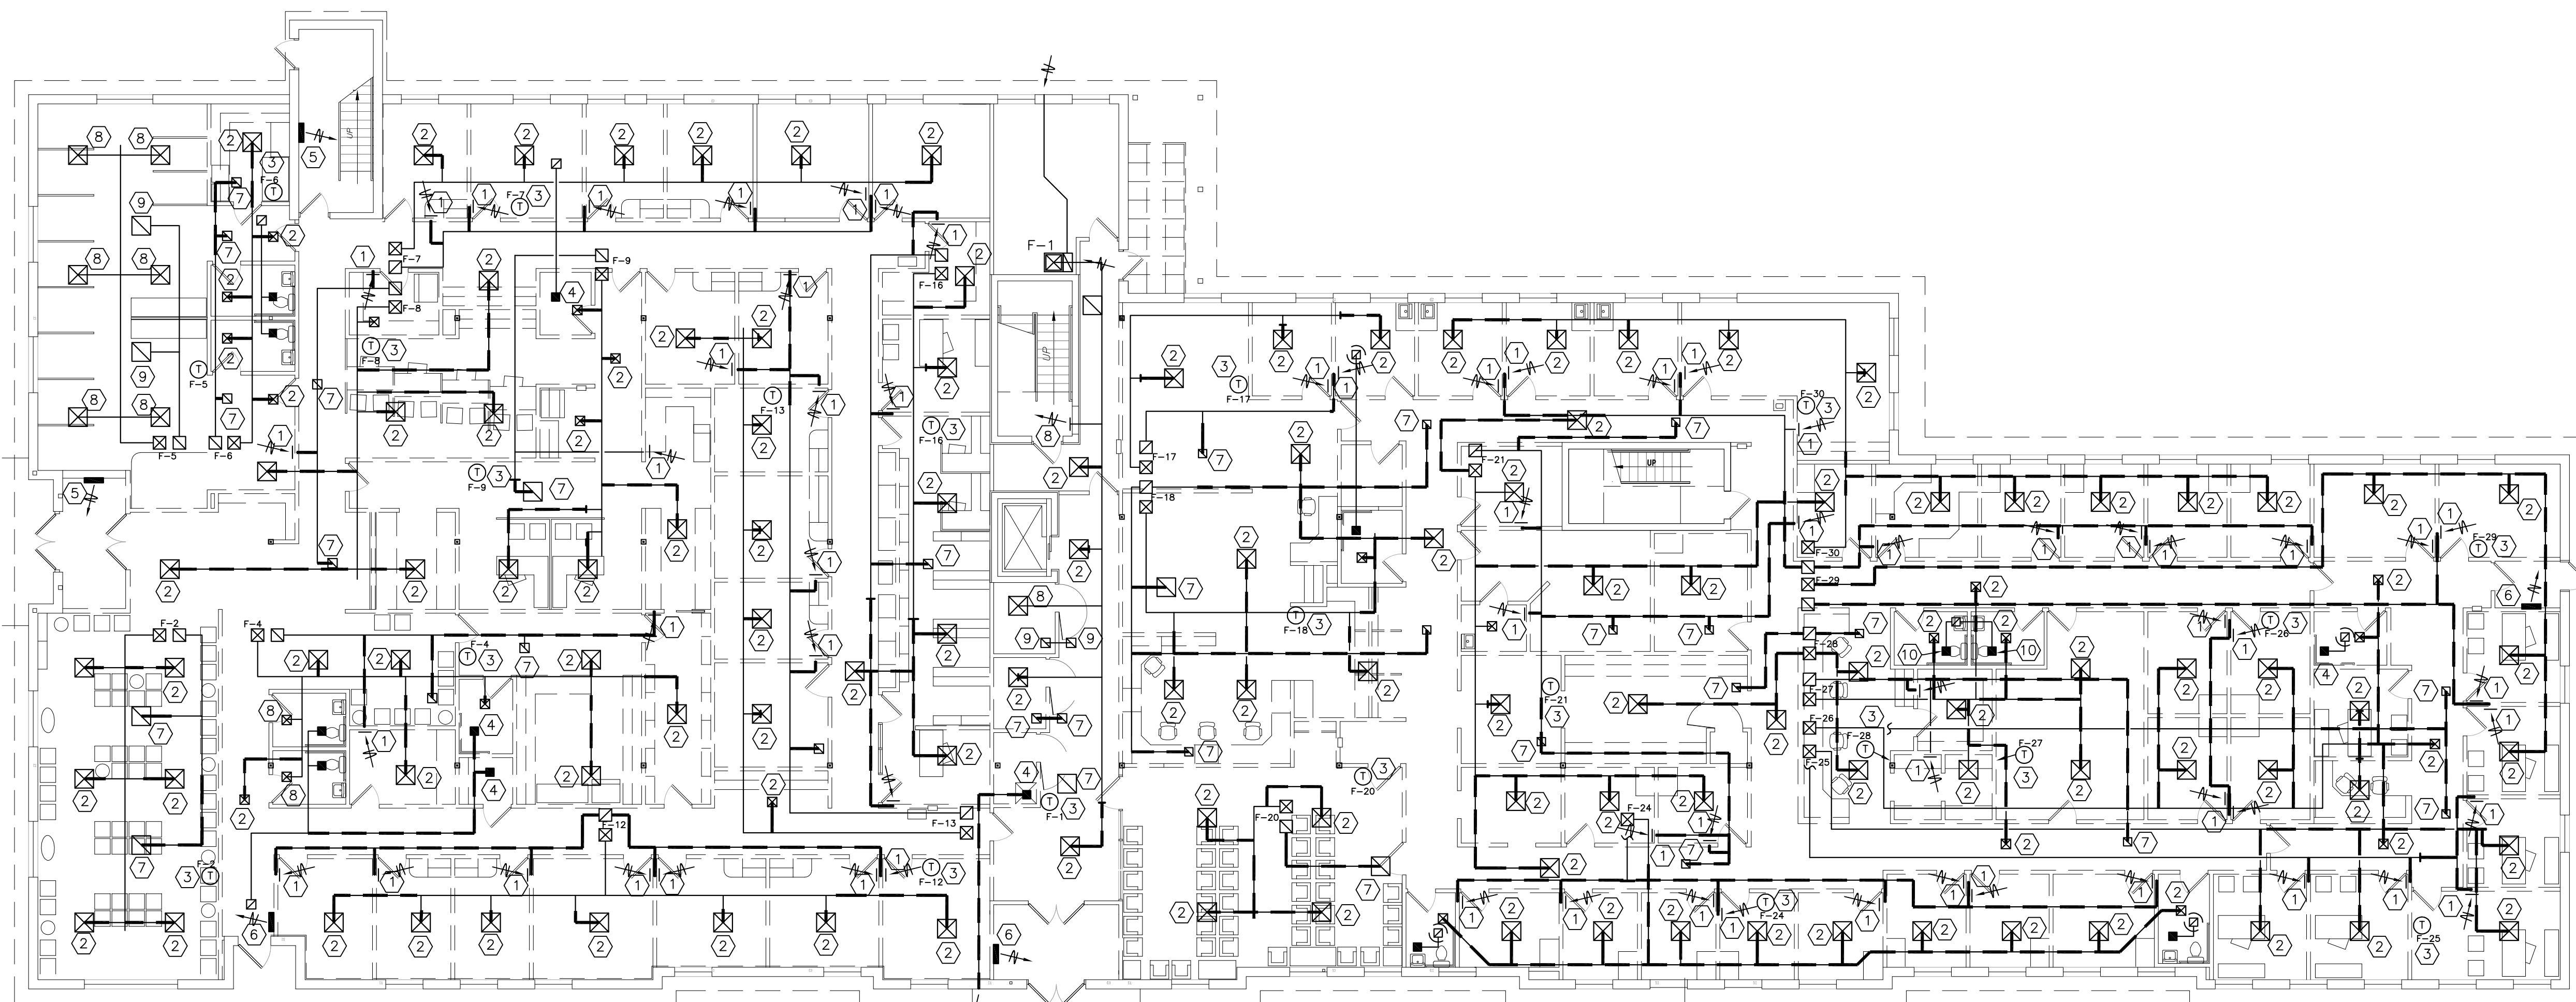


ROOM FINISH SCHEDULE & NOTES
scale AS NOTED
date OCTOBER 23, 2007
COLUMBUS ONCOLOGY
JASONIAT PROFESSIONAL BUILDING
810 JASONIAT AVENUE, SUITE A
COLUMBUS, OHIO 43214-2329

drawing project no. 11406




Interior Designer
Martha Allison,
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**FIRST FLOOR HVAC DEMOLITION PLAN**


SCALE: 3/32" = 1' - 0"



**SECOND FLOOR HVAC DEMOLITION PLAN**

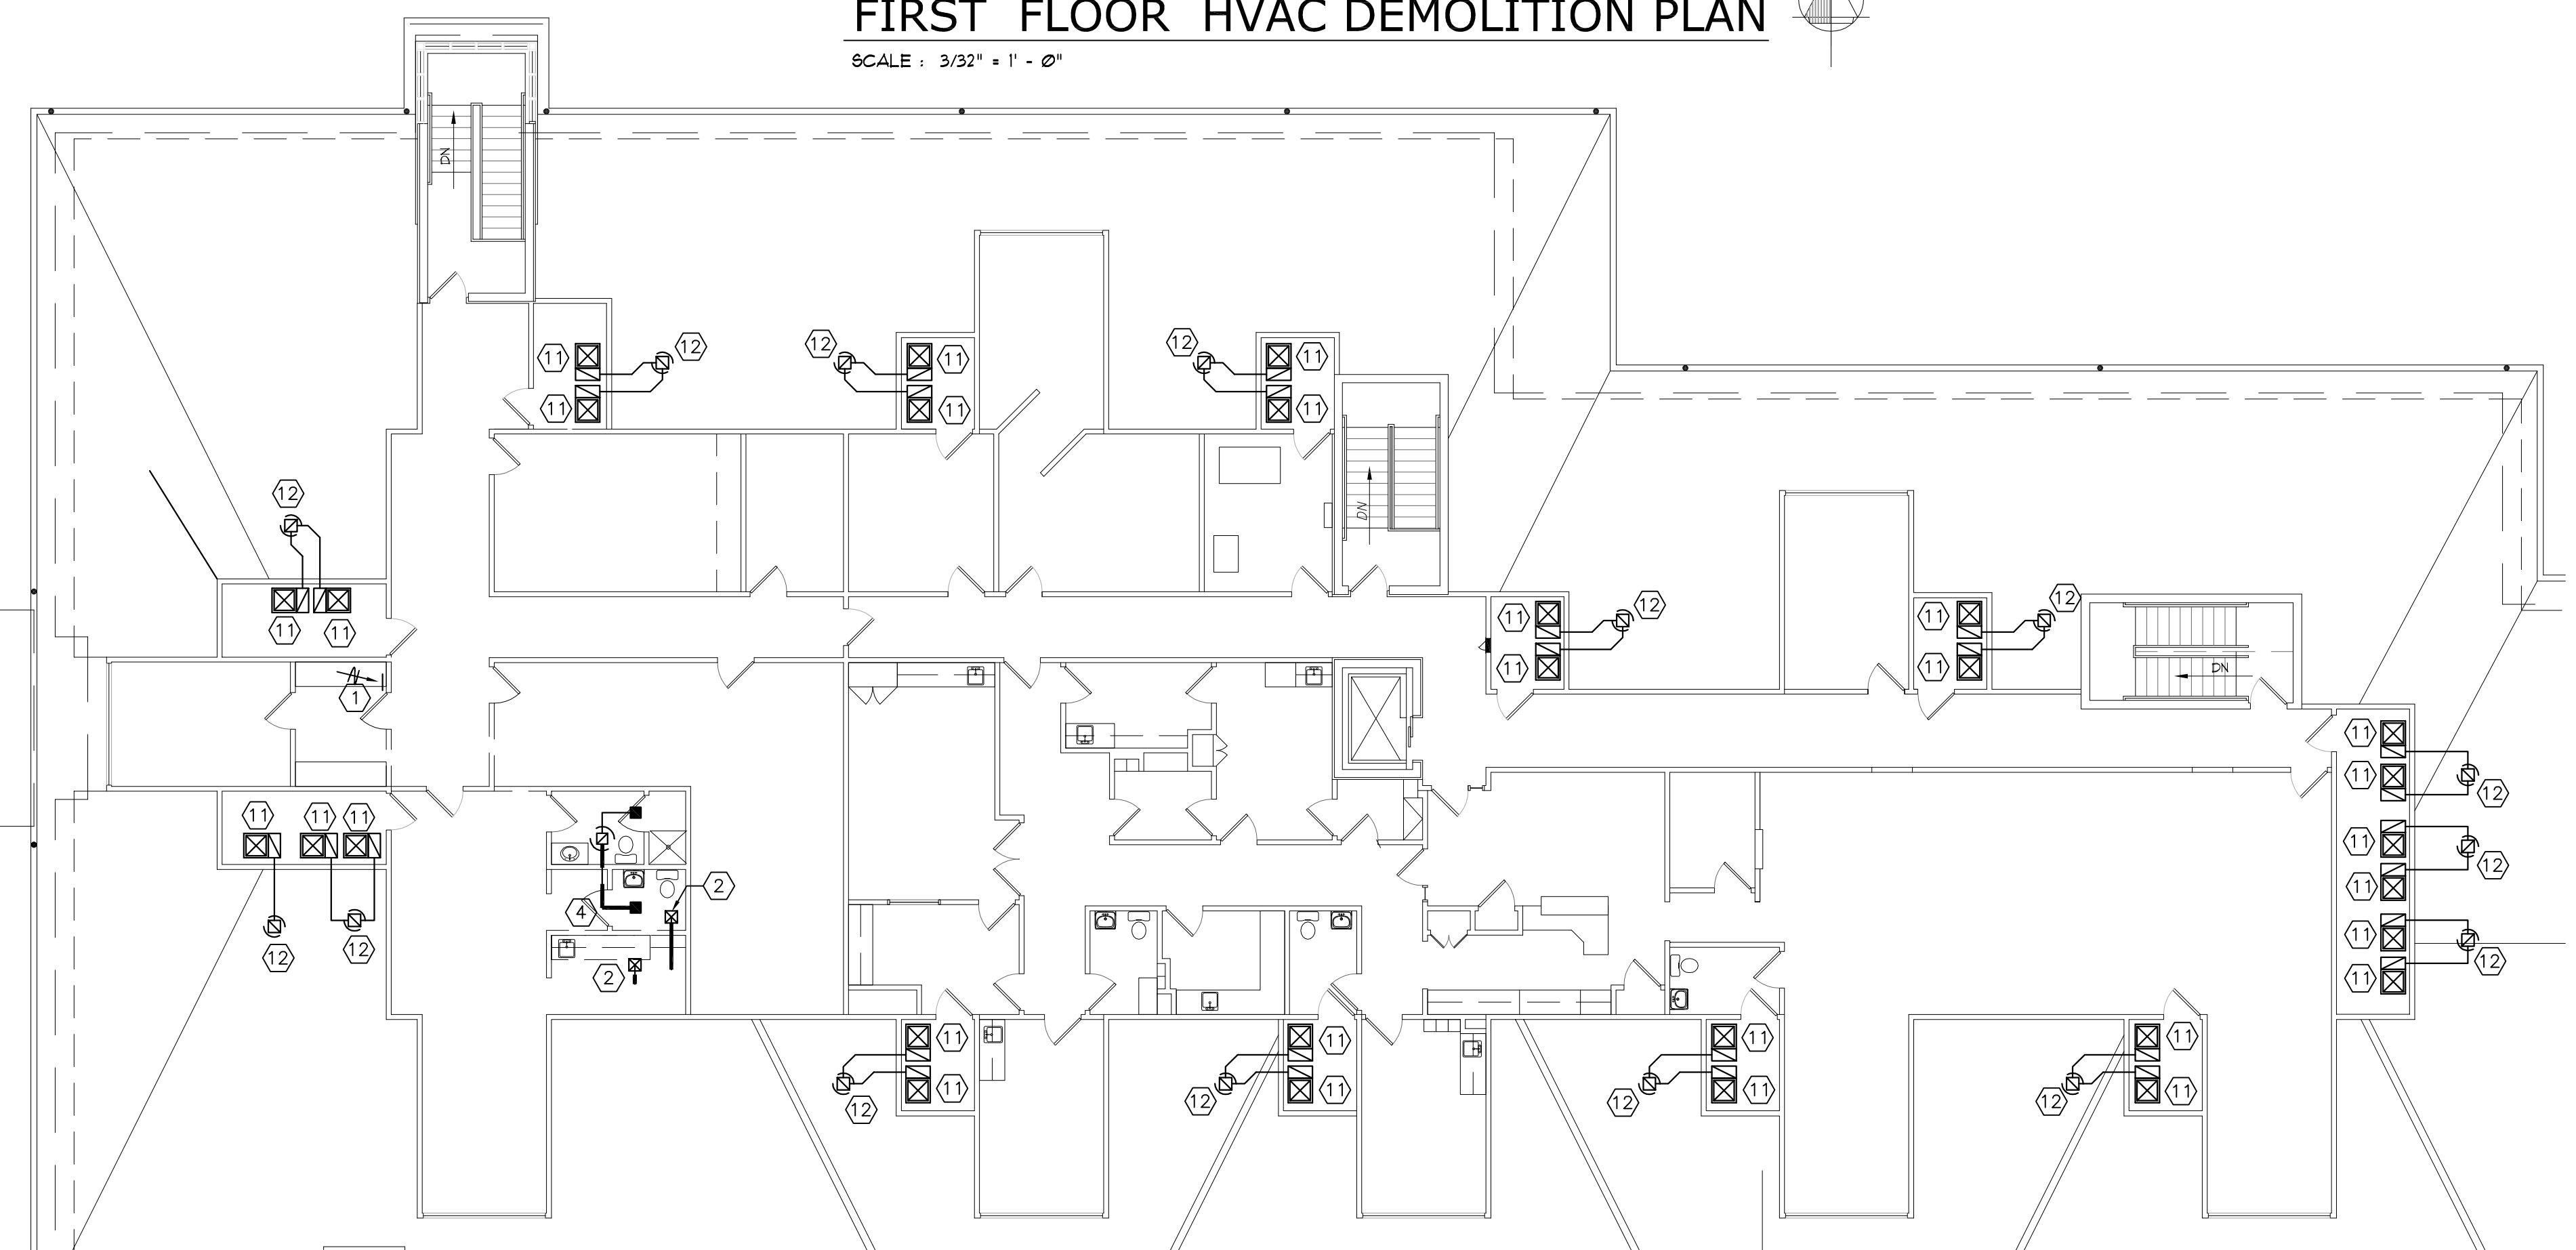SCALE: 3/32" = 1' - 0"

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 CONSULTING, INC.  
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 LOUISVILLE, OHIO 4601  
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**GENERAL NOTES**

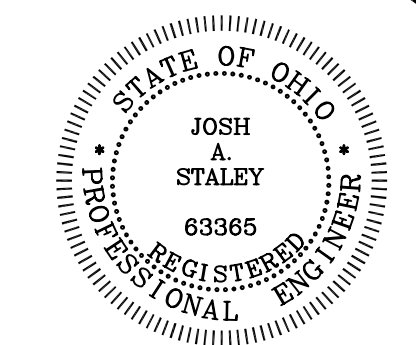- 1 SEE ARCHITECTURAL DETAILS FOR EXACT LOCATIONS AND DIMENSIONS OF EQUIPMENT, FIXTURES, OPENINGS AND OUTLETS. COMMUNICATE WITH ARCHITECT ANY DISCREPANCIES.
- 2 THIS CONTRACTOR TO PROVIDE ALL OPENINGS IN EXISTING STRUCTURE AS REQUIRED FOR NEW WORK INCLUDING FLASHINGS AND REPAIRS FOR ROOF OPENINGS AND CAULKING AND SEALING FOR WALL OPENINGS LEAVING A WEATHER-PROOF CONDITION.
- 3 THIS CONTRACTOR TO PATCH ANY UNUSED OPENINGS LEFT FROM DEMOLITION WORK LEAVING A LIKE NEW CONDITION. SEAL ANY ROOF OR WALL OPENINGS WEATHER-PROOF.
- 4 COORDINATE ALL INSTALLATIONS OF MATERIAL AND EQUIPMENT WHICH IS EXPOSED TO VIEW INSIDE AND OUTSIDE OF STRUCTURE WITH OWNER AND ARCHITECT BEFORE PURCHASE. ALL MUST BE REVIEWED AND APPROVED BEFOREHAND.
- 5 THIS CONTRACTOR IS TO COORDINATE ELECTRICAL CHARACTERISTICS OF EQUIPMENT WITH ELECTRICAL CONTRACTOR BEFORE ORDERING ANY EQUIPMENT.

**CODED NOTES**

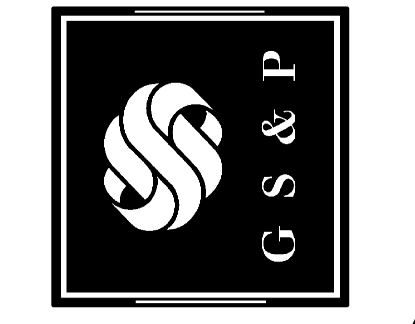
- 1 REMOVE EXISTING RETURN AIR REGISTER AT WALL AND DUCT AS INDICATED. CAP EXISTING RETURN AIR DUCT AT MAIN OR LEAVE FOR CONNECTION OF NEW DUCT. REFER TO NEW PLAN FOR MORE INFORMATION.
- 2 REMOVE EXISTING SUPPLY AIR DIFFUSER AND DUCT AS INDICATED. CAP EXISTING SUPPLY AIR DUCT AT MAIN OR LEAVE FOR CONNECTION OF NEW DUCT. REFER TO NEW PLAN FOR MORE INFORMATION.
- 3 REMOVE AND RELOCATE EXISTING THERMOSTAT. REFER TO NEW PLAN FOR MORE INFORMATION.
- 4 REMOVE EXISTING EXHAUST FAN AND DUCT AS INDICATED. RETURN OVER TO OWNER OR REUSE AS PART OF NEW PROJECT. REFER TO NEW PLAN FOR MORE INFORMATION.
- 5 EXISTING WALL HEATER TO REMAIN.
- 6 REMOVE EXISTING WALL HEATER. RETURN OVER TO OWNER.
- 7 REMOVE EXISTING RETURN AIR REGISTER IN CEILING AND DUCT AS INDICATED. CAP EXISTING RETURN AIR DUCT AT MAIN OR LEAVE FOR CONNECTION OF NEW DUCT. REFER TO NEW PLAN FOR MORE INFORMATION.
- 8 EXISTING SUPPLY AIR DIFFUSER TO REMAIN.
- 9 EXISTING RETURN AIR REGISTER TO REMAIN.
- 10 EXISTING EXHAUST FAN TO REMAIN.
- 11 EXISTING FURNACE TO REMAIN. REFER TO NEW PLAN FOR MORE INFORMATION.
- 12 EXISTING OUTSIDE AIR INTAKE HOOD.

**HVAC SYMBOL LEGEND**

ABBREVIATION	SYMBOL	DESCRIPTION
		THERMOSTAT(FURNACE TAG)
		BALANCE DAMPER
SD-1		SUPPLY AIR DIFFUSER WITH NECK SIZE AND AIRFLOW
SR-1		SUPPLY AIR REGISTER WITH NECK SIZE AND AIRFLOW
RG-1		RETURN AIR GRILLE WITH NECK SIZE AND AIRFLOW
14/10(E)		EXISTING DUCT
F		FURNACE
EF(E)		EXISTING EXHAUST FAN
EF		EXHAUST FAN
EW		EXISTING ELECTRIC HEATER
		EXISTING DUCT TO BE DEMOLISHED

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drawing

HVAC DEMOLITION PLAN

project no. 11406

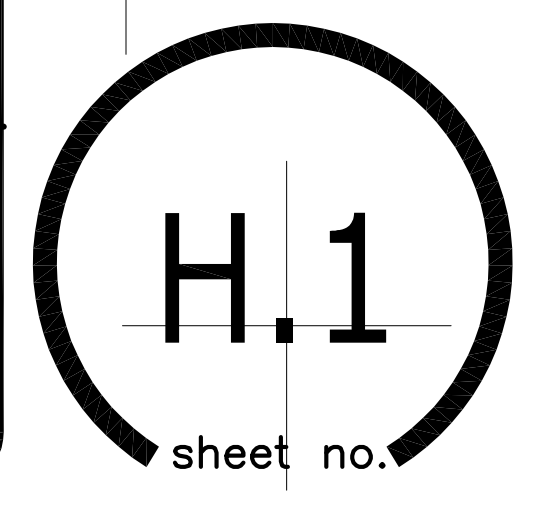
scale AS NOTED

date OCTOBER 23, 2007

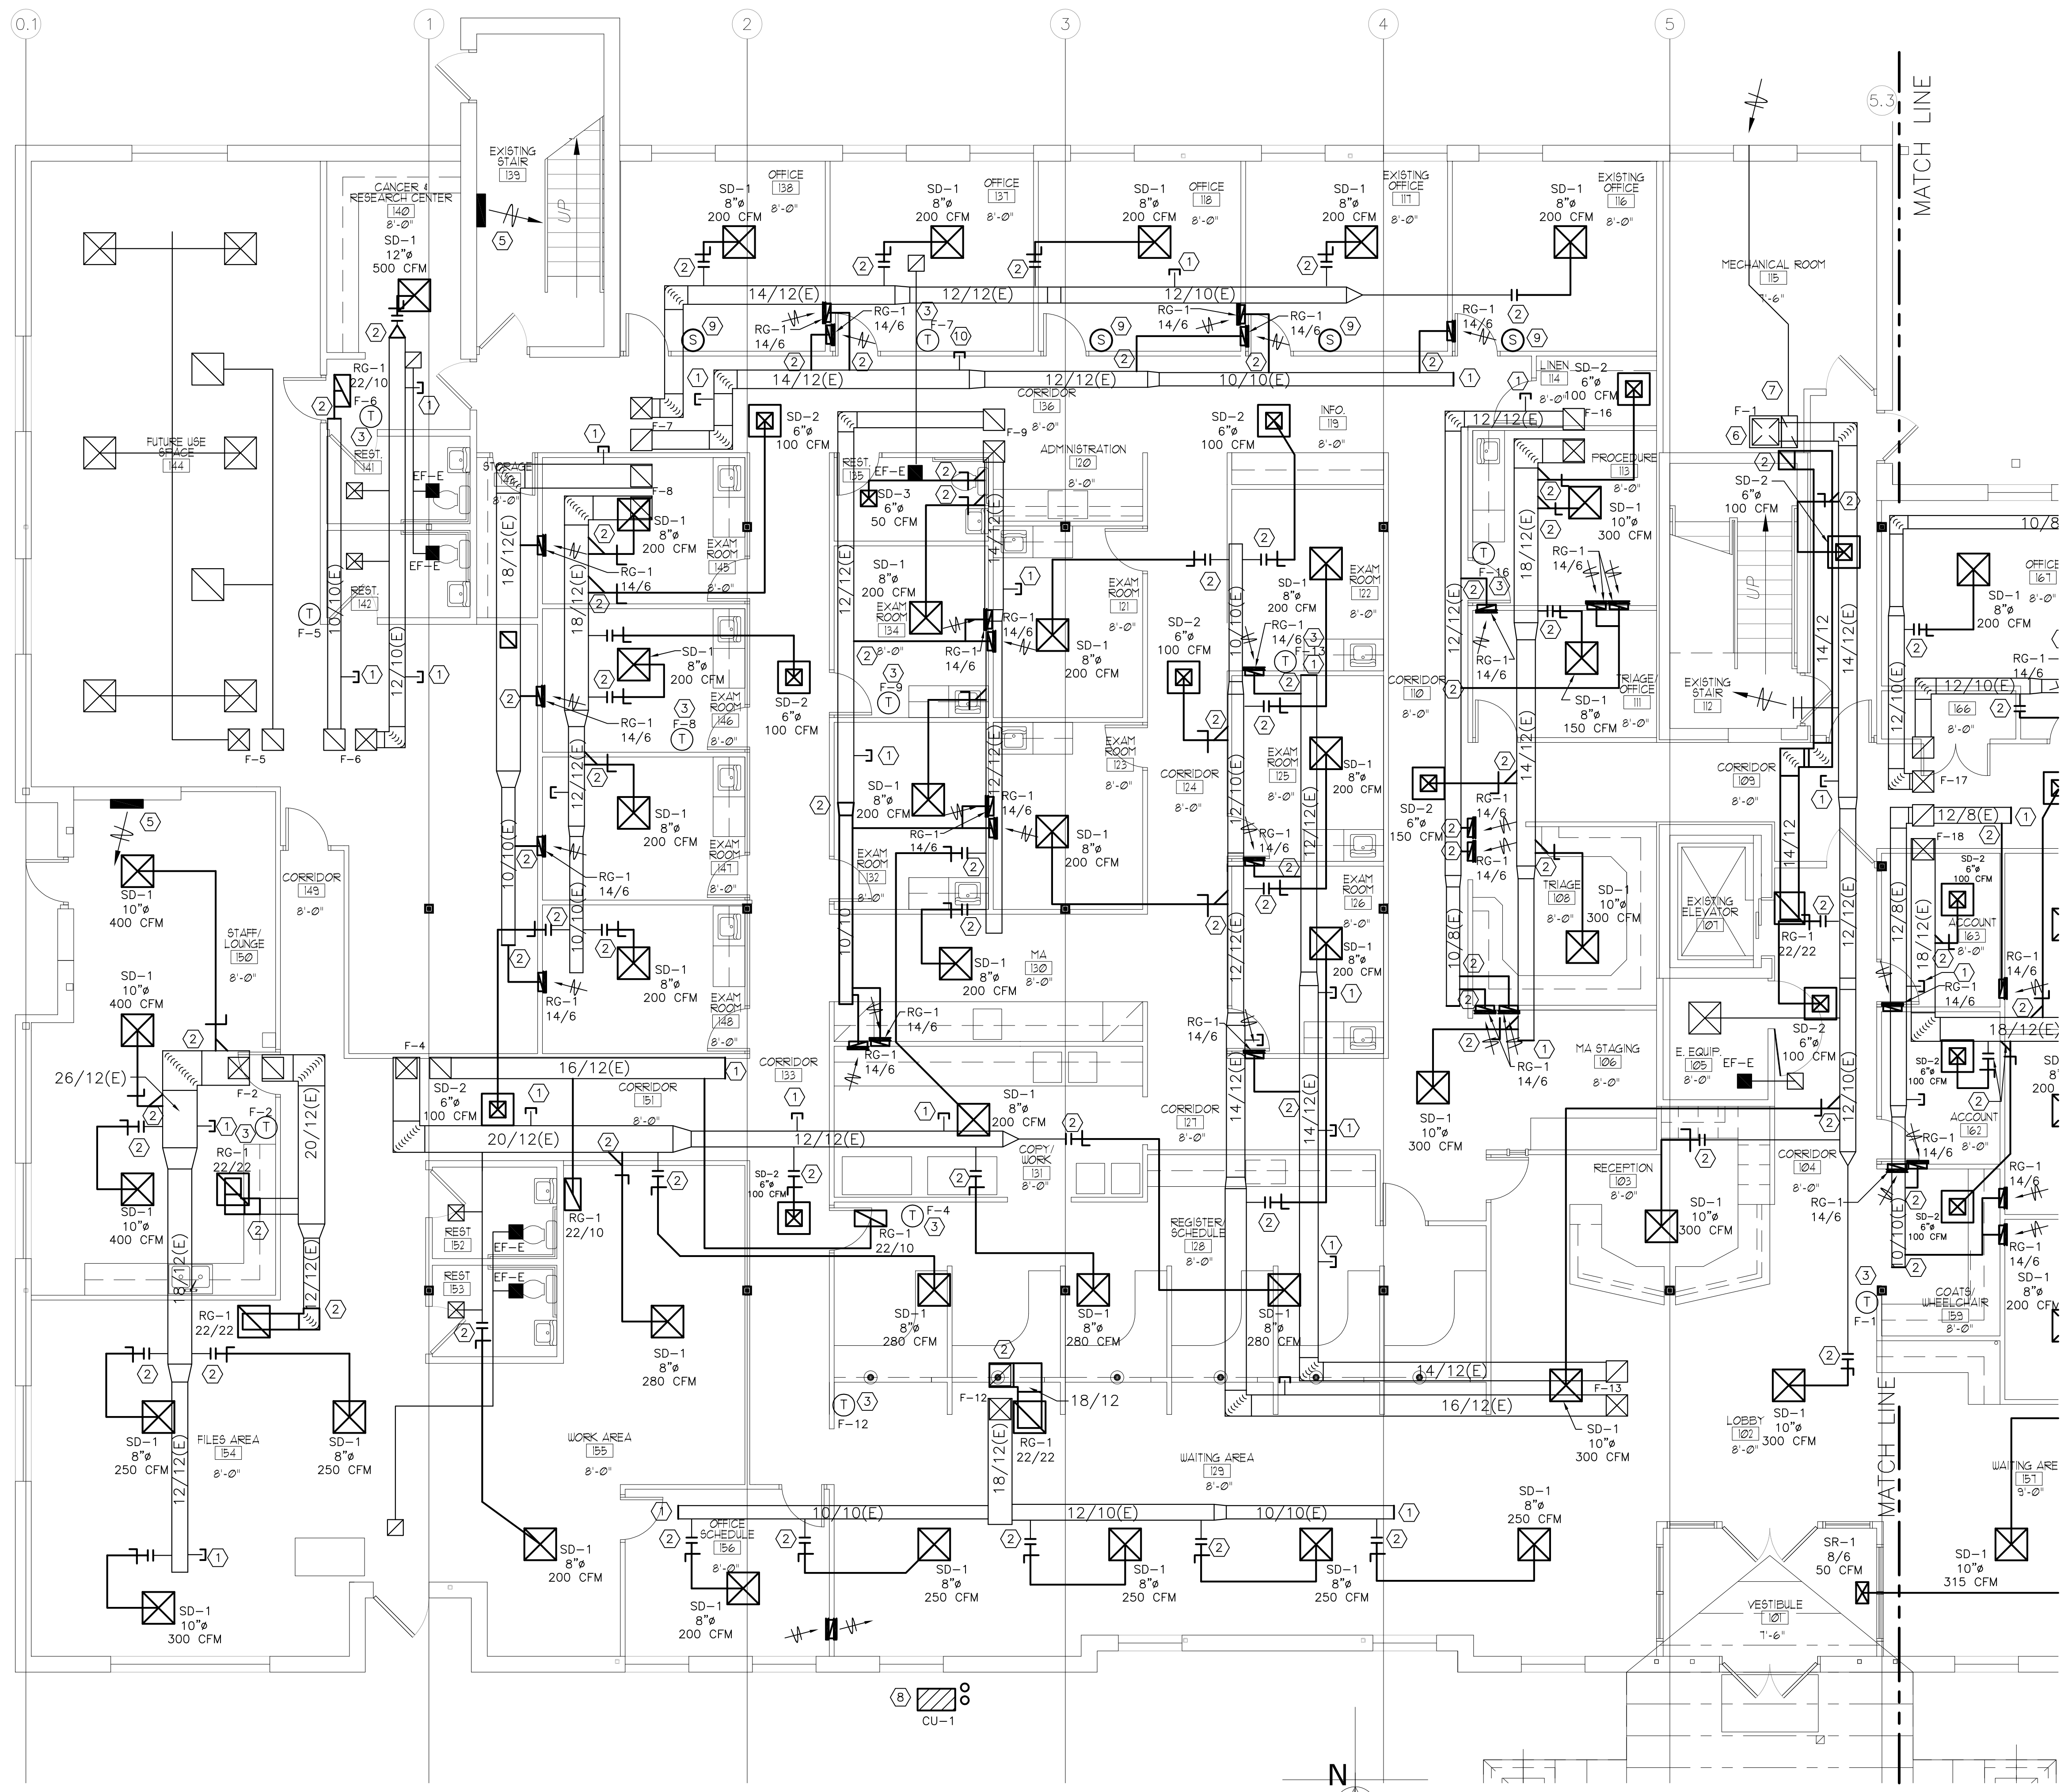
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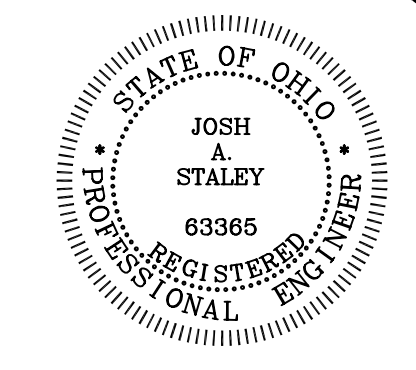


sheet no.



**PARTIAL FIRST FLOOR HVAC PLAN**  
 SCALE: 3/16" = 1' - 0"

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**GENERAL NOTES**



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- 5 THIS CONTRACTOR IS TO COORDINATE ELECTRICAL CHARACTERISTICS OF EQUIPMENT WITH ELECTRICAL CONTRACTOR BEFORE ORDERING ANY EQUIPMENT.

**CODED NOTES**

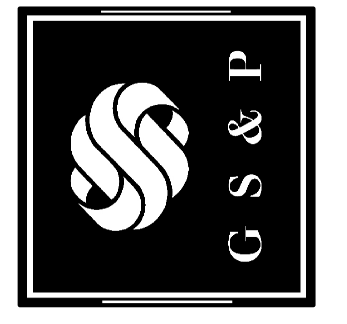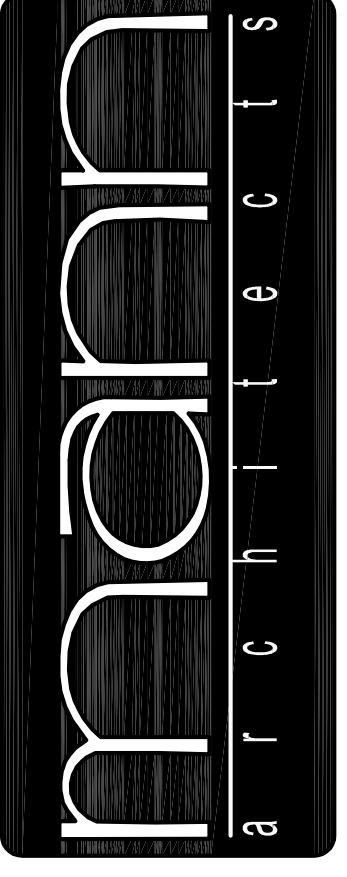- 1 CAP EXISTING DUCT BRANCH AT MAIN OR END OF DUCT MAIN WITH SHEET METAL PATCH OR CAP AND SEAL AIR TIGHT.
- 2 CONNECT TO EXISTING DUCT AND EXTEND TO AIR DEVICE OR BRANCH MAIN AS INDICATED.
- 3 EXISTING RELOCATED THERMOSTAT. EXTEND WIRING AS REQUIRED.
- 4 EXISTING RELOCATED EXHAUST FAN. EXTEND 6" DUCT TO RELIEF VENTILATOR AS INDICATED.
- 5 EXISTING WALL HEATER.
- 6 VACUUM CLEAN INSIDE OF EXISTING FURNACE AND REPLACE FILTERS AFTER CONSTRUCTION IS COMPLETE.
- 7 BALANCE OUTSIDE AIR DAMPERS TO EXISTING FURNACES TO VALUES INDICATED ON OUTSIDE AIR SCHEDULE.
- 8 SECURE CONDENSING UNIT TO 6" HIGH CONCRETE PAD. SIZE AND INSTALL REFRIGERATION PIPE PER MANUFACTURERS INSTRUCTIONS.
- 9 ROOM SENSOR TO PROVIDE SIGNAL TO AVERAGING TEMPERATURE CONTROLLER. PROVIDE ALL WIRING FOR A COMPLETE WORKING SYSTEM.
- 10 NEW THERMOSTAT FOR FURNACE CAPABLE OF AVERAGING THE READINGS FROM REMOTE SENSORS.

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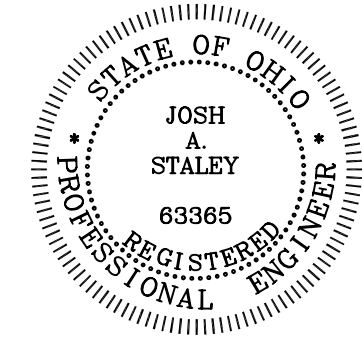
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drawing  
 HVAC PLANS  
 project no. 11406  
 date OCTOBER 23, 2007  
 scale AS NOTED  
**COLUMBUS ONCOLOGY**  
 JASONIAT PROFESSIONAL BUILDING  
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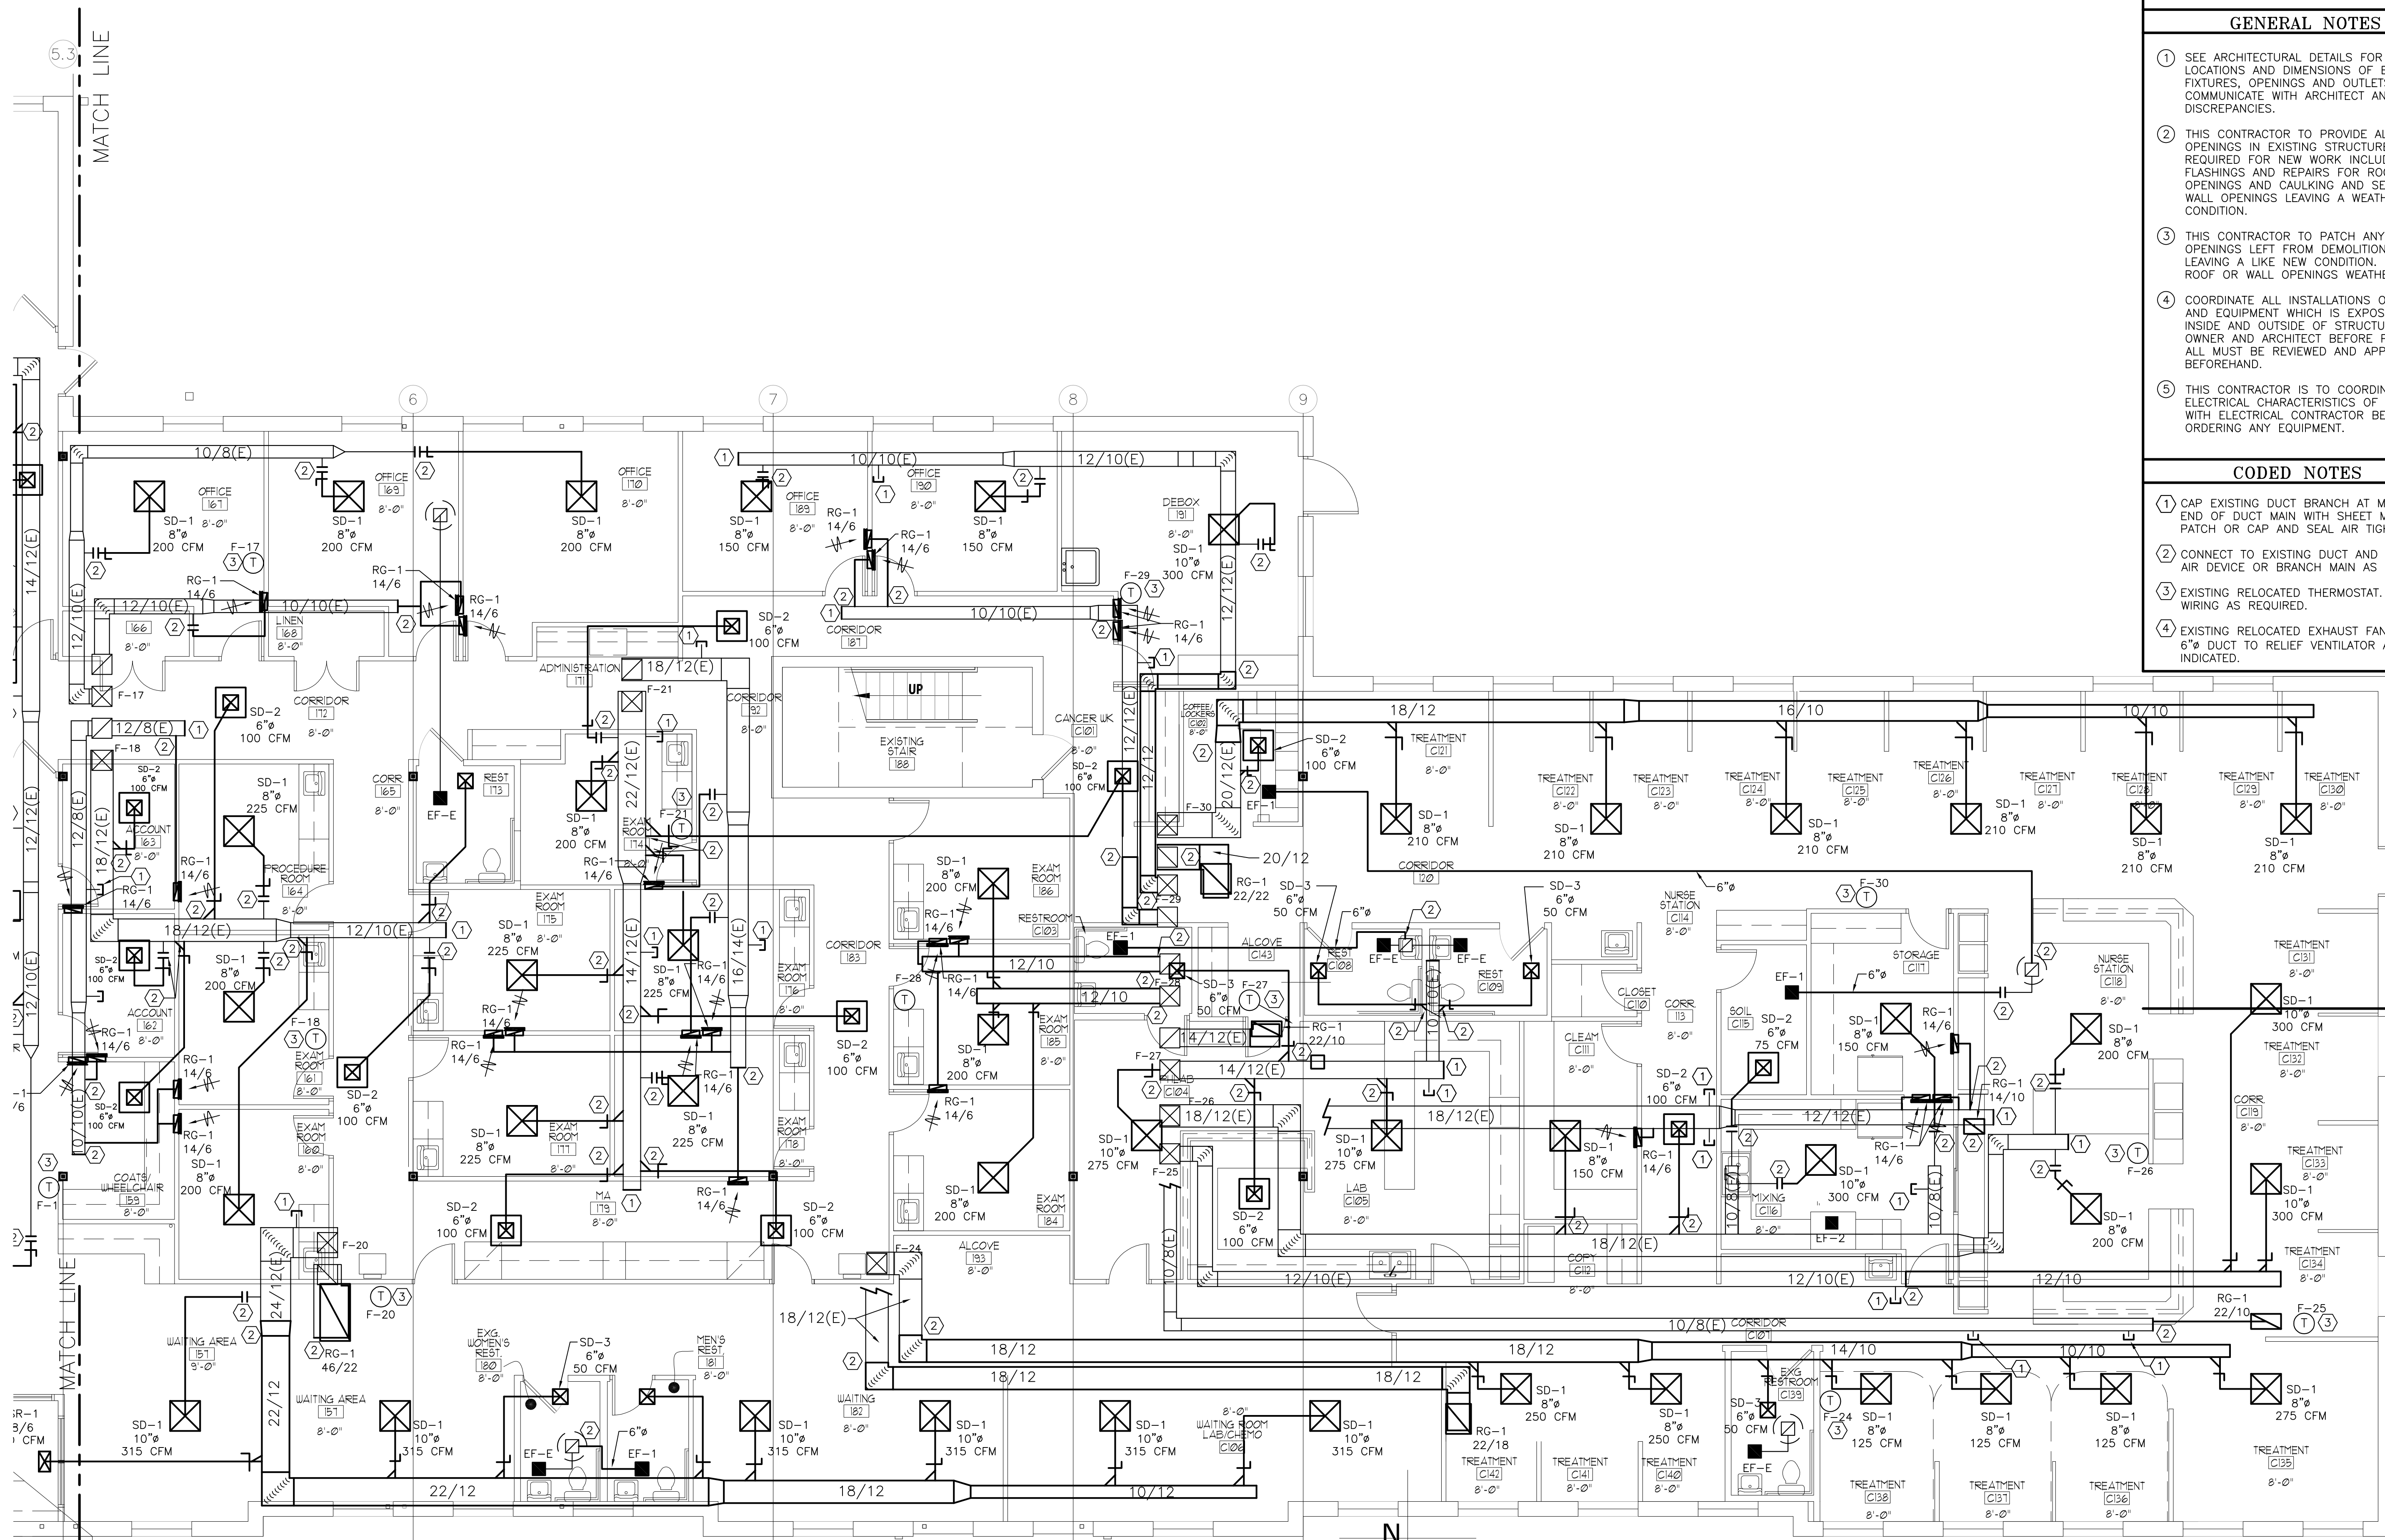


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- ② THIS CONTRACTOR TO PROVIDE ALL OPENINGS IN EXISTING STRUCTURE AS REQUIRED FOR NEW WORK INCLUDING FLASHINGS AND REPAIRS FOR ROOF OPENINGS AND CAULKING AND SEALING FOR WALL OPENINGS LEAVING A WEATHER-PROOF CONDITION.
- ③ THIS CONTRACTOR TO PATCH ANY UNUSED OPENINGS LEFT FROM DEMOLITION WORK LEAVING A LIKE NEW CONDITION. SEAL ANY ROOF OR WALL OPENINGS WEATHER-PROOF.
- ④ COORDINATE ALL INSTALLATIONS OF MATERIAL AND EQUIPMENT WHICH IS EXPOSED TO VIEW INSIDE AND OUTSIDE OF STRUCTURE WITH OWNER AND ARCHITECT BEFORE PURCHASE. ALL MUST BE REVIEWED AND APPROVED BEFOREHAND.
- ⑤ THIS CONTRACTOR IS TO COORDINATE ELECTRICAL CHARACTERISTICS OF EQUIPMENT WITH ELECTRICAL CONTRACTOR BEFORE ORDERING ANY EQUIPMENT.

**CODED NOTES**

- ① CAP EXISTING DUCT BRANCH AT MAIN OR END OF DUCT MAIN WITH SHEET METAL PATCH OR CAP AND SEAL AIR TIGHT.
- ② CONNECT TO EXISTING DUCT AND EXTEND TO AIR DEVICE OR BRANCH MAIN AS INDICATED.
- ③ EXISTING RELOCATED THERMOSTAT. EXTEND WIRING AS REQUIRED.
- ④ EXISTING RELOCATED EXHAUST FAN. EXTEND 6" DUCT TO RELIEF VENTILATOR AS INDICATED.

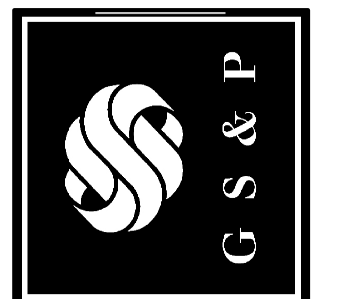


**PARTIAL FIRST FLOOR HVAC PLAN**

SCALE: 3/16" = 1' - 0"

revisions

3660 embassy parkway  
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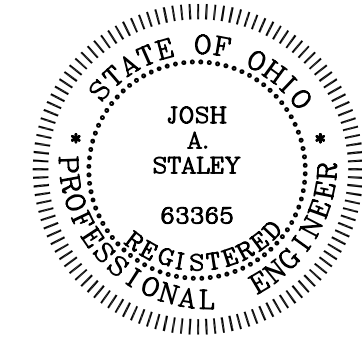
drawing  
 HVAC PLANS  
 project no. 11406  
 date OCTOBER 23, 2007  
 scale AS NOTED  
**COLUMBUS ONCOLOGY**  
 JASONIATY PROFESSIONAL BUILDING  
 810 JASONIATY AVENUE, SUITE A  
 COLUMBUS, OHIO 43214-2329  
 project

H.3  
 sheet no.





SMC  
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**GENERAL NOTES**


- ① SEE ARCHITECTURAL DETAILS FOR EXACT LOCATIONS AND DIMENSIONS OF EQUIPMENT, FIXTURES, OPENINGS AND OUTLETS. COMMUNICATE WITH ARCHITECT ANY DISCREPANCIES.
- ② PROVIDE EXISTING FLOOR, CEILING OR WALL CUTTING AND PATCHING TO MATCH EXISTING CONDITIONS FOR ANY PLUMBING WORK AS REQUIRED.
- ③ REMOVE EXISTING PIPING AS REQUIRED AND CAP BEHIND WALLS, ABOVE CEILING OR BELOW FLOOR AS CLOSE TO MAIN AS POSSIBLE. LEAVE NO PIPING EXPOSED IF NOT REUSED.

**CODED NOTES**

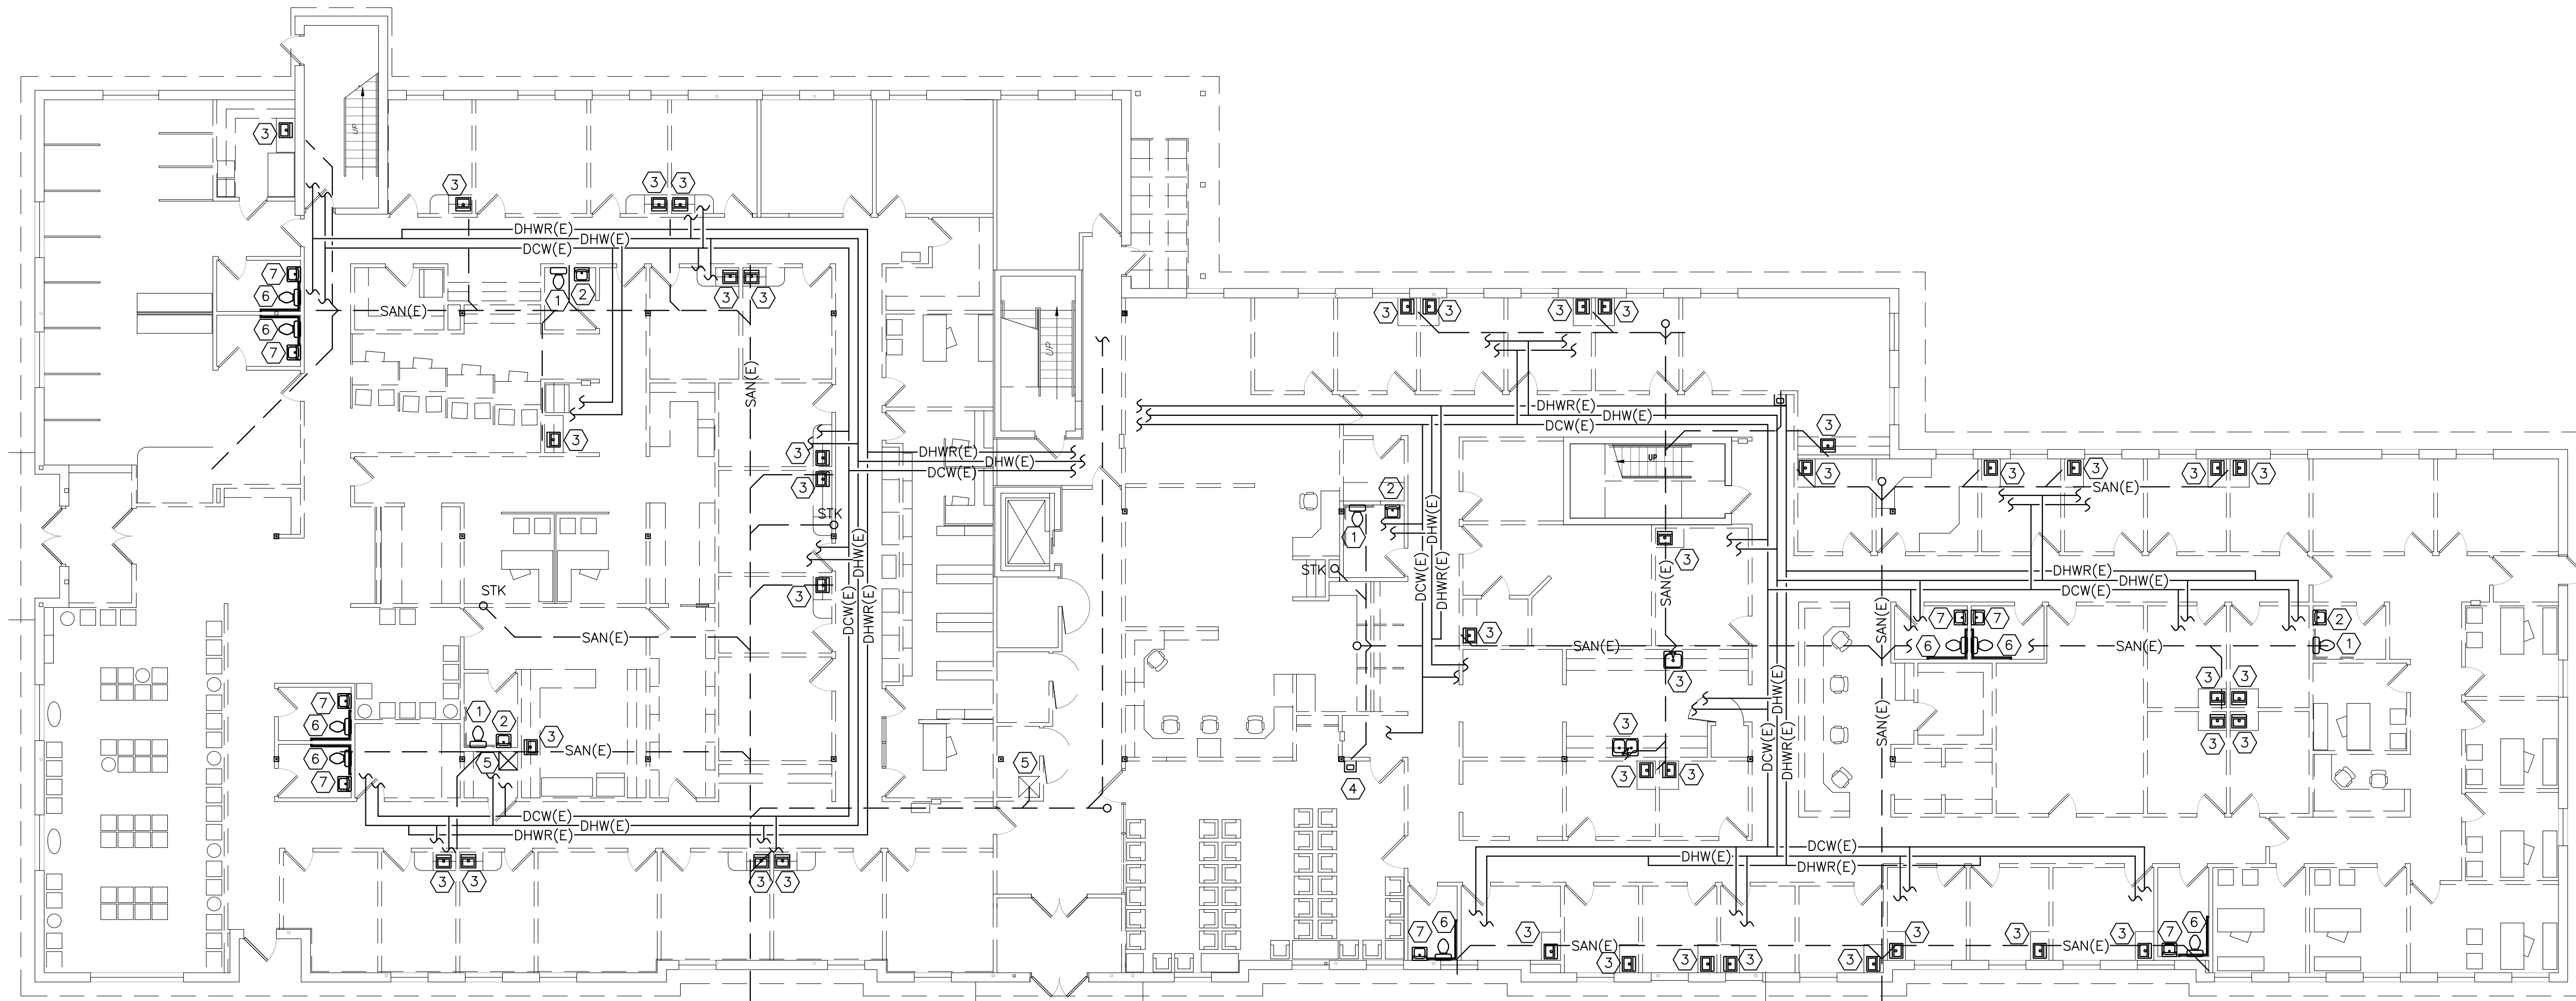- ① REMOVE EXISTING WATER CLOSET. CAP EXISTING WATER LINE AND SANITARY AT MAINS. PATCH FLOOR AND WALL TO MATCH EXISTING CONDITIONS. WATER CLOSET TO BE REUSED. REFER TO NEW PLAN FOR MORE INFORMATION.
- ② REMOVE EXISTING LAVATORY. CAP EXISTING WATER LINES AND SANITARY AT MAINS. PATCH FLOOR AND WALL TO MATCH EXISTING CONDITIONS. LAVATORY TO BE REUSED. REFER TO NEW PLAN FOR MORE INFORMATION.
- ③ REMOVE EXISTING SINK. CAP EXISTING WATER LINES AND SANITARY AT MAINS. PATCH FLOOR AND WALL TO MATCH EXISTING CONDITIONS. SINK TO BE REUSED. REFER TO NEW PLAN FOR MORE INFORMATION.
- ④ REMOVE ELECTRIC WATER COOLER. CAP EXISTING WATER LINES AND SANITARY AT MAINS. PATCH FLOOR AND WALL TO MATCH EXISTING CONDITIONS. SINK TO BE REUSED. REFER TO NEW PLAN FOR MORE INFORMATION.
- ⑤ REMOVE EXISTING MOP BASIN. CAP EXISTING WATER LINES AND SANITARY AT MAINS. PATCH FLOOR AND WALL TO MATCH EXISTING CONDITIONS. SINK TO BE REUSED. REFER TO NEW PLAN FOR MORE INFORMATION.
- ⑥ EXISTING WATER CLOSET TO REMAIN.
- ⑦ EXISTING LAVATORY TO REMAIN.
- ⑧ EXISTING SINK TO REMAIN.
- ⑨ EXISTING SHOWER TO REMAIN.
- ⑩ REMOVE EXISTING WATER CLOSET FOR PLACEMENT OF NEW ADA WATER CLOSET.


**PLUMBING SYMBOL LEGEND**

ABBREVIATION	SYMBOL	DESCRIPTION
SAN(E)	—SAN(E)—	EXISTING UNDERGROUND SANITARY
SAN	—SAN—	UNDERGROUND SANITARY
DCW(E)	—DCW(E)—	EXISTING DOMESTIC COLD WATER
DCW	—DCW—	DOMESTIC COLD WATER
DHW(E)	—DHW(E)—	EXISTING DOMESTIC HOT WATER
DHW	—DHW—	DOMESTIC HOT WATER
DHWR(E)	—DHWR(E)—	EXISTING DOMESTIC HOT WATER RETURN
DHWR	—DHWR—	DOMESTIC HOT WATER RETURN
WC(E)	WC—E	EXISTING WATER CLOSET
WC	WC—J	WATER CLOSET
LAV(E)	LAV—E	EXISTING LAVATORY
LAV	LAV—J	LAVATORY
SK(E)	SK—E	EXISTING SINK
SK	SK—J	SINK
MB	MB—J	MOP BASIN
EWC	EWC—J	BOTTLED WATER DISPENSER
CO(E)	CO—E	EXISTING CLEANOUT
CO	CO—J	CLEANOUT



**FIRST FLOOR PLUMBING DEMOLITION PLAN**

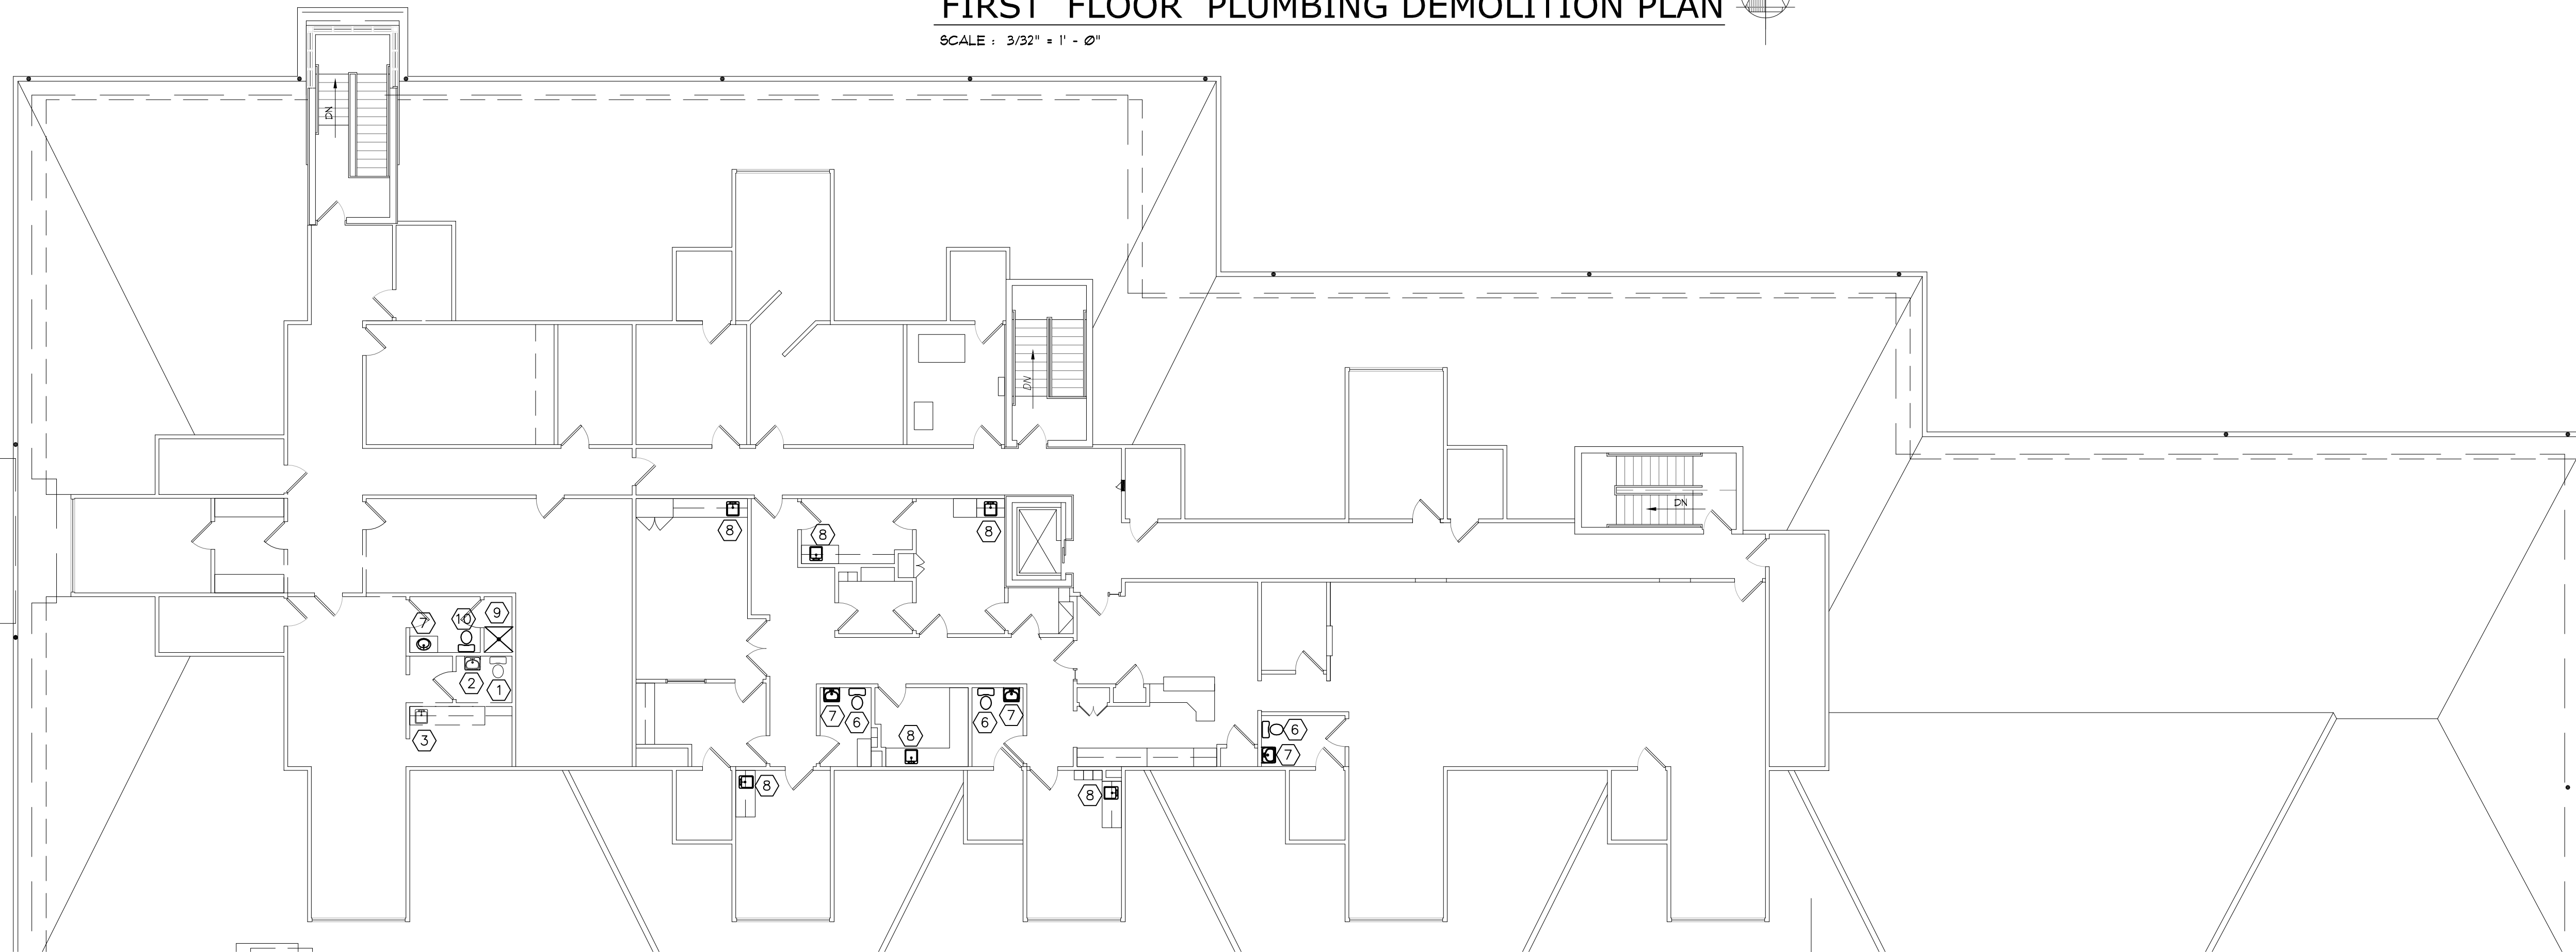SCALE : 3/32" = 1' - 0"





**SECOND FLOOR PLUMBING DEMOLITION PLAN**

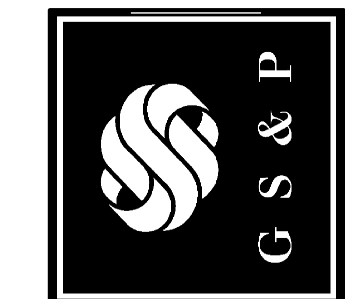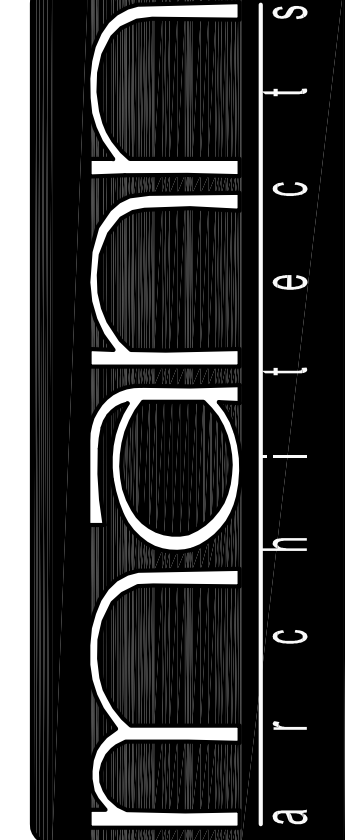SCALE : 3/32" = 1' - 0"

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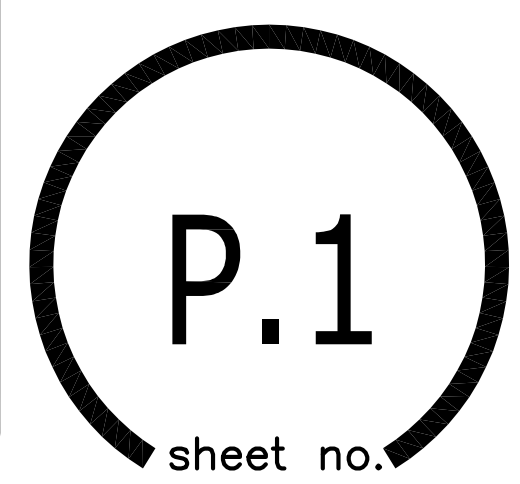



drawing

PLUMBING DEMOLITION PLAN scale  
 project no. 11406 date OCTOBER 23, 2007 AS NOTED

COLUMBUS ONCOLOGY  
 JAGONIAT PROFESSIONAL BUILDING  
 810 JAGONIAT AVENUE, SUITE A  
 COLUMBUS, OHIO 43214-2329

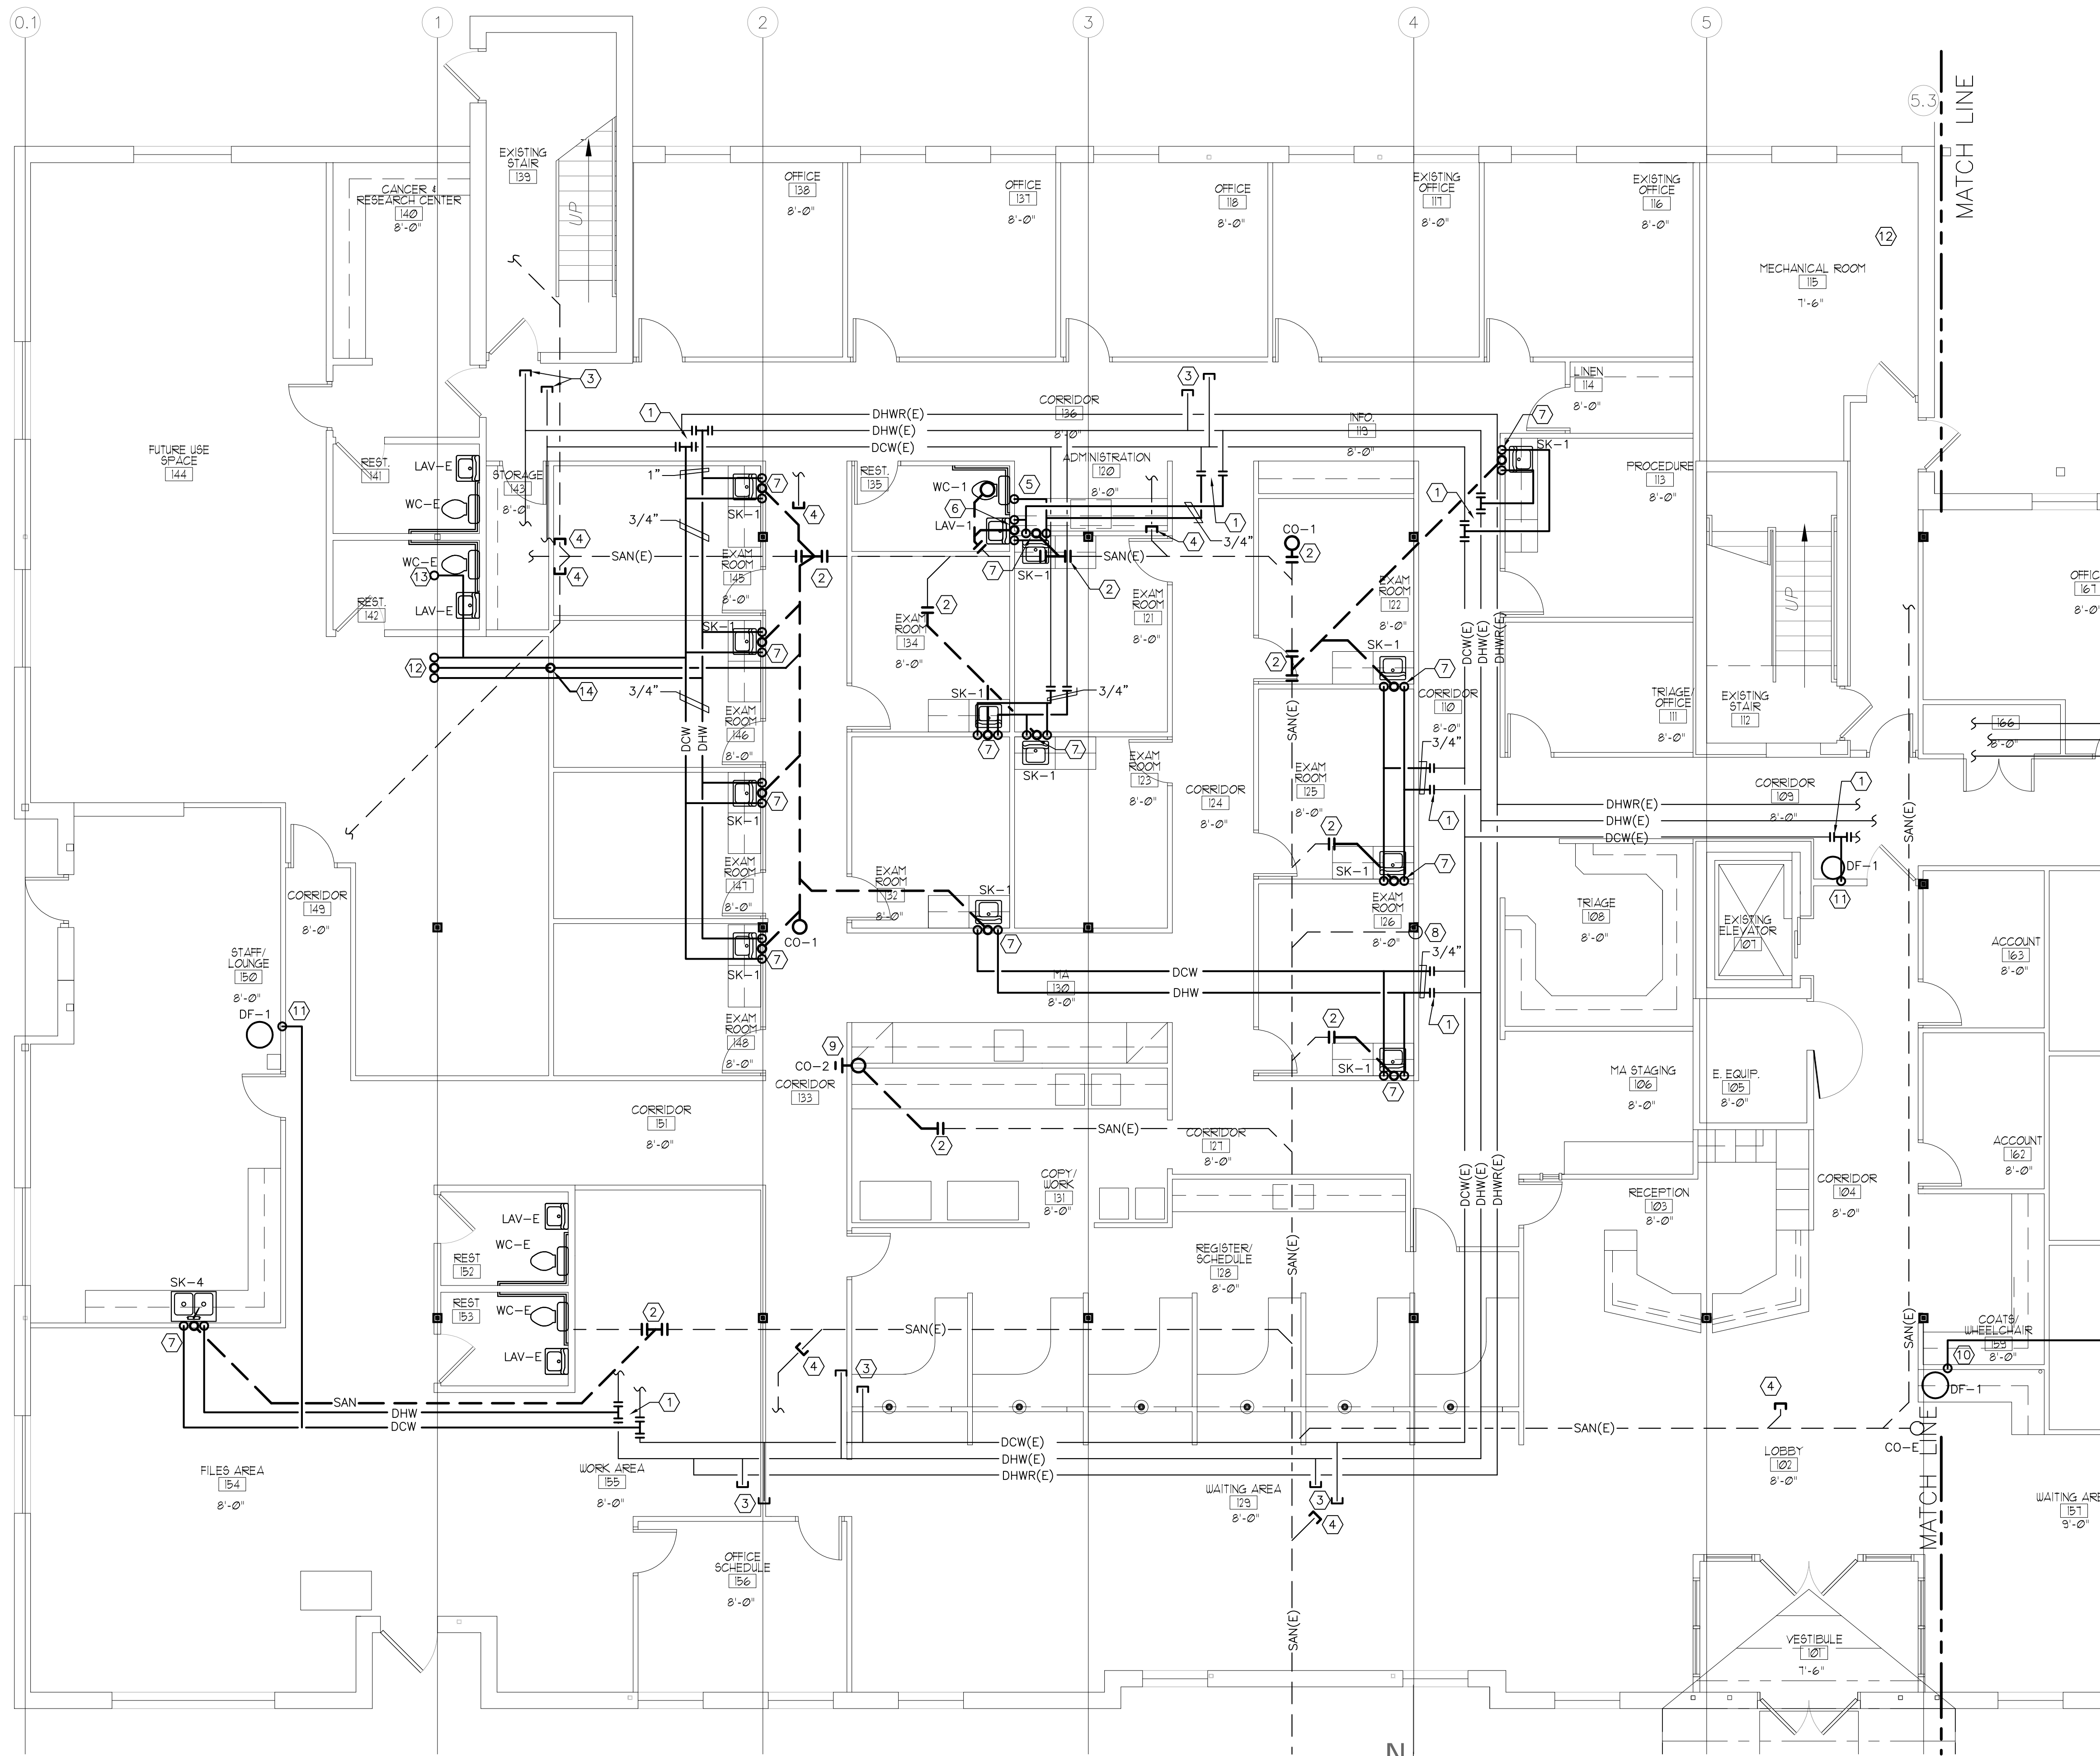project






**PARTIAL FIRST FLOOR PLUMBING PLAN**

SCALE: 3/16" = 1' - 0"

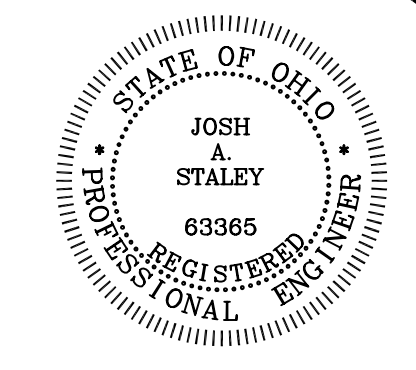**SMC**  
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 CONSULTING, INC.  
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 LOUISVILLE, OHIO 4601  
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**GENERAL NOTES**



- 1 SEE ARCHITECTURAL DETAILS FOR EXACT LOCATIONS AND DIMENSIONS OF EQUIPMENT, FIXTURES, OPENINGS AND OUTLETS. COMMUNICATE WITH ARCHITECT ANY DISCREPANCIES.
- 2 PROVIDE EXISTING FLOOR, CEILING OR WALL CUTTING AND PATCHING TO MATCH EXISTING CONDITIONS FOR ANY PLUMBING WORK AS REQUIRED.
- 3 REMOVE EXISTING PIPING AS REQUIRED AND CAP BEHIND WALLS, ABOVE CEILING OR BELOW FLOOR AS CLOSE TO MAIN AS POSSIBLE. LEAVE NO PIPING EXPOSED IF NOT REUSED.

**CODED NOTES**

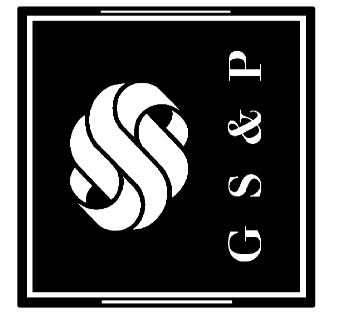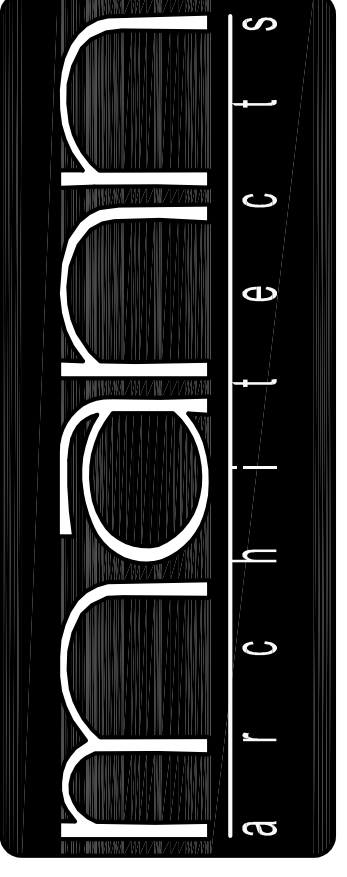- 1 CONNECT NEW DOMESTIC HOT AND COLD WATER LINES TO EXISTING AND EXTEND TO FIXTURE(S) AS INDICATED.
- 2 CONNECT NEW SANITARY TO EXISTING UNDERGROUND SANITARY AND EXTEND TO FIXTURE(S) AS INDICATED.
- 3 CAP EXISTING HOT AND COLD WATER LINES.
- 4 CAP EXISTING UNDERGROUND SANITARY LINE CLOSE TO MAIN. CUT AND PATCH FLOOR TO MATCH EXISTING CONDITIONS.
- 5 1/2" DCW DOWN TO WATER CLOSET.
- 6 1/2" DCW AND DHW DOWN TO LAVATORY.
- 7 1/2" DCW AND DHW DOWN TO SINK.
- 8 EXISTING 4" SANITARY STACK SERVING SECOND FLOOR FIXTURES.
- 9 REROUTE EXISTING 4" SANITARY STACK SERVING SECOND FLOOR FIXTURES, PROVIDE CLEANOUT AT BASE OF RISER.
- 10 1/2" DCW WITH SHUTOFF VALVE AND ATMOSPHERIC VENT BACKFLOW PREVENTER MEETING ASSE 1022 TO WATER COOLER AND COFFEE MAKER.
- 11 1/2" DCW WITH SHUTOFF VALVE AND DOUBLE CHECK BACKFLOW PREVENTER TO WATER COOLER.
- 12 PROVIDE SOLENOID VALVE WITH 24 HOUR 7 DAY TIME CLOCK TO SHUT OFF WATER SERVICE AFTER BUSINESS HOURS. INSTALL AFTER WATER METER AND BACKFLOW PREVENTER. INCLUDE ALL POWER AND CONTROL WIRING.
- 13 1/2" DCW, 1/2" DHW AND 1-1/2" SAN UP TO SINK ON SECOND FLOOR.
- 14 PROVIDE CLEANOUT AT BASE OF RISER.

revisions

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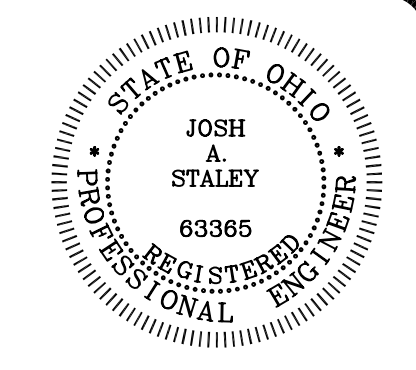


drawing PLUMBING PLAN scale AS NOTED  
 project no. 11406 date OCTOBER 23, 2007  
**COLUMBUS ONCOLOGY**  
 JASONIAT PROFESSIONAL BUILDING  
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sheet no. **P.2**

- 10 REROUTE EXISTING 4" SANITARY STACK SERVING SECOND FLOOR FIXTURES, PROVIDE CLEANOUT AT BASE OF RISER.
- 11 INSTALL OWNER FURNISHED EYE WASH ON COUNTER NEXT TO SINK. INCLUDE 1/2" DCW WITH SHUT OFF VALVE.
- 12 1/2" DCW WITH SHUTOFF VALVE AND DOUBLE CHECK BACKFLOW PREVENTER TO WATER COOLER.

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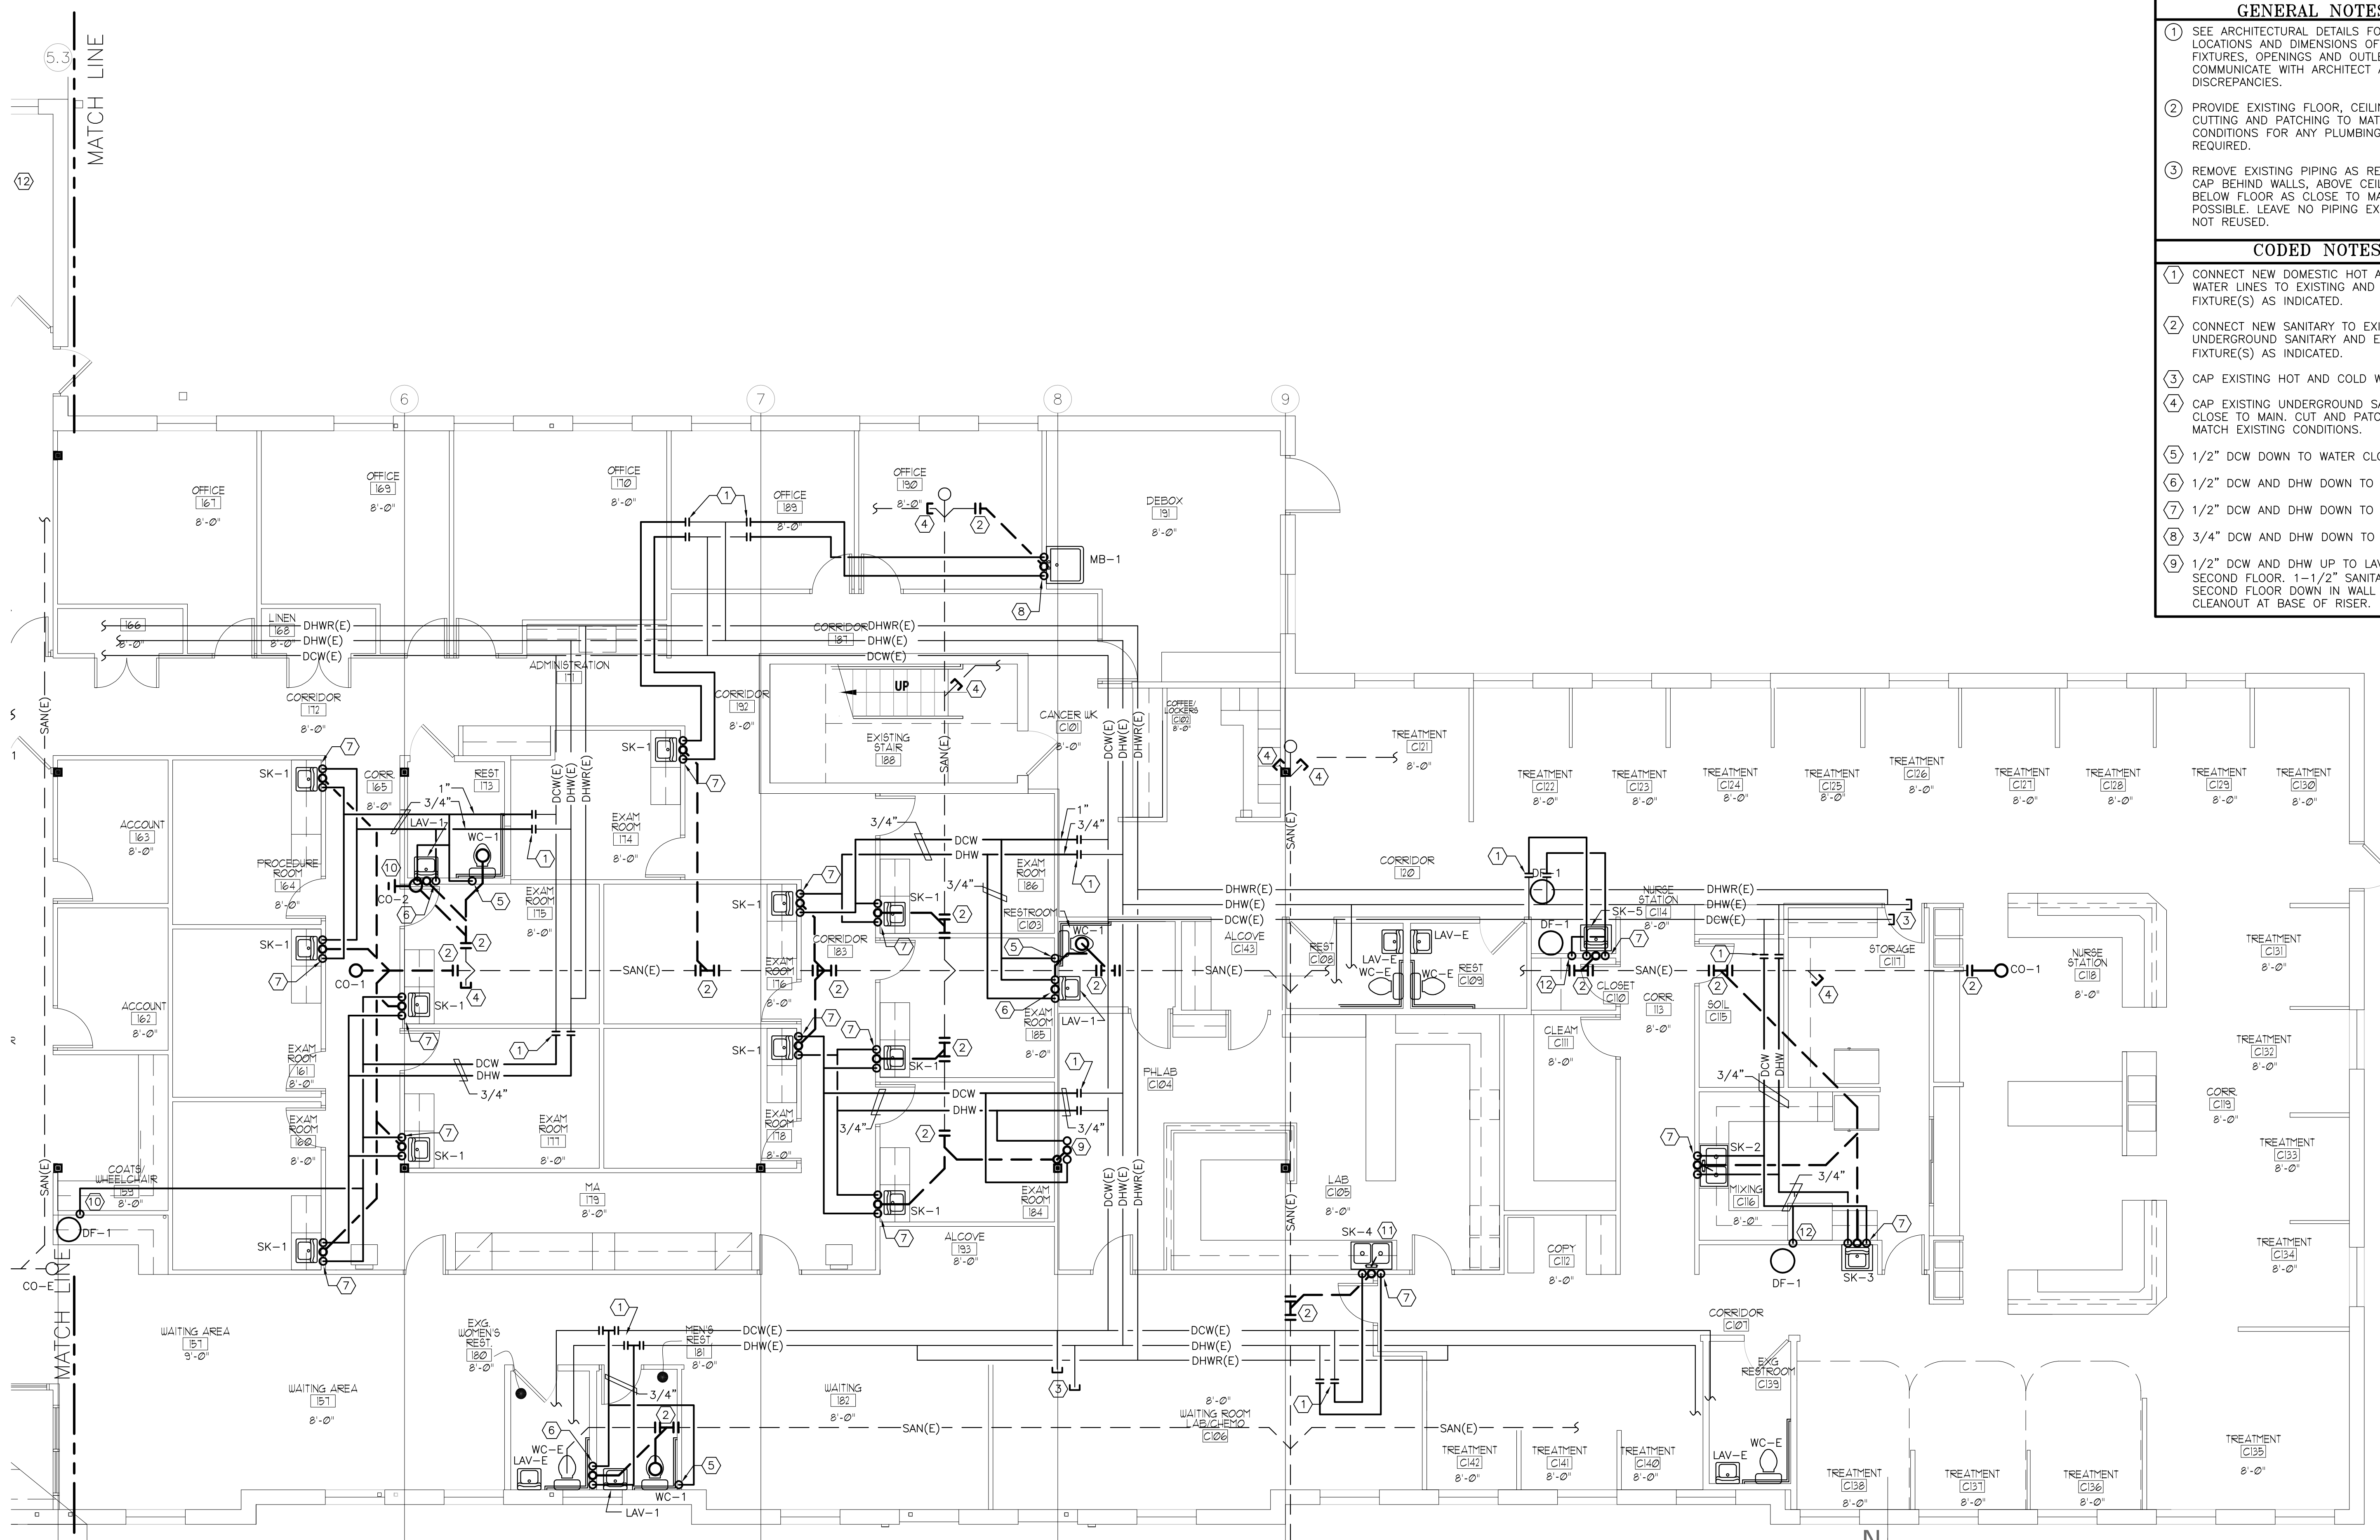


**GENERAL NOTES**

- 1 SEE ARCHITECTURAL DETAILS FOR EXACT LOCATIONS AND DIMENSIONS OF EQUIPMENT, FIXTURES, OPENINGS AND OUTLETS. COMMUNICATE WITH ARCHITECT ANY DISCREPANCIES.
- 2 PROVIDE EXISTING FLOOR, CEILING OR WALL CUTTING AND PATCHING TO MATCH EXISTING CONDITIONS FOR ANY PLUMBING WORK AS REQUIRED.
- 3 REMOVE EXISTING PIPING AS REQUIRED AND CAP BEHIND WALLS, ABOVE CEILING OR BELOW FLOOR AS CLOSE TO MAIN AS POSSIBLE. LEAVE NO PIPING EXPOSED IF NOT REUSED.

**CODED NOTES**

- 1 CONNECT NEW DOMESTIC HOT AND COLD WATER LINES TO EXISTING AND EXTEND TO FIXTURE(S) AS INDICATED.
- 2 CONNECT NEW SANITARY TO EXISTING UNDERGROUND SANITARY AND EXTEND TO FIXTURE(S) AS INDICATED.
- 3 CAP EXISTING HOT AND COLD WATER LINES.
- 4 CAP EXISTING UNDERGROUND SANITARY LINE CLOSE TO MAIN. CUT AND PATCH FLOOR TO MATCH EXISTING CONDITIONS.
- 5 1/2" DCW DOWN TO WATER CLOSET.
- 6 1/2" DCW AND DHW DOWN TO LAVATORY.
- 7 1/2" DCW AND DHW DOWN TO SINK.
- 8 3/4" DCW AND DHW DOWN TO MOP BASIN.
- 9 1/2" DCW AND DHW UP TO LAVATORY ON SECOND FLOOR. 1-1/2" SANITARY FROM SECOND FLOOR DOWN IN WALL WITH CLEANOUT AT BASE OF RISER.

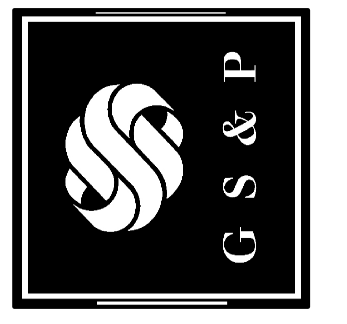
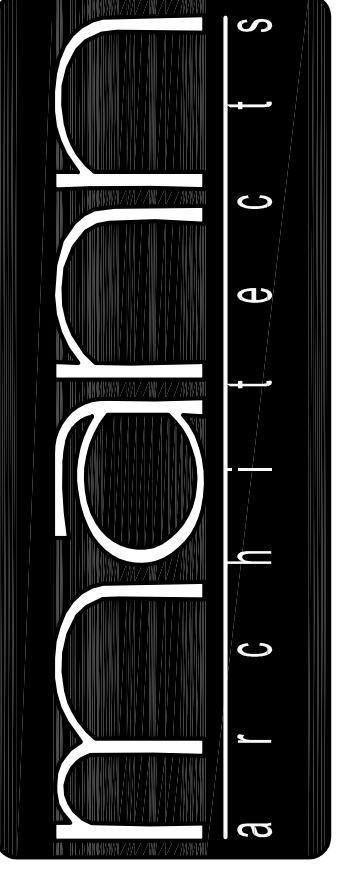


**PARTIAL FIRST FLOOR PLUMBING PLAN**

SCALE: 3/16" = 1' - 0"

revisions

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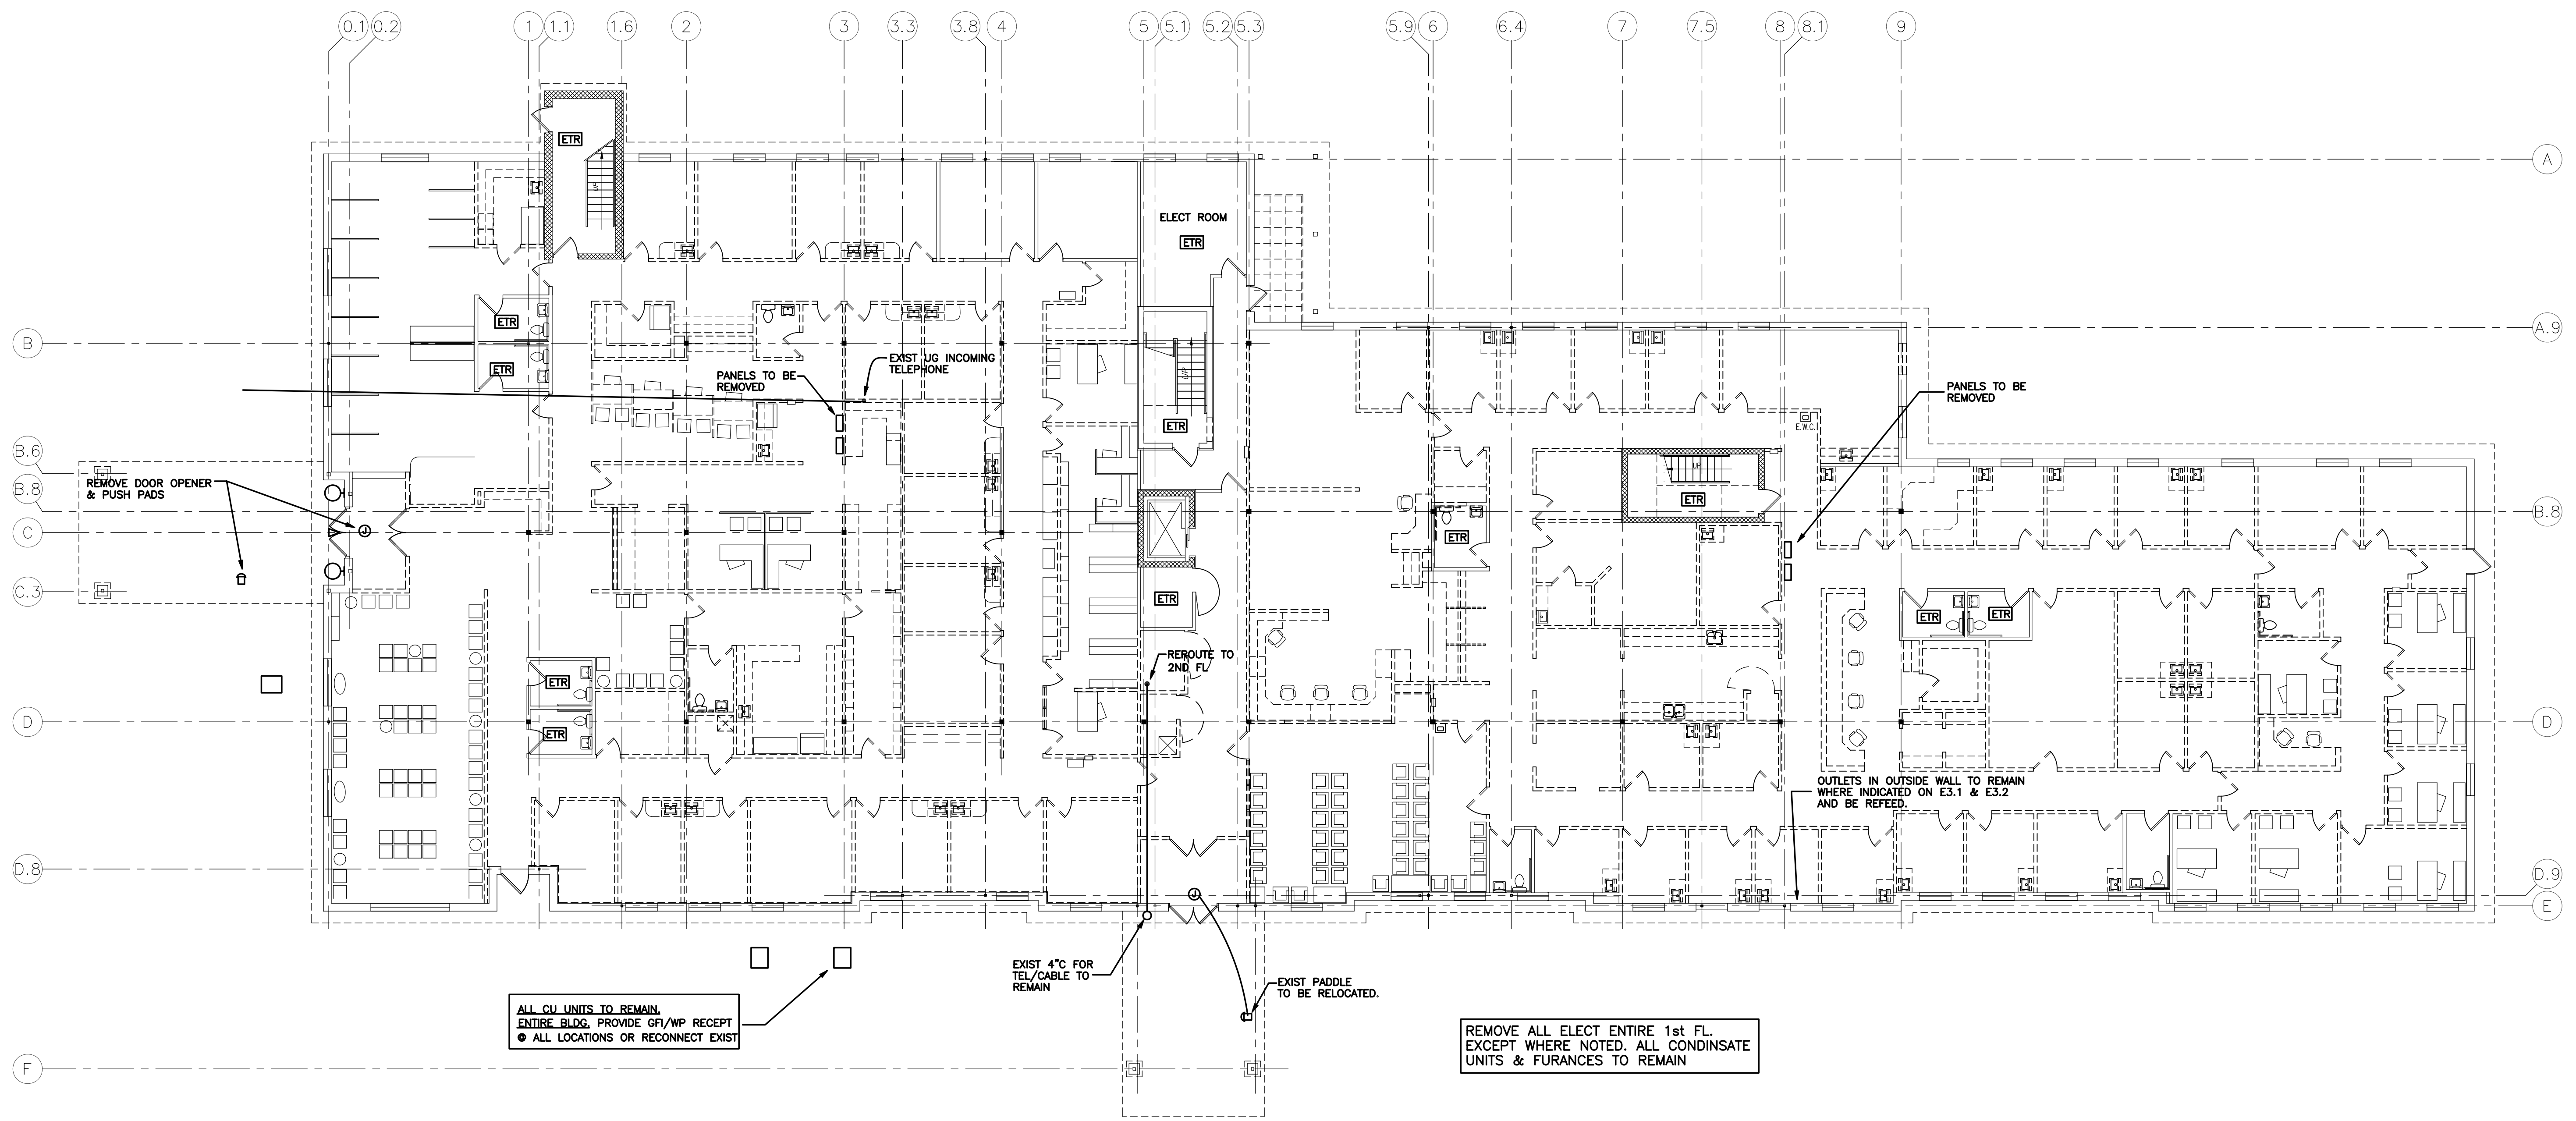
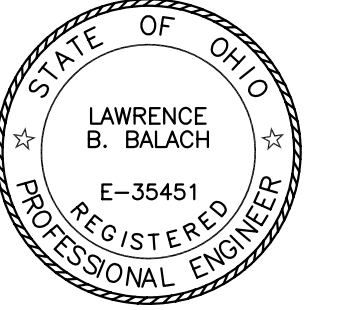


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**PLUMBING PLAN**  
 project no. 11406  
 date OCTOBER 23, 2007  
 scale AS NOTED  
**COLUMBUS ONCOLOGY**  
 JASONIAT PROFESSIONAL BUILDING  
 810 JASONIAT AVENUE, SUITE A  
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P.3

sheet no.





GENERAL DEMOLITION NOTES

- A. AREAS OR ITEMS HAVE BEEN INDICATED IN WHICH EXISTING ELECTRICAL EQUIPMENT IS TO BE REMOVED. THIS CONTRACTOR SHALL FIELD VERIFY THE EXTENT OF DEMOLITION BEFORE SUBMITTING HIS BID.
- B. REMOVE AND/OR RELOCATE EXISTING ELECTRICAL ON WALLS OR CEILING BEING REMOVED.
- C. EXISTING CONDUITS, CIRCUITS AND SYSTEMS PASSING THROUGH THE REMODELED AREAS, WHICH SERVE SURROUNDING AREAS, SHALL REMAIN AND BE PROTECTED DURING DEMOLITION AND REMODELING. (RELOCATE OR REROUTE AS REQUIRED)
- D. EXISTING CIRCUITS OR SYSTEMS IN WALLS OR CEILINGS BEING REMOVED, WHICH SERVE SURROUNDING UNREMODELED AREAS, SHALL BE REWORKED AND MAINTAINED.
- E. IT SHALL BE E.C. RESPONSIBILITY TO PATCH OVER AND FINISH ANY EXISTING UNUSED JBOXES OR OUTLET BOXES. BLANK COVERS ARE NOT ACCEPTABLE.

FIRST FLOOR DEMO PLAN

SCALE: 3/32"=1'-0"

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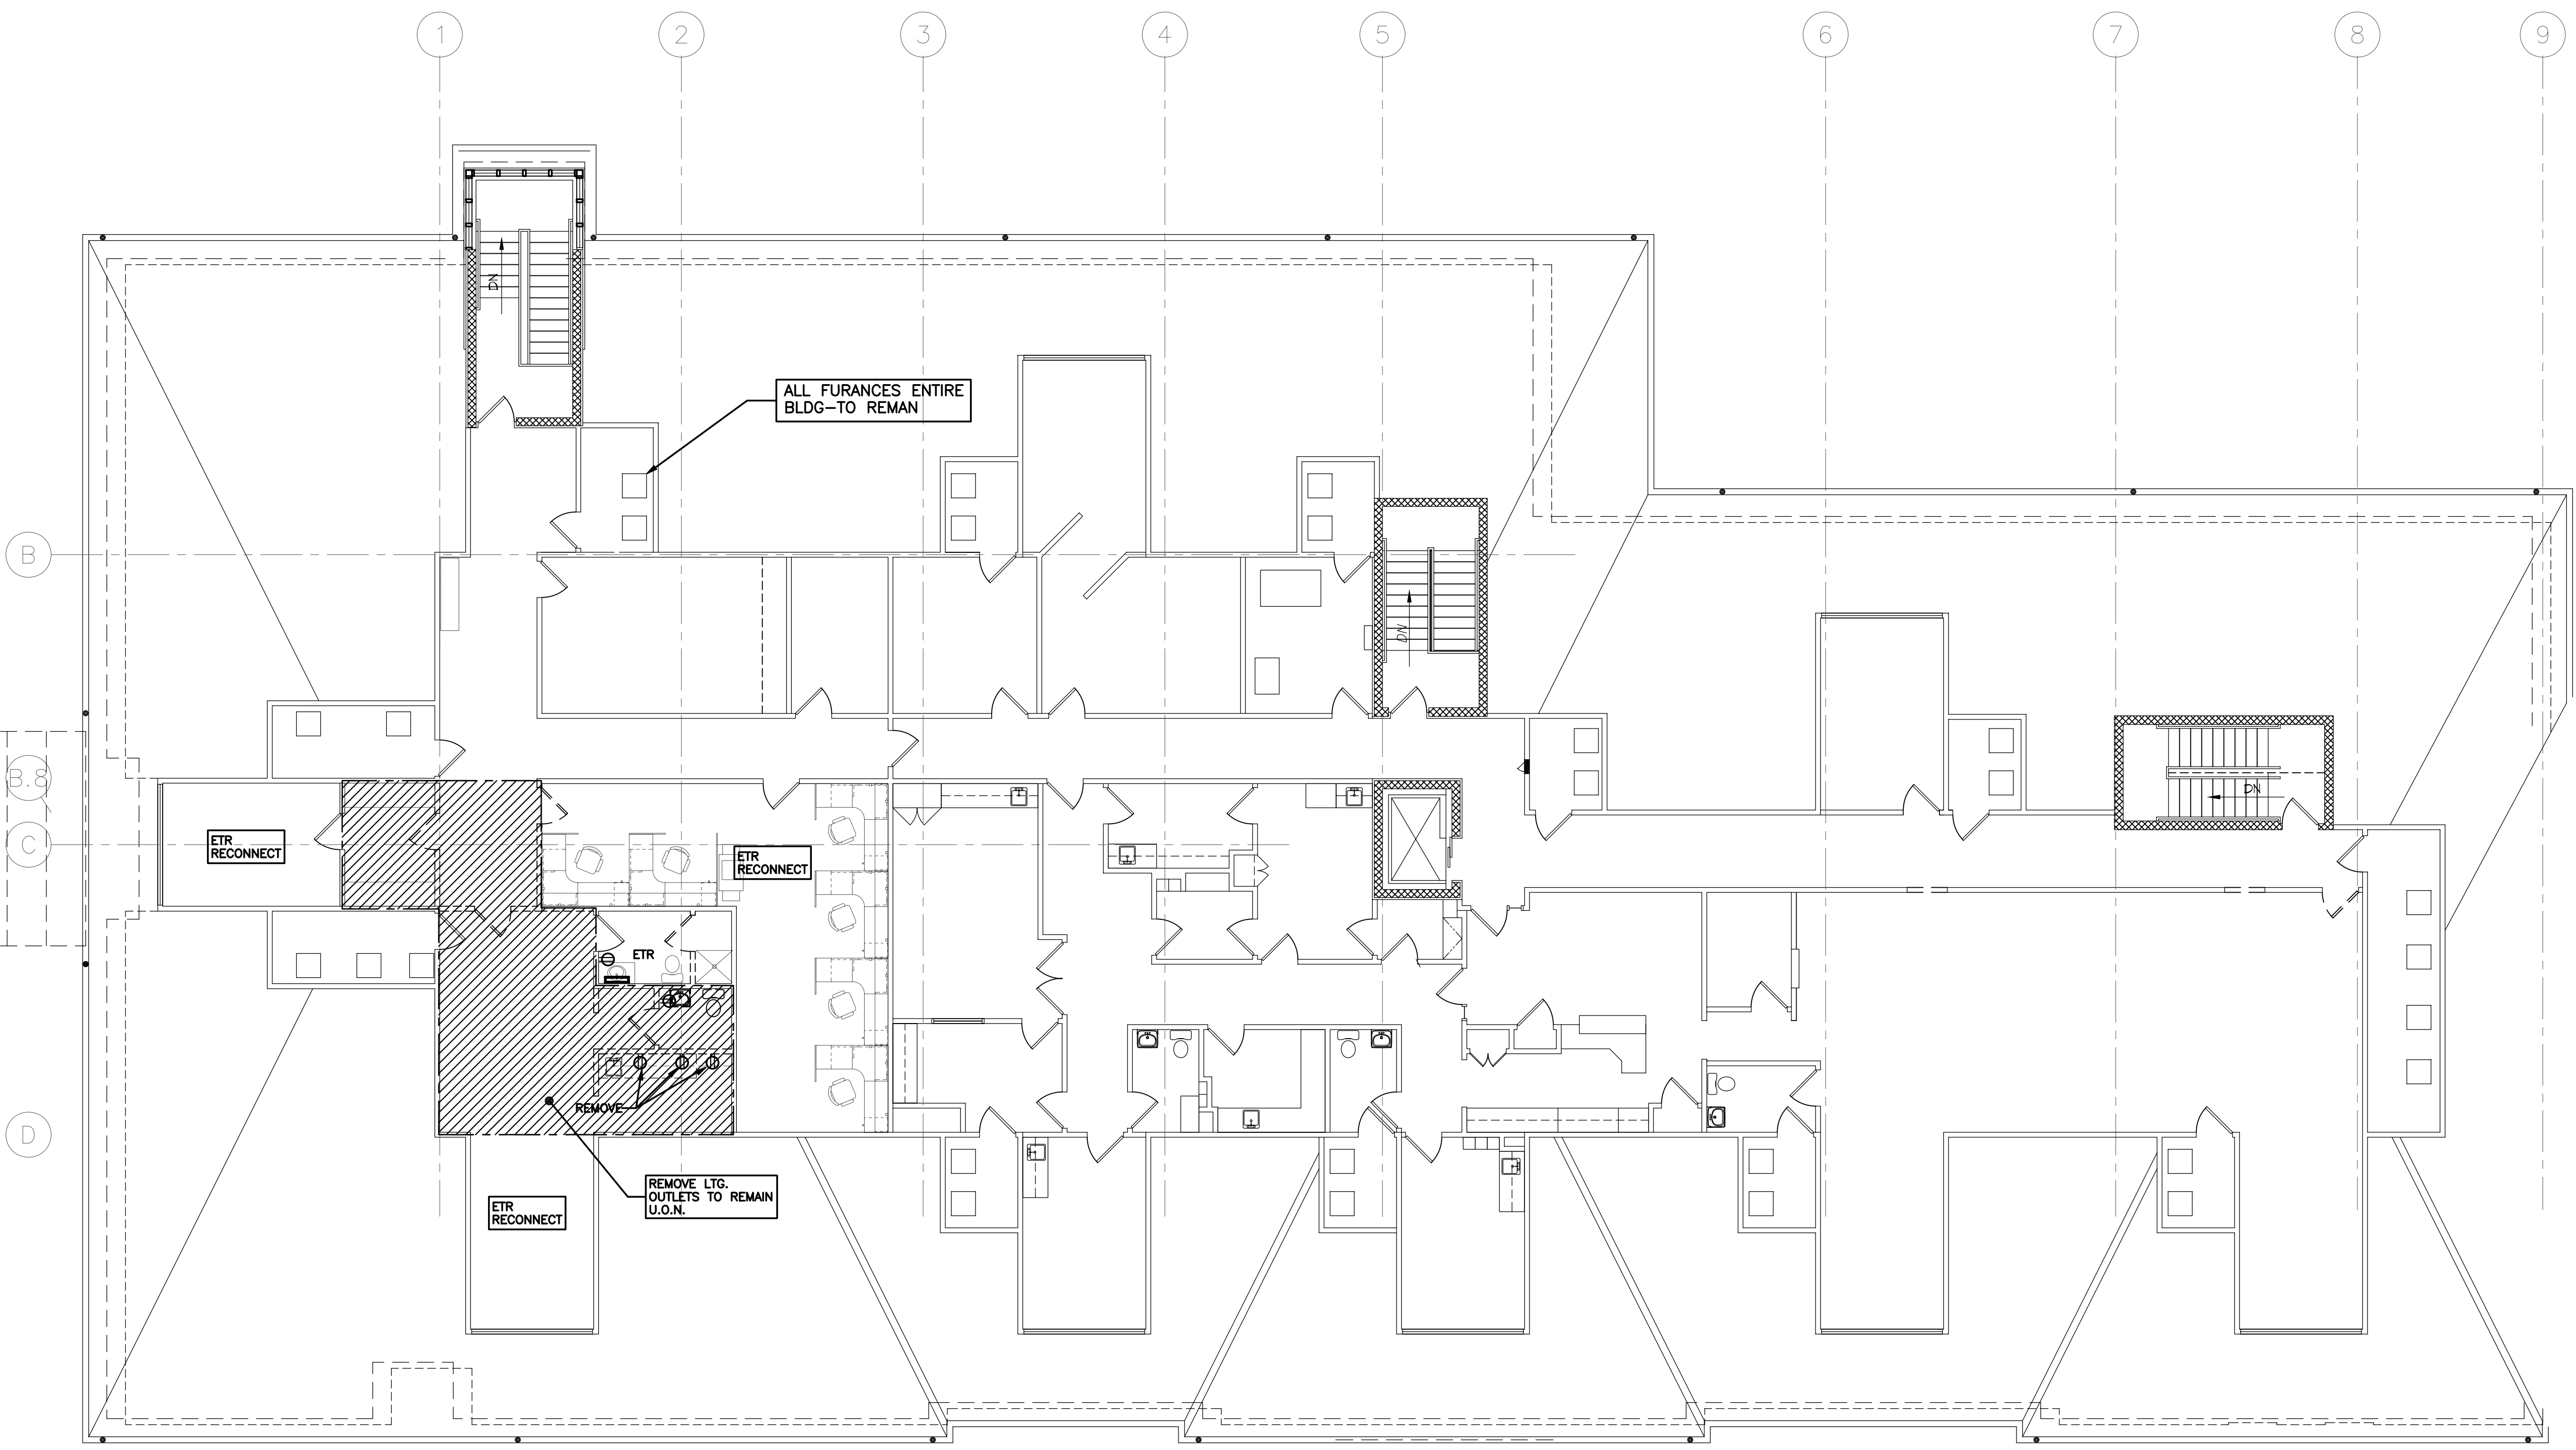


drawing  
FIRST FLOOR DEMO PLAN  
project no. 11406  
date OCTOBER 23, 2007  
scale AS NOTED

project  
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COLUMBUS, OHIO 43214-2329

E1.1  
sheet no.

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ALL FURANCES ENTIRE BLDG - TO REMAN

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REMOVE LTG. OUTLETS TO REMAIN U.O.M.


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**SECOND FLOOR DEMO PLAN**  
SCALE: 1/8"=1'-0"



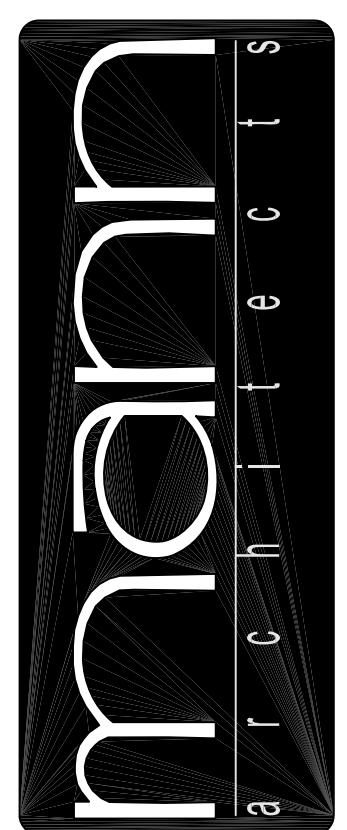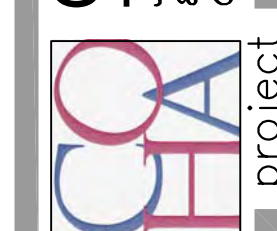
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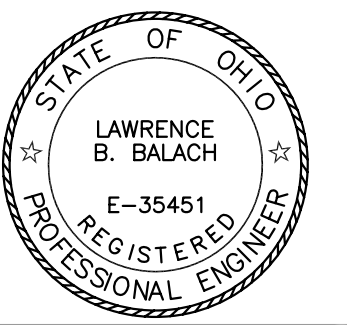


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**SECOND FLOOR DEMO PLAN**  
project no. 11406  
date OCTOBER 23, 2007  
scale AS NOTED

**COLUMBUS ONCOLOGY**  
JASONIAT PROFESSIONAL BUILDING  
910 JASONIAT AVENUE SUITE A  
COLUMBUS, OHIO 43214-2329




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sheet no.



LIGHTING FIXTURE SCHEDULE				
TYPE	WATTAGE		DESCRIPTION	CATALOG NUMBER
	LAMP	FIXTURE		
A	3-32W	T-8	FLUOR, 2x4, RECESSED, INDIRECT, PERF BASKET	COLUMBIA STR24-332G-MPO-E-120
A2	3-32W	T-8	FLUOR, 2x4, RECESSED, INDIRECT, PERF BASKET, 2 BALLASTS	COLUMBIA STR24-332G-MPO-2E-120
B	4-32W		FLUOR, 2x4, RECESSED, PRISMATIC	COLUMBIA JTB-24-432-G-FS-A12-E120
C	3-32W		FLUOR, 2x4, RECESSED, PRISMATIC	COLUMBIA JTB-24-332-G-FS-A12-E120
D	2-32W		FLUOR, 1x4, SURFACE WRAP	COLUMBIA AWN-232-E-120
F	42W		COMPACT FLUOR, RECESSED, HORIZONTAL LAMP	PRESCOLITE LF6CFH132EB-WB
F2	26W		COMPACT FLUOR, RECESSED, HORIZONTAL LAMP	PRESCOLITE LF6CFH132EB-WB
G	70W		METAL HALIDE FLOOD	HUBBELL MIC-0070H-358
H	2-40W	BIAX	FLUOR, 2x2, RECESSED INDIRECT, PERF BASKET	COLUMBIA STR-22-240TT-G-MPO-E-120
K	60w	MINI	PENDANT, 120V MONOPT	TECH LTG 700-R-W-MONOPT
M			FLUOR, WALL	PROGRESS P7114-60EB
N	32W		COMPACT FLUOR, RECESSED	PRESCOLITE LF6CFH132EB-WB
P	150W		METAL HALIDE, RECESSED, U.L DAMP. (CANOPY)	PRESCOLITE LF6MH-BMHU
P2	70W		METAL HALIDE, RECESSED, U.L DAMP. (CANOPY)	PRESCOLITE LF6MH-6MHU
R	3-40TT		FLUOR, 2x2, DIRECT/INDIRECT, PERF BASKET, 2 BALLASTS	COLUMBIA STR22-340TT-G-MPO-(2)EP-120
Q	70W		MEATAL HALIDE, WALL FIXT	DEVINE BWD15-70MH-120-DBZ
EA			EXIT SIGN W/ BATTERY	DUALILITE LXURWE
EB			BATTERY LIGHT	DUALILITE CV2
EC			BATTERY LT, 2 INTEGRAL HEADS & 2 REMOTE HEADS	DUALILITE CV5-OWSDB

revisions

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drawing LIGHTING PLAN - WEST


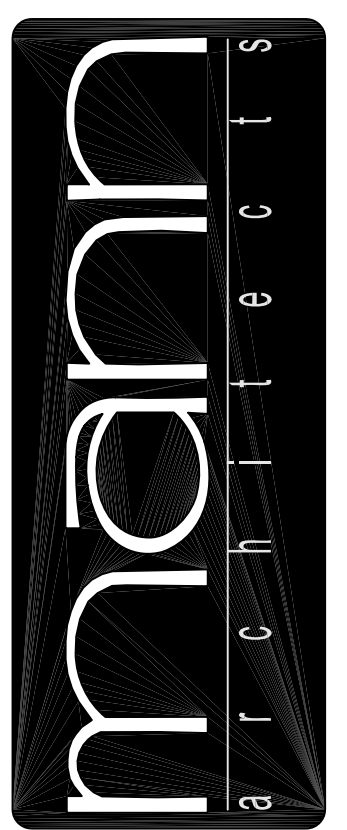
project no. 11406 date OCTOBER 23, 2007 scale AS NOTED

COLUMBUS ONCOLOGY

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810 JASONIAT AVENUE, SUITE A  
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sheet no.




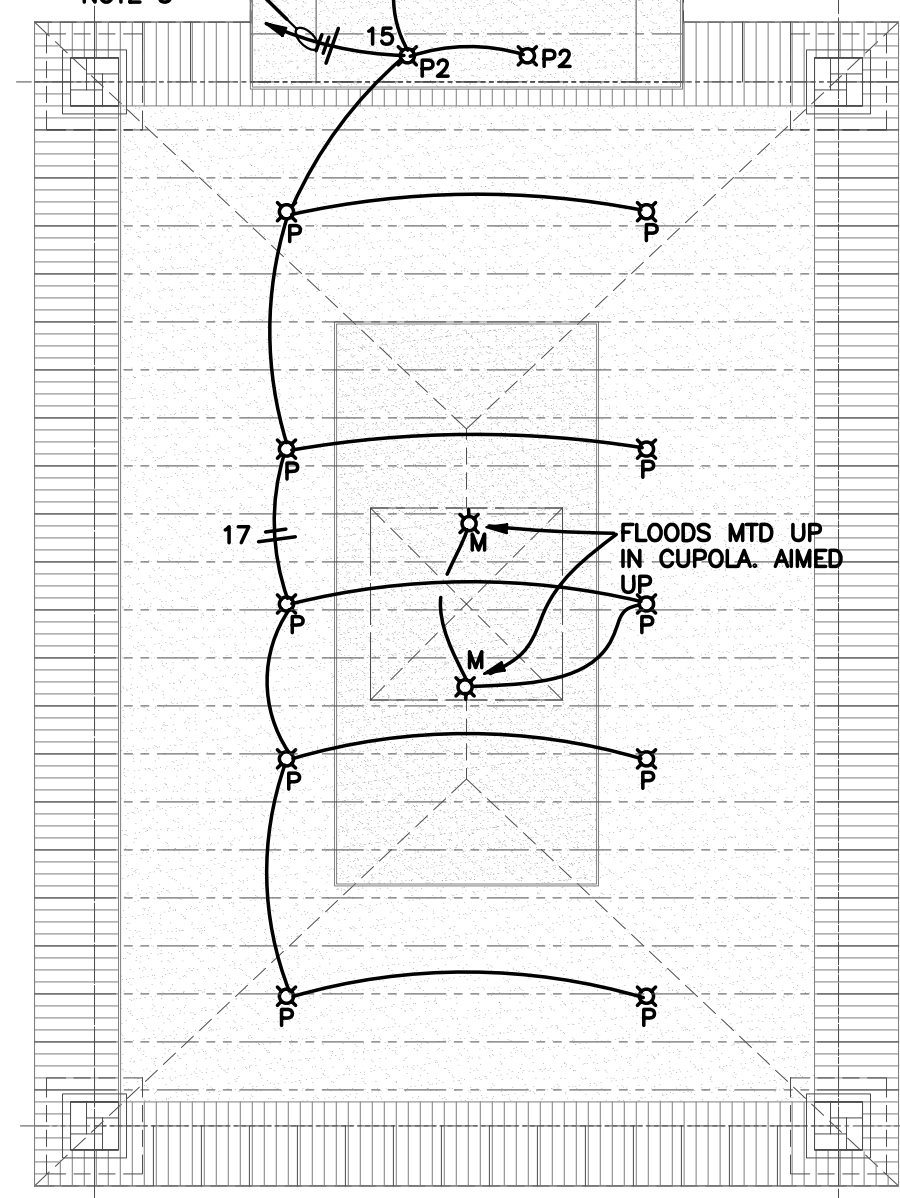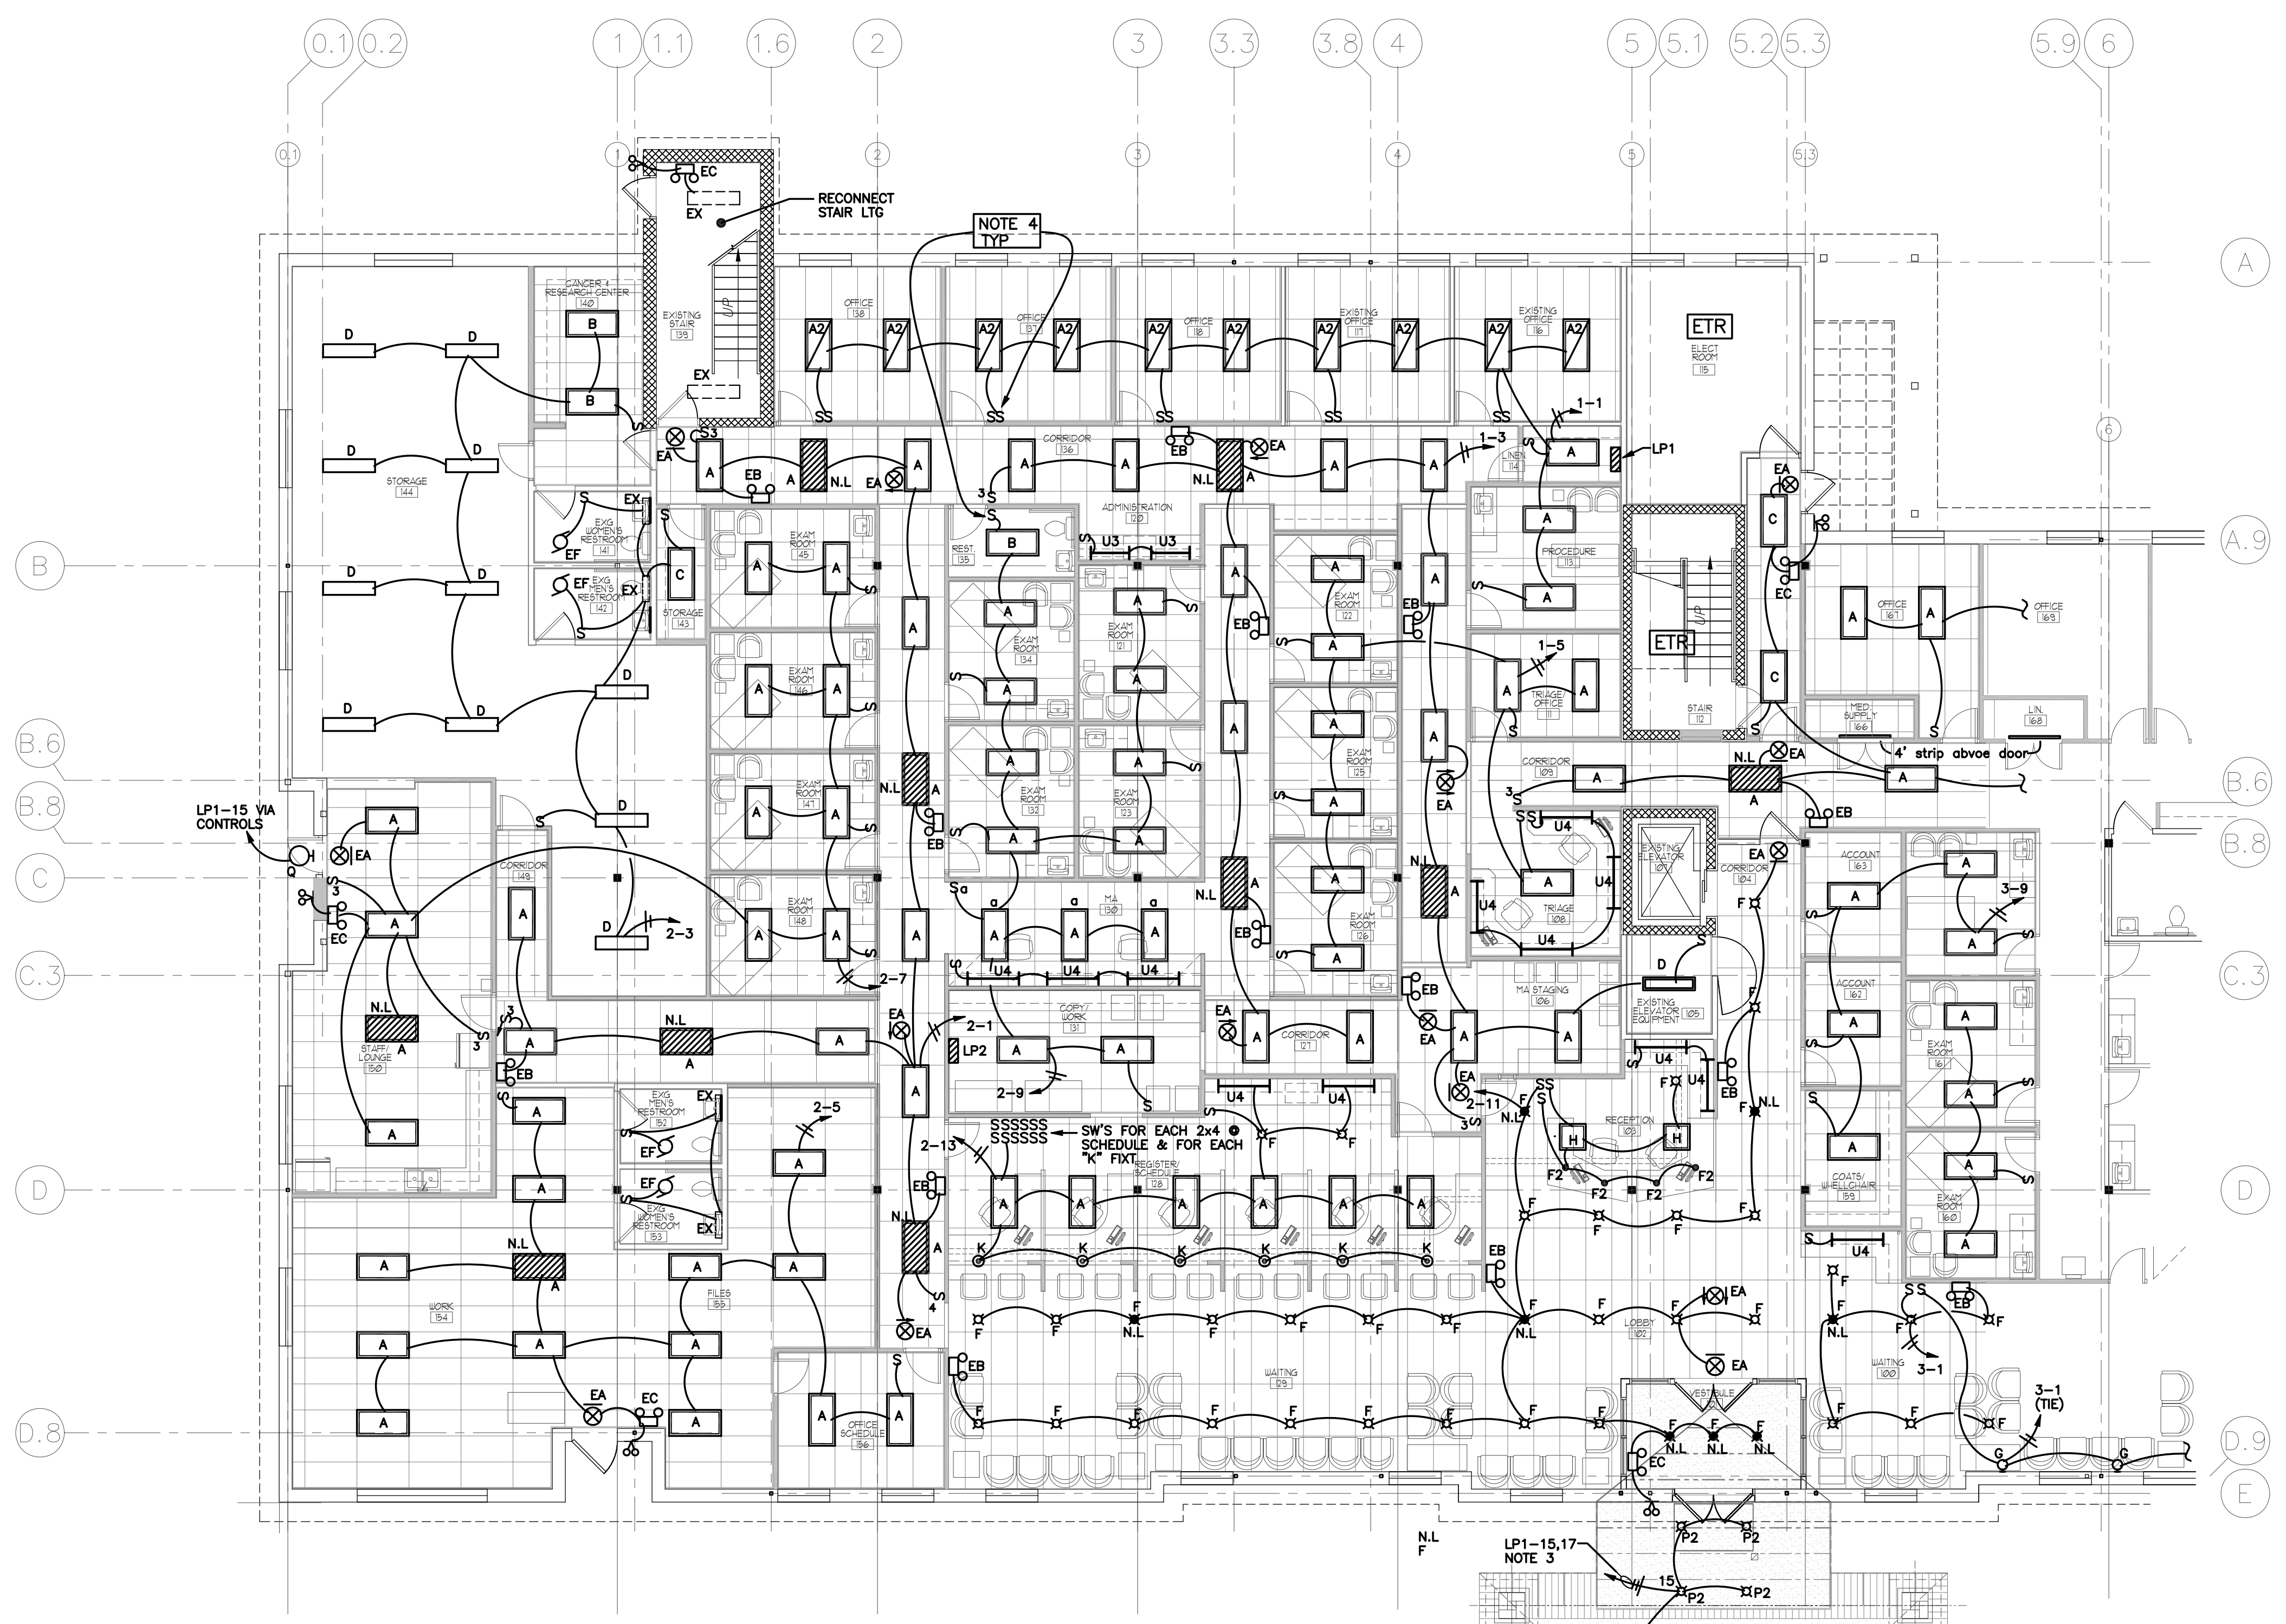LIGHTING PLAN - WEST  
SCALE: 1/8"=1'-0"

- NOTES
- NIGHT LTS, EXITS & EMERG LTS SHALL BE CONNECTED AHEAD OF SWITCHES
  - CONNECT U.C LTG TO RECEPT CKT.
  - PROVIDE NEW PHOTOCELL FOR ALL EXTERIOR LTG. PROVIDE NEW 4P CONTACTOR, PHOTOCELL ON \* DUSK. TIMELOCK (EXIST) OFF @ 11:00PM (VERIFY)
  - ALL EXAM ROOMS, OFFICES, TOILETS, WORK ROOMS SHALL HAVE A WALL SWITCH OCCUPANCY SENSOR W/ OVER RIDE. PROVIDE POWER PACKS AS REQ'D. SIMILAR TO WATT STOPPER WS-200

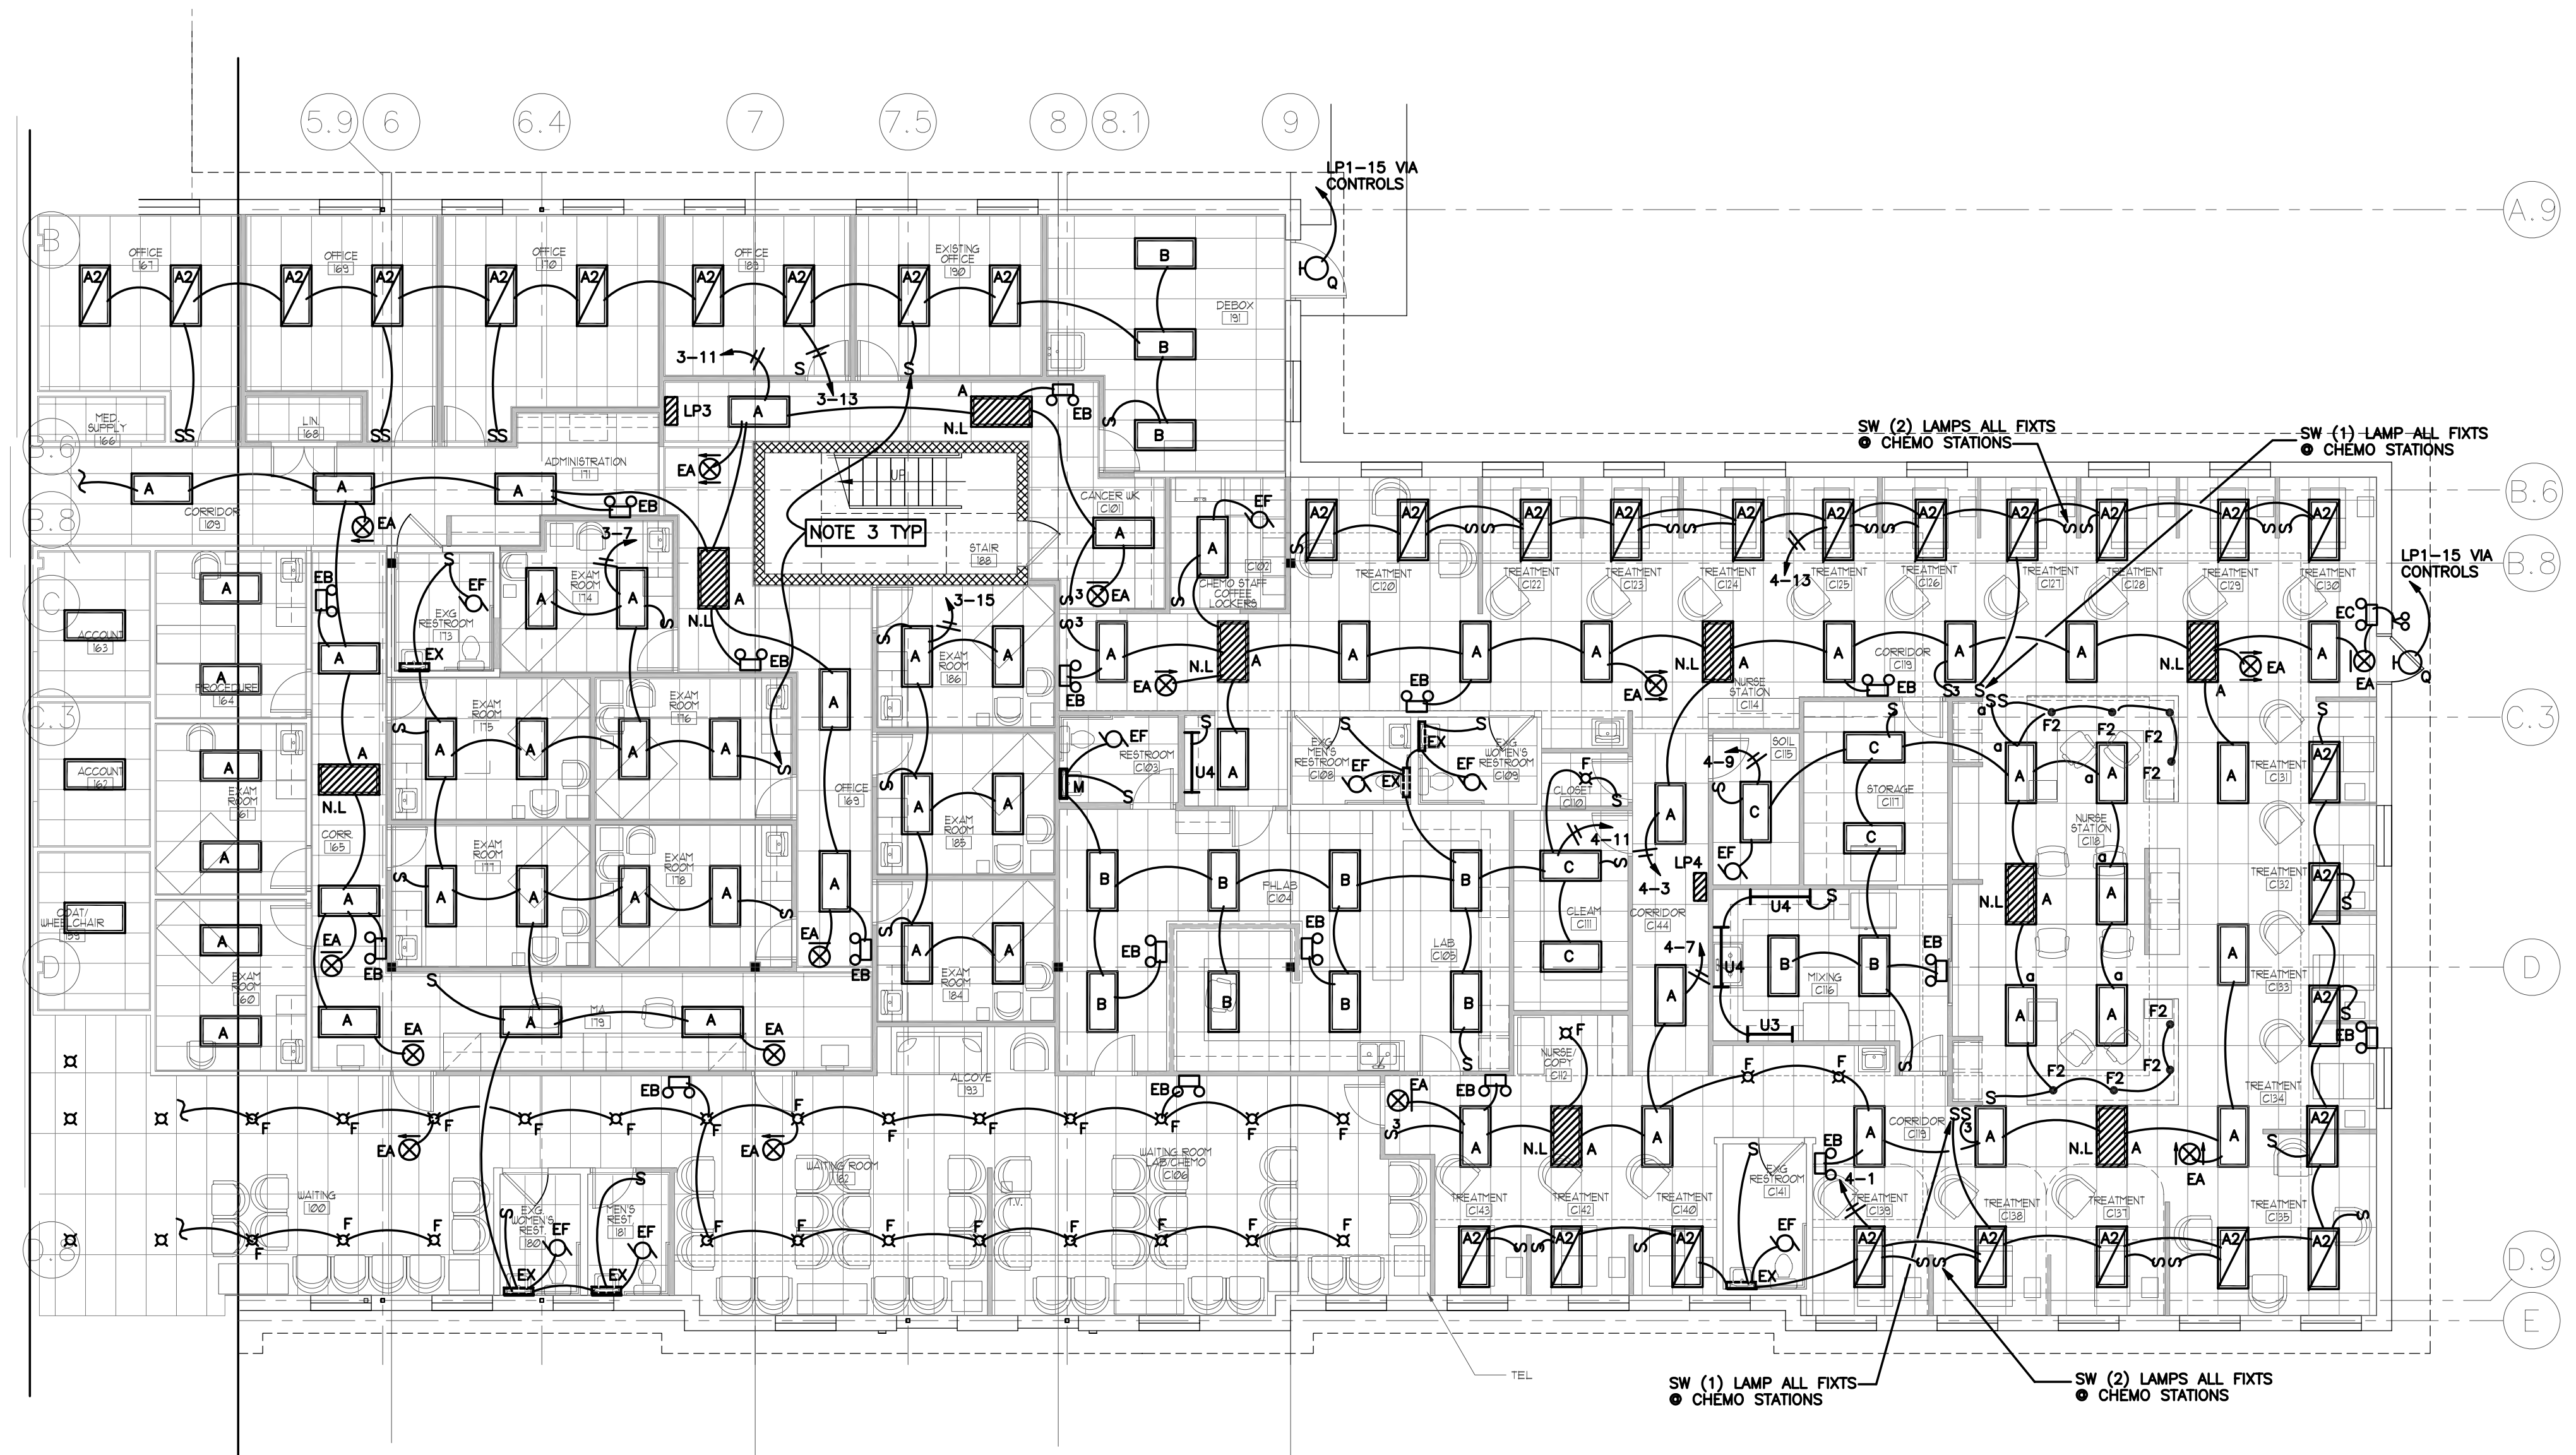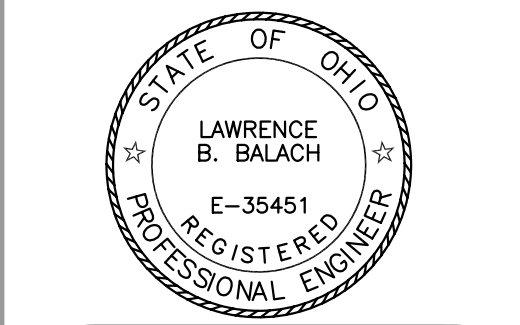
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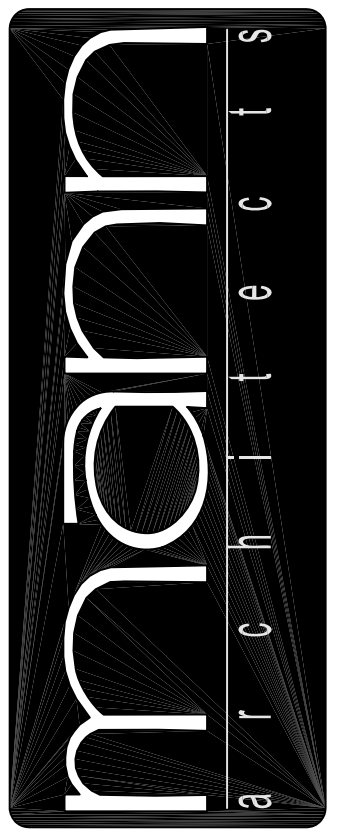
**LIGHTING PLAN - EAST**  
SCALE: 1/8" = 1'-0"

- NOTES**
- NIGHT LTS, EXITS & EMERG LTS SHALL BE CONNECTED AHEAD OF SWITCHES
  - CONNECT U.C. LTG TO RECEPT CKT.
  - ALL EXAM ROOMS, OFFICES, TOILETS, WORK ROOMS SHALL HAVE A WALL SWITCH OCCUPANCY SENSOR W/ OVER RIDE PROVIDE POWER PACKS AS REQ'D. SIMILAR TO WATT STOPPER WS-200



revisions


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drawing  
**LIGHTING PLAN - EAST**

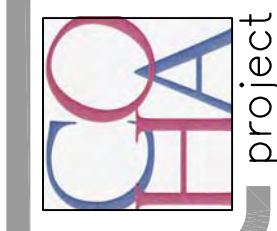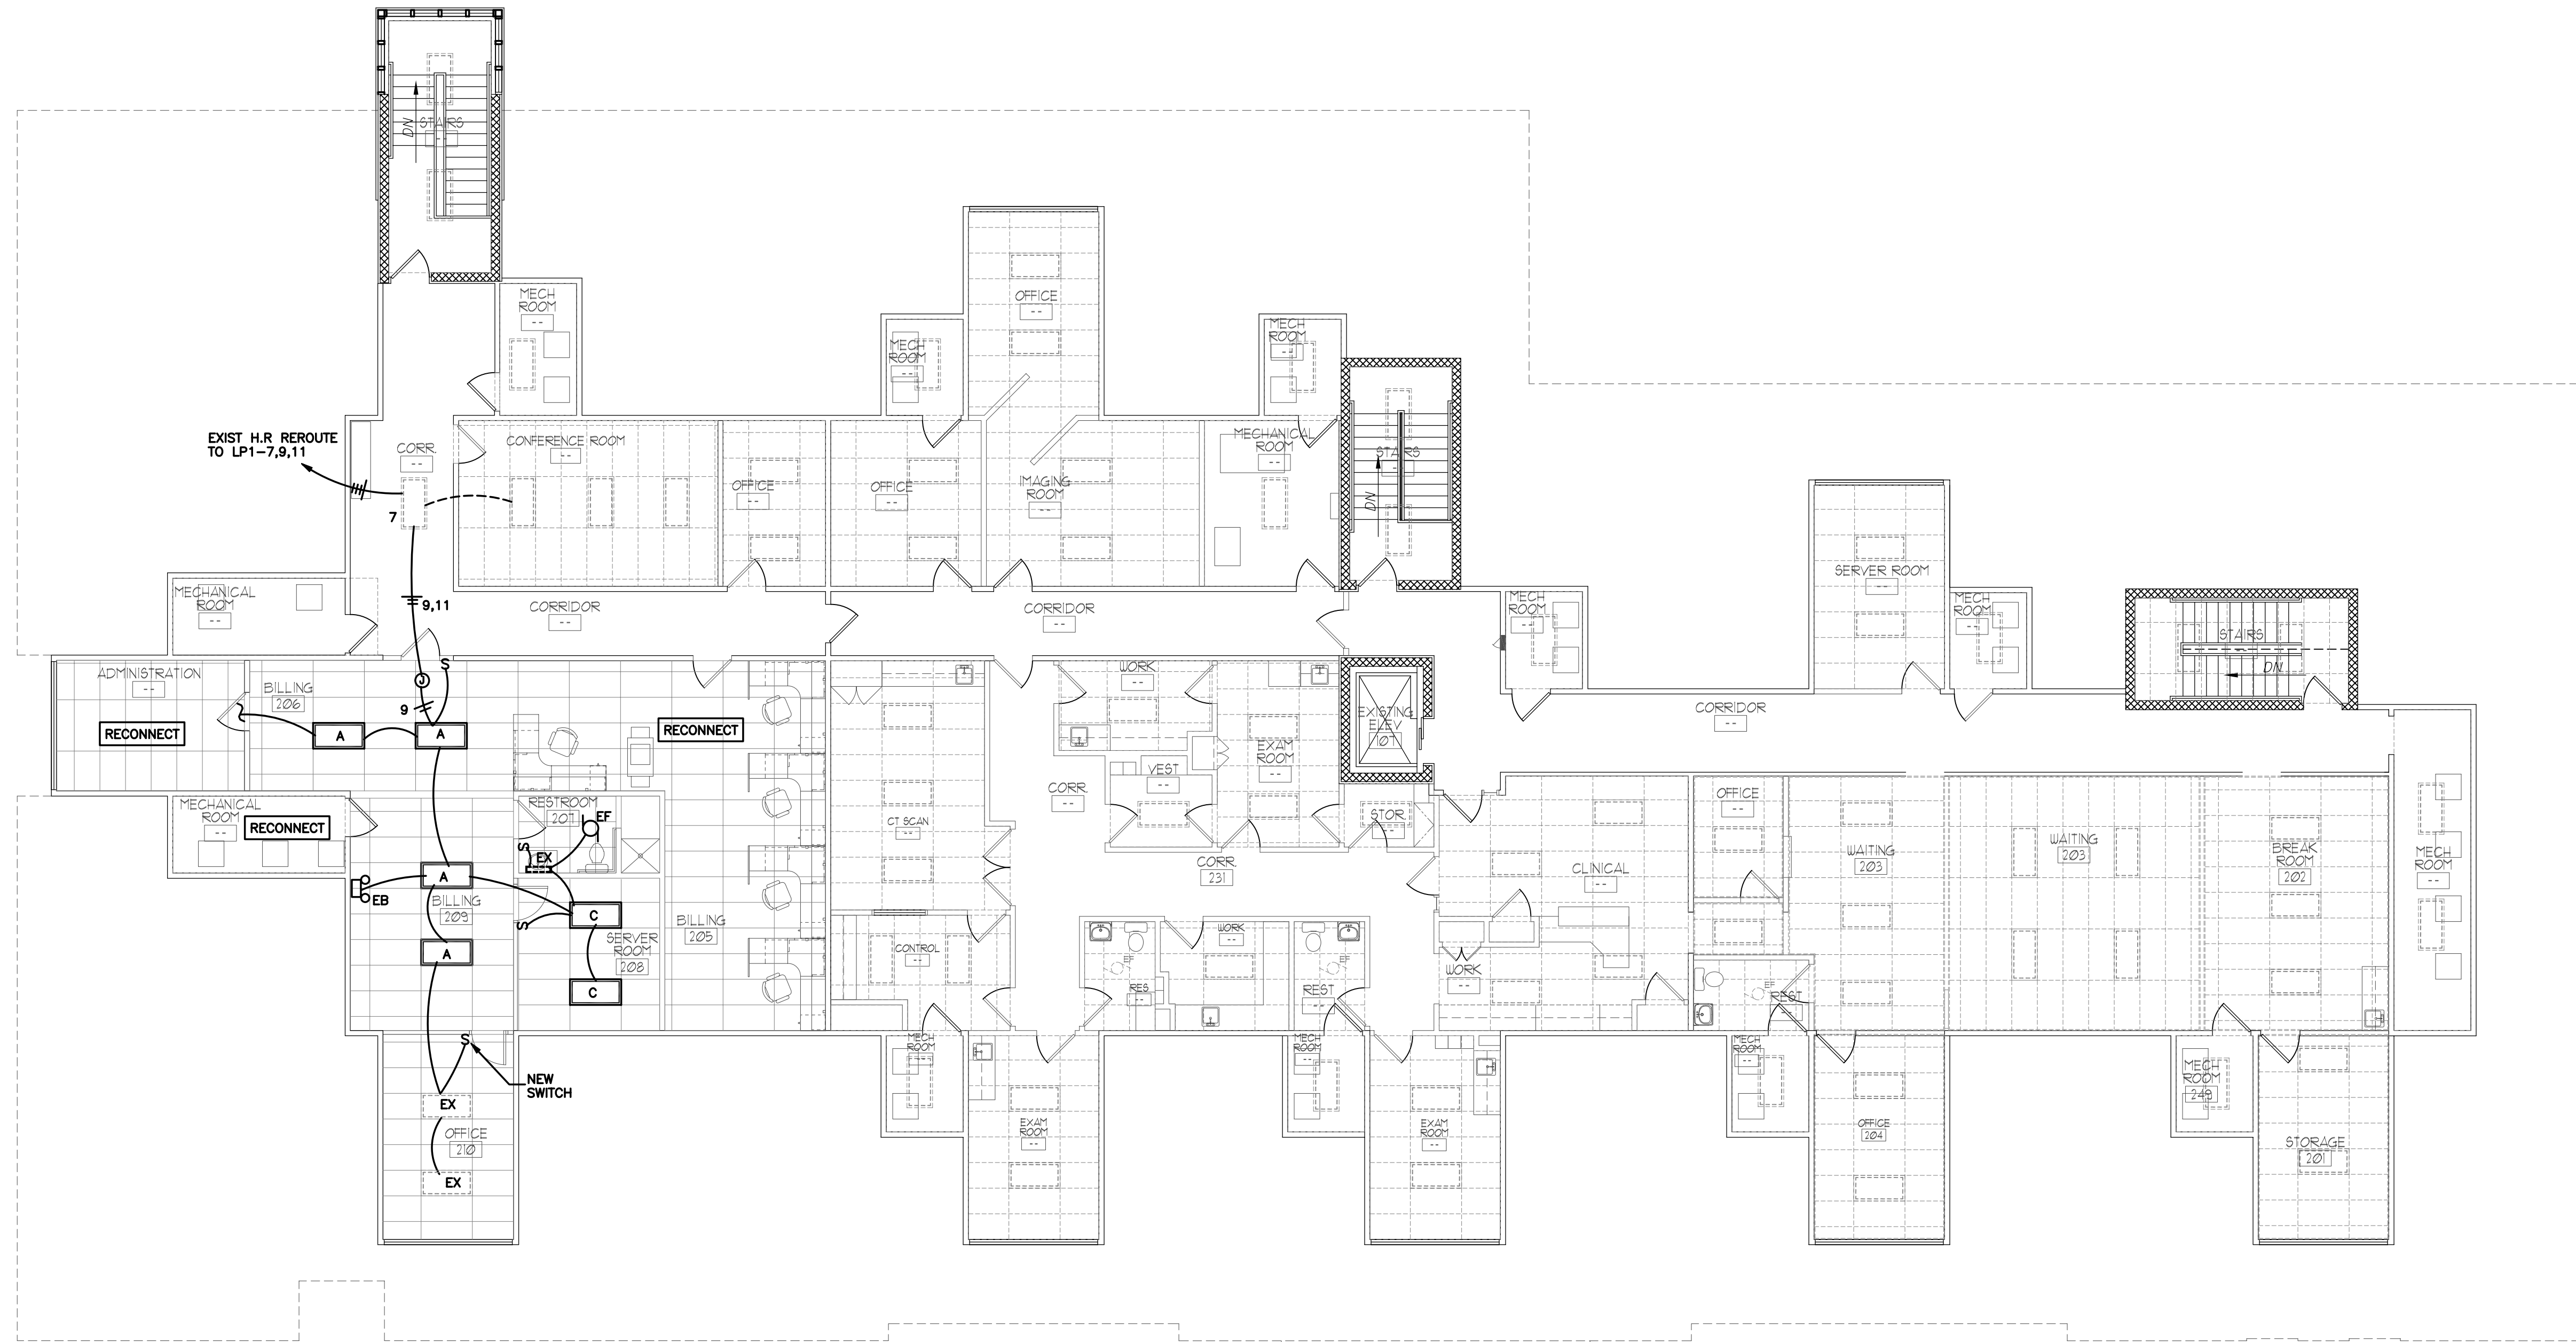
project no. 11406  
date OCTOBER 23, 2007  
scale AS NOTED

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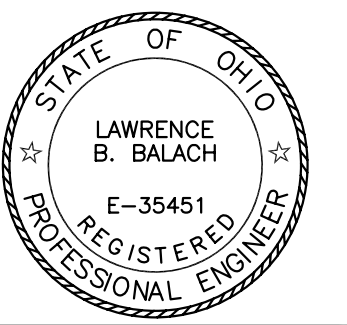
**E2.2**  
sheet no.

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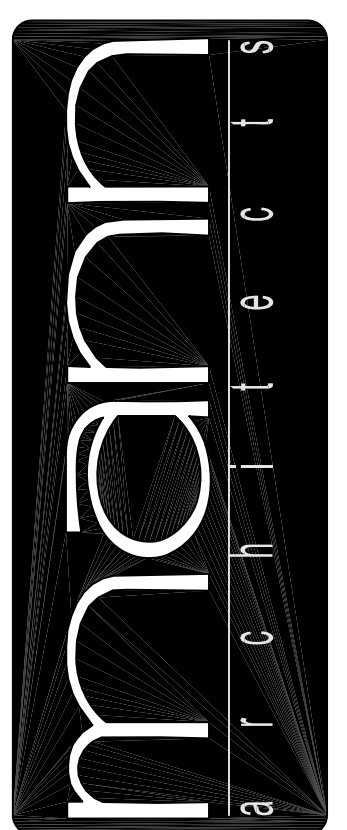
**SECOND FLOOR LIGHTING PLAN**  
SCALE: 1/8"=1'-0"

NOTE: 2nd FL. IS PHASE 1.  
TEMP CKTS MAY BE REQ'D.



revisions

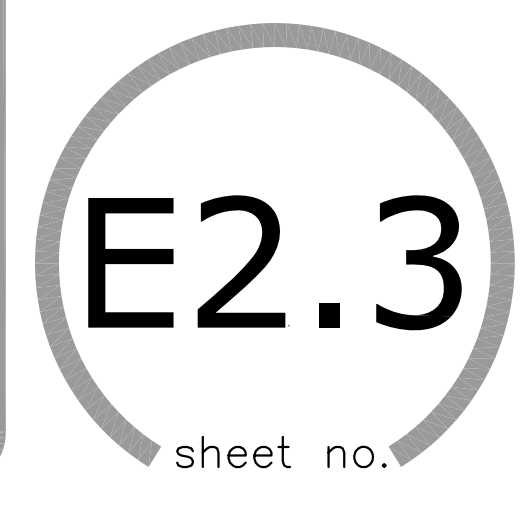
3660 embassy parkway  
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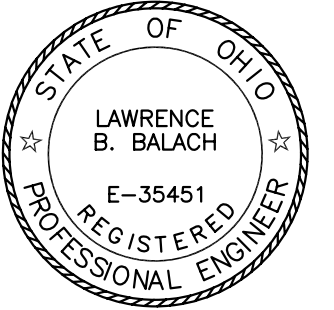
drawing  
SECOND FLOOR LIGHTING PLAN

project no. 11406  
date OCTOBER 23, 2007  
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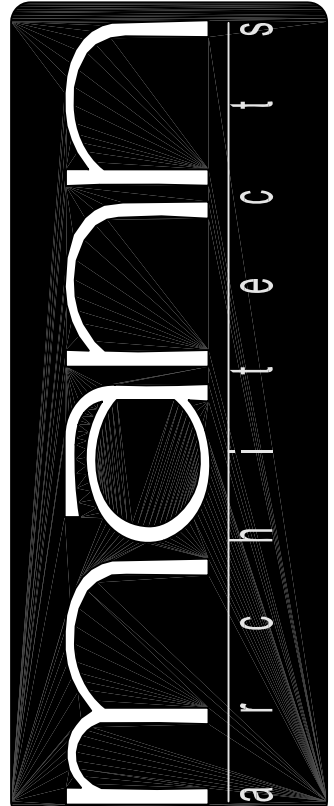


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POWER PLAN - WEST  
project no. 11406  
date OCTOBER 23, 2007  
scale AS NOTED

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sheet no.

E3.1

PANELBOARD DESIGNATION **LP1** LOCATION \_\_\_\_\_  
VOLTAGE: 208/120 PH 3 WIRE: 4 MOUNTING: FLUSH X SURFACE \_\_\_\_\_  
AMPS: 225 M.L.C. 225 M.C.B. AMPS FED FROM: TOP X BOTTOM \_\_\_\_\_  
AMPERE INT. CAP. SPECIAL


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3	LTG	1.2							1.2		REC	4
5	LTG	1.0							1.2		REC	6
7	LTG - 2nd FL.	1.2							1.2		REC	8
9	LTG - 2nd FL.	1.2							1.2		REC	10
11	LTG - 2nd FL.	1.2							1.2		REC	12
13	LTG - 2nd FL.	1.2							1.2		REC	14
15	EXT LTG								1.2		REC	16
17	EXT LTG								1.2		REC	18
19	DOOR								1.2		REC	20
21	DOOR								1.2		REC	22
23	SPARE								1.2		REC	24
25	SPARE								1.2		REC	26
27	2nd FL. - EXIST	1.2							1.2		2nd FL. - SERVER	28
29	2nd FL. - EXIST	1.2							1.2		2nd FL. - SERVER	30
31	2nd FL. - EXIST	1.2							1.2		2nd FL. - SERVER	32
33	2nd FL. - EXIST	1.2							1.2		2nd FL. - SERVER	34
35	2nd FL. - EXIST	1.2							1.2		2nd FL. - SERVER	36
37	2nd FL. - EXIST	1.2							1.2		2nd FL. - SERVER	38
39	SPARE								1.2		2nd FL. - AC-1	40
41	SPARE								1.2		2nd FL. - AC-2	42
KVA SUB TOTALS											14	22

CONN'D LOAD KVA 36 DEMAND LOAD KVA 28 DEMAND AMPERES 80  
NOTE: ALL BREAKERS 20A, UNLESS OTHERWISE NOTED. ALL BRKS FEEDING MECH UNITS SHALL BE HACR TYPE



PANELBOARD DESIGNATION **LP2** LOCATION \_\_\_\_\_  
VOLTAGE: 208/120 PH 3 WIRE: 4 MOUNTING: FLUSH X SURFACE \_\_\_\_\_  
AMPS: 225 M.L.C. 225 M.C.B. AMPS FED FROM: TOP X BOTTOM \_\_\_\_\_  
AMPERE INT. CAP. SPECIAL

QTY	DESCRIPTION	LTG.	REC.	MISC.	A	B	C	MISC.	REC.	LTG.	DESCRIPTION	QTY	
1	LTG	1.2							1.2		REC	2	
3	LTG	1.2							1.2		REC	4	
5	LTG	1.2							1.2		REC	6	
7	LTG	1.3							1.2		REC	8	
9	LTG	1.2							1.2		REC	10	
11	LTG	1.5							1.2		REC	12	
13	LTG	.9							1.2		REC	14	
15	SPARE								1.2		REC	16	
17	SPARE								1.2		REC	18	
19	REC								1.2		REC	20	
21	LOUNGE								1.2		REC	22	
23	STORAGE								1.2		REC	24	
25	REC	1.2							1.2		LOUNGE	26	
27	REC	1.2							1.2		LOUNGE	28	
29	CU-1	1.2							1.2		LOUNGE	30	
31	SPARE								1.2		LOUNGE	32	
33	SPARE								1.2		LOUNGE	34	
35	SPARE								1.2		LOUNGE	36	
37	SPARE								1.2		LOUNGE	38	
39	SPARE								1.2		SPARE	40	
41	SPARE								1.2		SPARE	42	
KVA SUB TOTALS											9	3	21

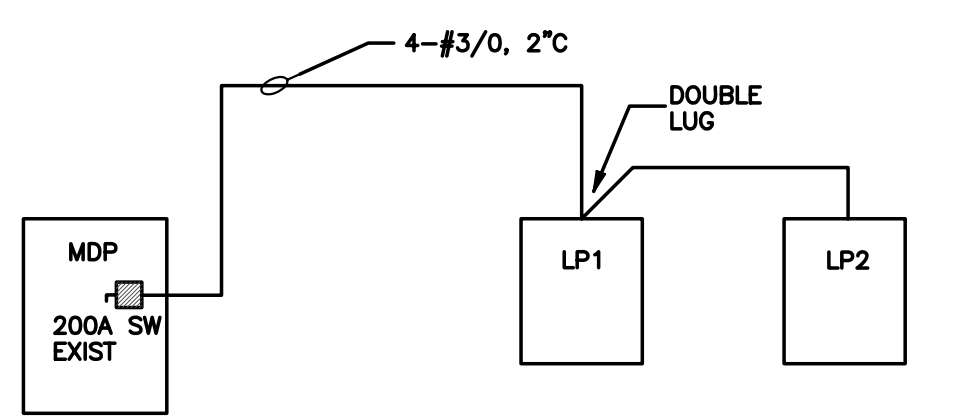CONN'D LOAD KVA 33 DEMAND LOAD KVA 28 DEMAND AMPERES 80  
NOTE: ALL BREAKERS 20A, UNLESS OTHERWISE NOTED. ALL BRKS FEEDING MECH UNITS SHALL BE HACR TYPE



PARTIAL ONE LINE DIAGRAM  
N.T.S.

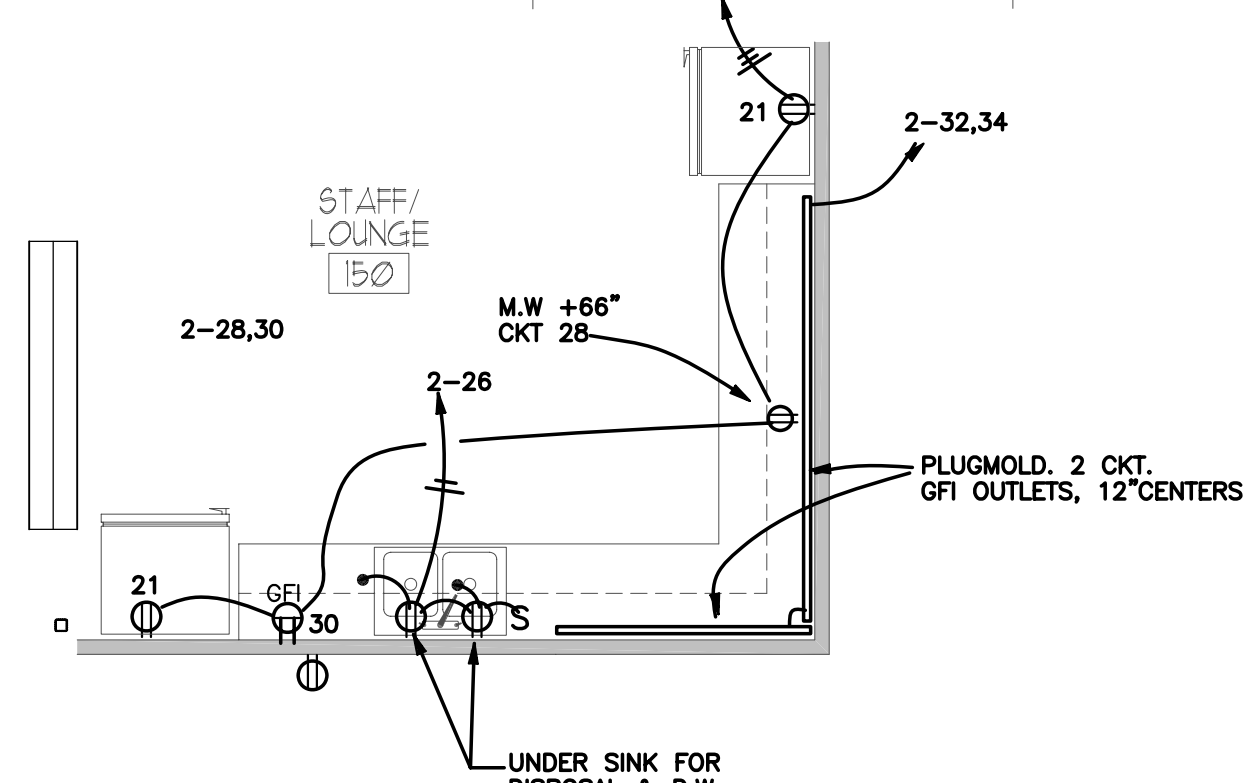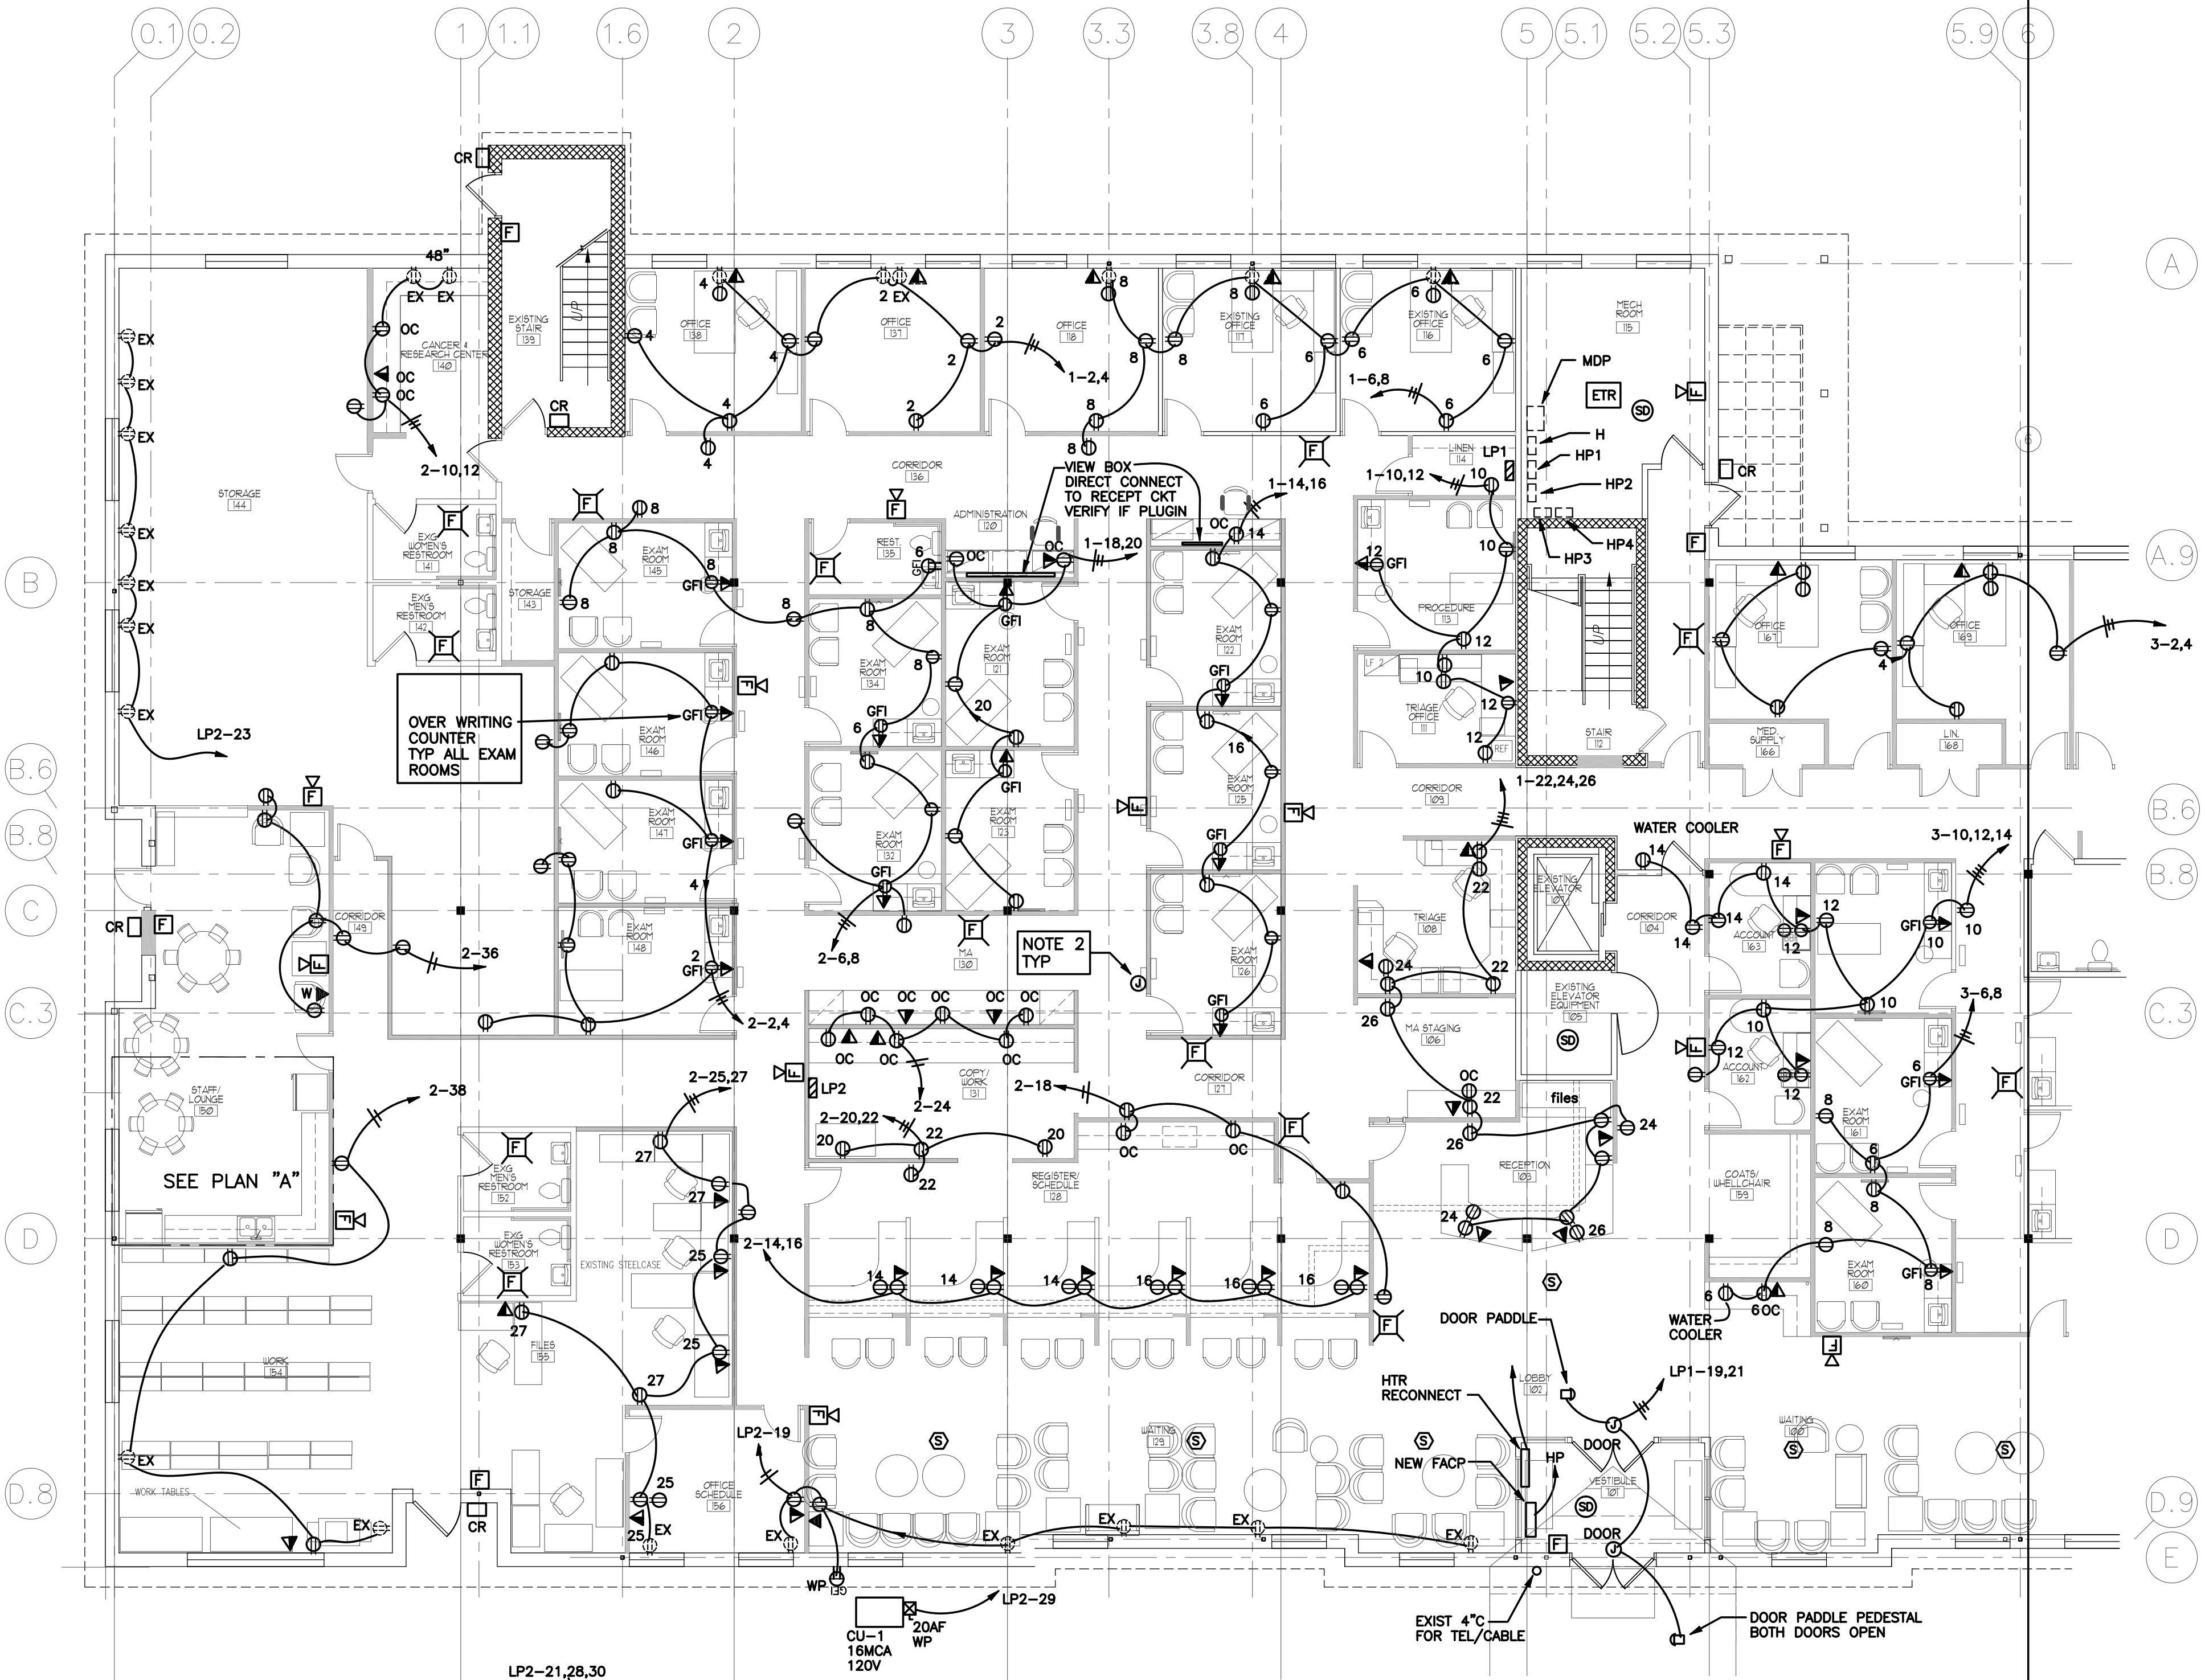


PARTIAL PLAN "A"  
SCALE: 1/4" = 1'-0"

POWER PLAN - WEST  
SCALE: 1/8" = 1'-0"

- GENERAL NOTES:
- PROVIDE NEW GAMEWELL ADDRESSABLE F.A SYSTEM ALL EXIST DEVICES TO BE REPLACED OR REMOVED.
  - ALL DWGS: PROJECT WILL BE BUILT IN PHASES. 2ND WORK FIRST. COORDINATE WORK, TEMP CKTS, ETC WITH GC AND ARCH PHASING DWGS.
  - PROVIDE SAFETY TYPE RECEPITS IN ALL EXAM ROOMS AND WAITING AREAS.


- NOTES:
- MOUNT ALL OUTLETS AT DESKS IN OPEN KNEE SPACES. SEE ARCH ELEVATIONS.
  - PROVIDE JBOX AND 1/2" CP UP TO CLG SPACE FOR PATIENT RM INDICATION (OR PAGING). VERIFY MTG HT W/GC (EITHER 48" OR 54"). SYSTEMS INSTALLED BY OTHERS. PROVIDE FOR EACH EXAM ROOM. TYP.
  - PROVIDE MUSIC SPEAKERS IN WAITING AREA. CONNECT ALL TOGETHER AND RUN UP TO SERVER ROOM. OWNER WILL PURCHASE FUT AMPLIFIER.

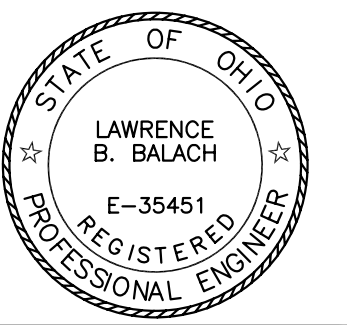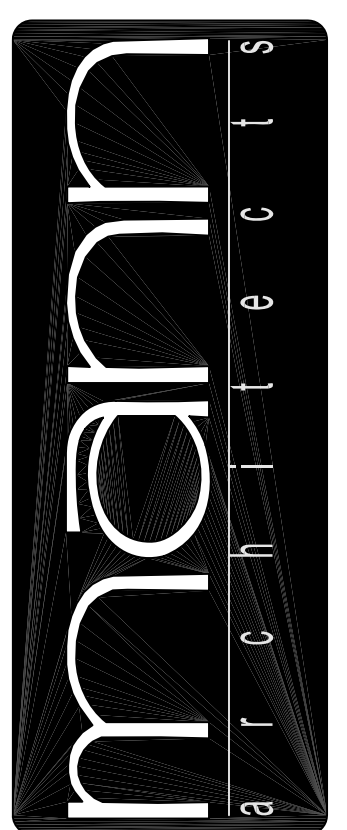MATCH LINE SEE E3.2



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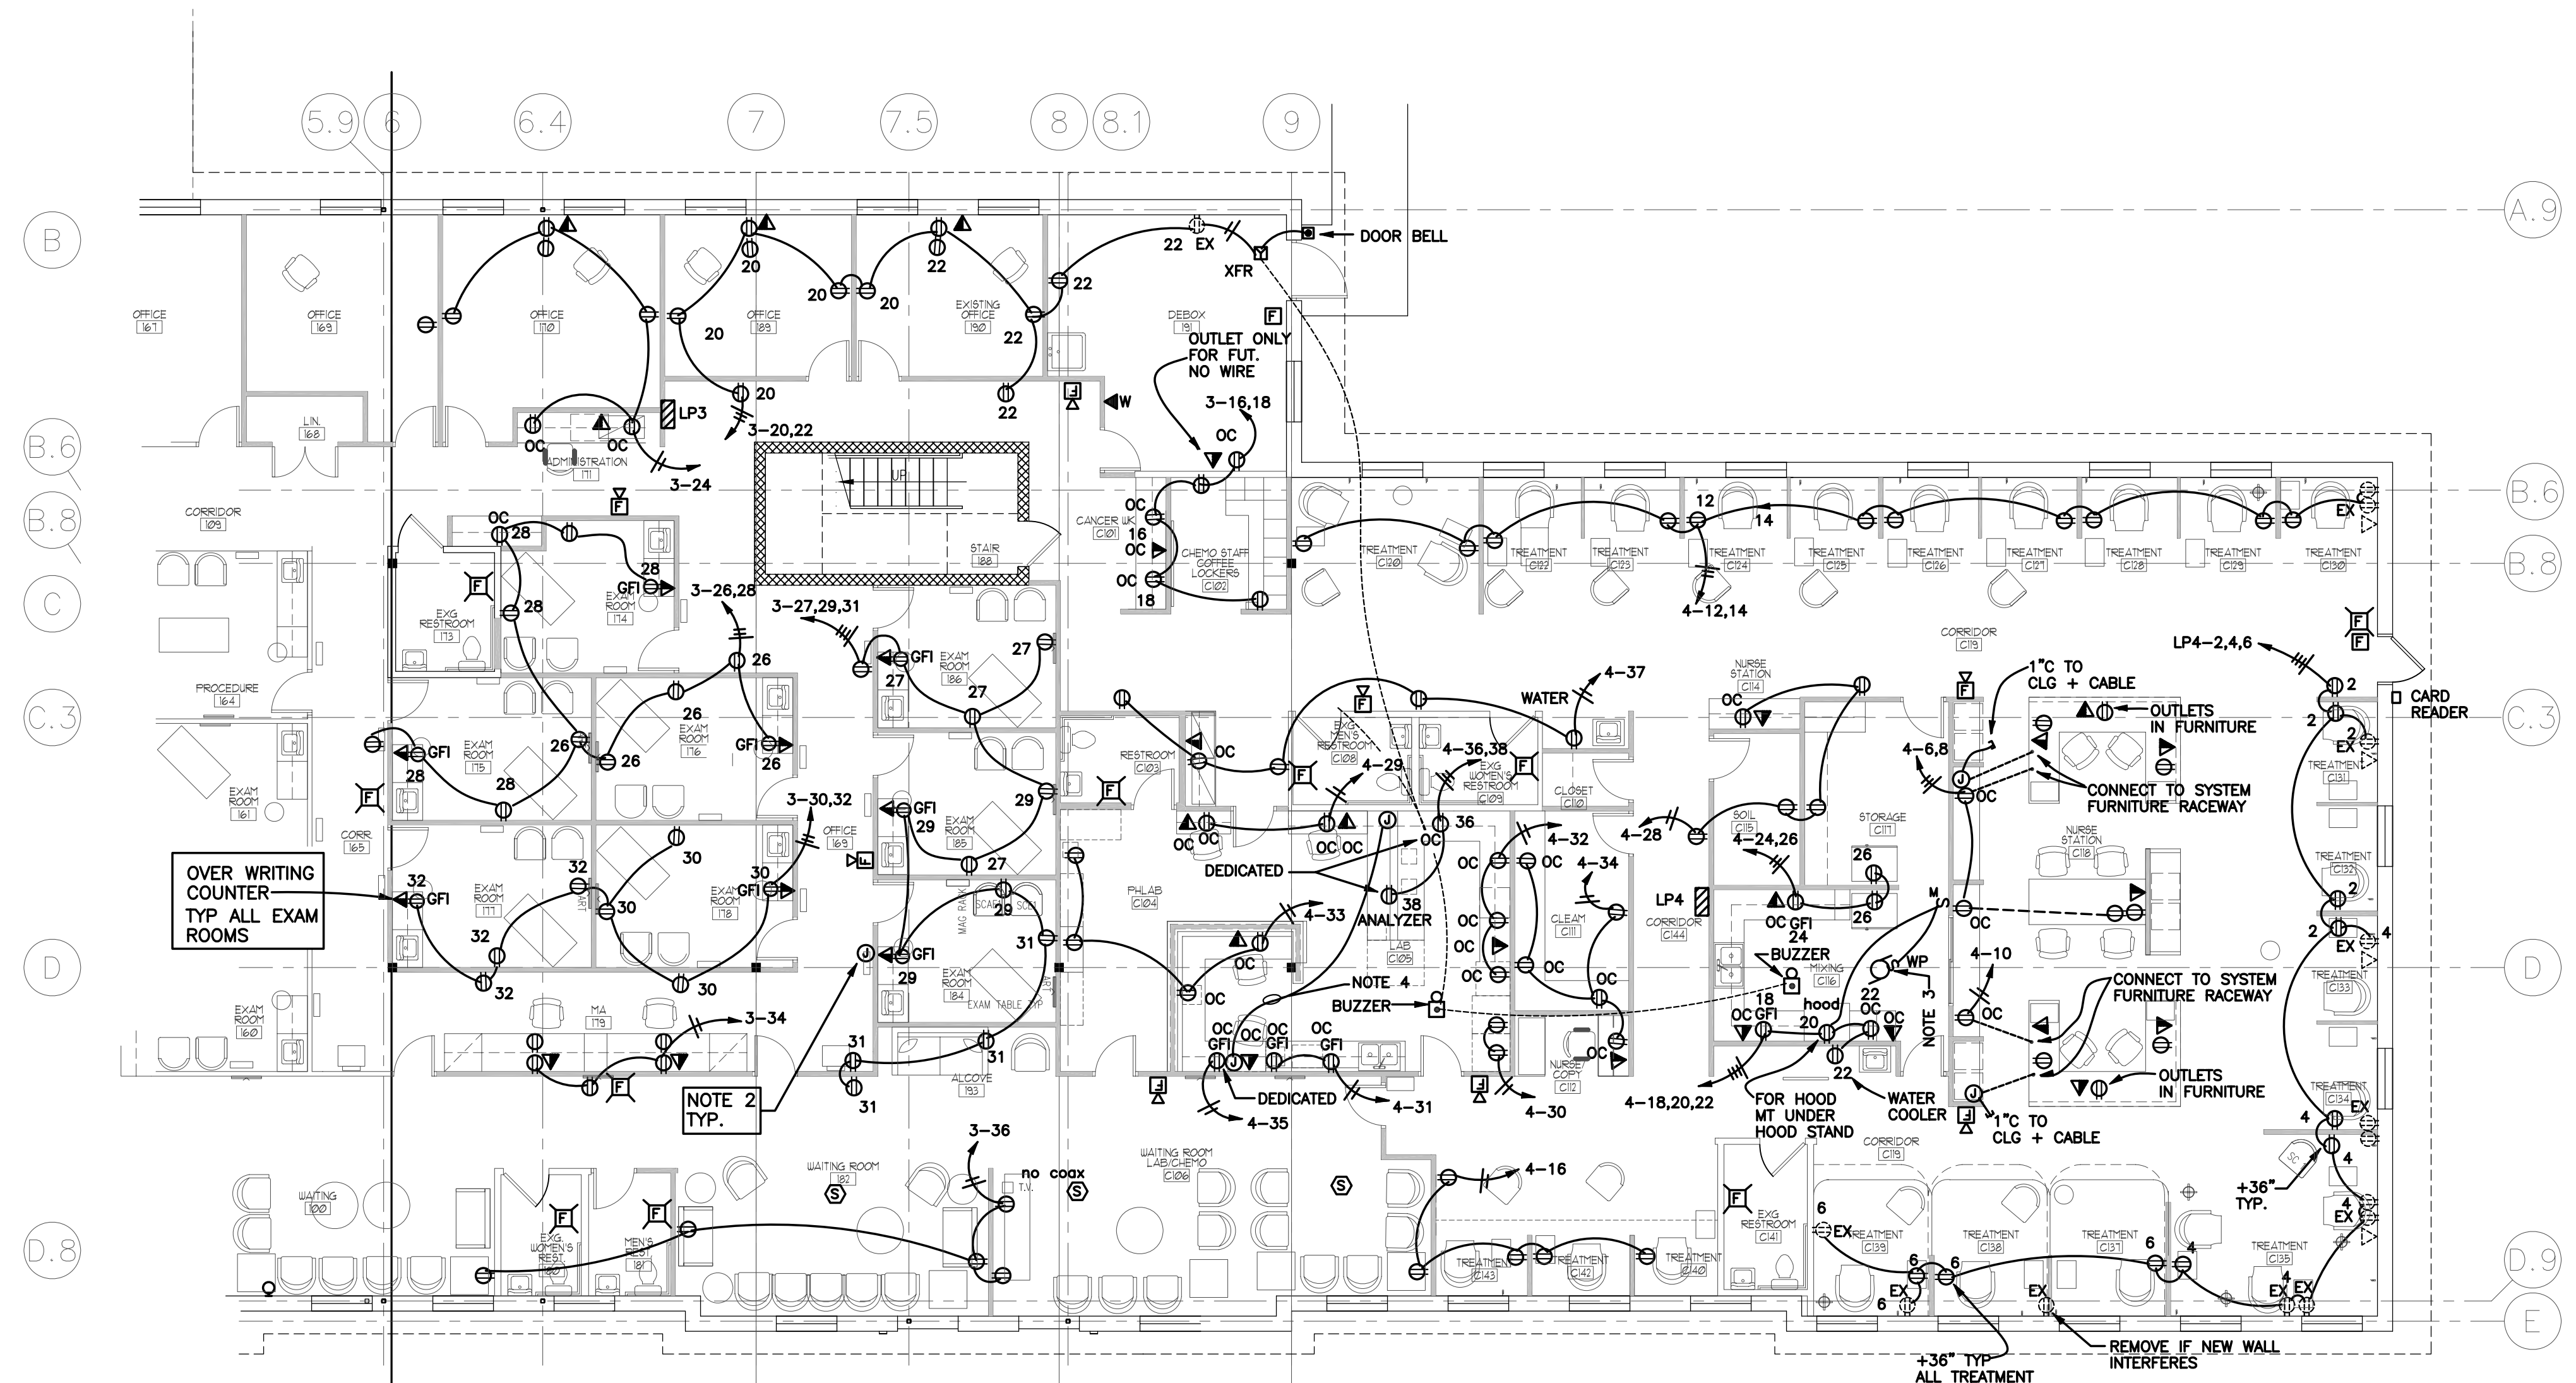


drawing  
POWER PLAN - EAST  
project no. 11406  
date OCTOBER 23, 2007  
scale AS NOTED

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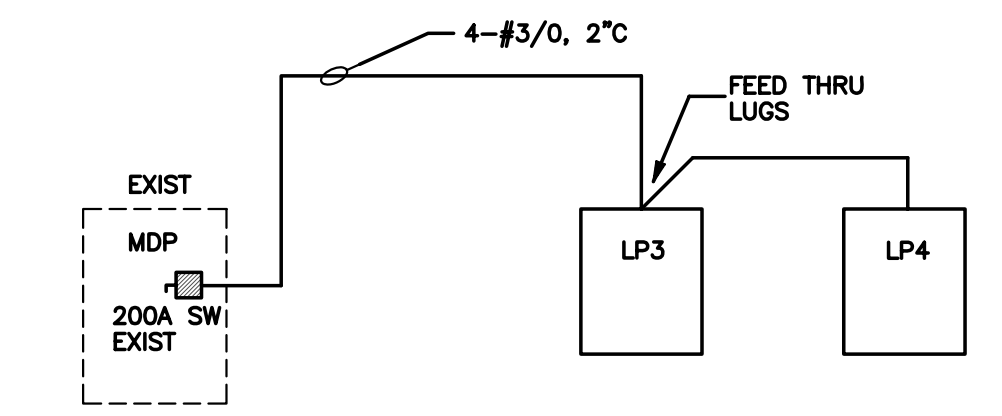
sheet no. **E3.2**

- ### SYMBOL LEGEND
- INDICATES ISOLATED GROUNDING CONDUCTOR #12 A.W.G. MIN. - U.O.N.
  - HOMERUN TO PANEL A NO. OF SLASHES = QUANTITY OF #12 A.W.G. - U.O.N.  
#3 AND #5 = CIRCUIT BREAKER NUMBER IN PANEL A
  - ARROW ON WIRING BETWEEN OUTLETS INDICATES START OF NEW CIRCUIT.  
TWO ARROWS WOULD BE TWO CIRCUITS
  - SWITCH SINGLE POLE
  - SWITCH THREE-WAY
  - MANUAL MOTOR STARTER WITH PILOT LIGHT
  - INCANDESCENT DIMMER A=600W, B=1,000W, C=1,500W, D=2,000W - MOUNTING AT 48" A.F.F.
  - DUPLEX RECEPTACLE MOUNTING AT 18" A.F.F. - VERIFY WITH ARCHITECT BEFORE ROUGH-IN
  - DOUBLE DUPLEX RECEPTACLE
  - DUPLEX RECEPTACLE - GROUND FAULT INTERRUPTER TYPE  
MT @ 42" AFF OR 6" ABOVE SINK
  - INDICATES THIS RECEPTACLE TO BE MOUNTED AT 36" A.F.F.
  - DUPLEX RECEPTACLE ON EMERG CIRCUIT
  - DUPLEX RECEPTACLE - ISOLATED GROUND TYPE
  - INDICATES THIS RECEPTACLE TO BE WIRED TO PANEL 'A' - CIRCUIT NO. 7  
W/ 2#12, 1/2" C
  - DUPLEX RECEPTACLE MOUNTING AT 6" ABOVE COUNTER
  - QUADRAPLEX - TWO DUPLEX RECEPTACLES
  - FLUORESCENT LIGHT FIXTURE TYPE 'A'
  - LIGHT FIXTURE - CEILING MOUNTED TYPE 'B'
  - LIGHT FIXTURE - WALL MOUNTED TYPE 'C'
  - LIGHT FIXTURE DOUBLE SWITCHED
  - LIGHT FIXTURE ON EMERGENCY CIRCUIT OR NIGHT LIGHT
  - EXIT LIGHT WALL MOUNTED/CEILING MOUNTED
  - COMBO EXIT & DUALHEAD EMERG LIGHT W/ (1) REMOTE HEAD
  - EMERG BATTERY LIGHT
  - CIRCUIT BREAKER PANEL
  - UNFUSED DISCONNECT SWITCH - 30 AMPERE - 3 POLE
  - FUSED DISCONNECT SWITCH - 30 AMPERE - 3 POLE - 20 AMPERE FUSING
  - MAGNETIC MOTOR STARTER
  - COMBINATION MAGNETIC MOTOR STARTER WITH FUSED DISCONNECT SWITCH
  - TRANSFORMER
  - JUNCTION BOX - MOUNTING HEIGHT AND SIZE AS REQUIRED
  - WEATHERPROOF  
UNLESS OTHERWISE NOTED
  - E.C. ELECTRICAL CONTRACTOR  
'AC' OR 'OC' ABOVE OR OVER COUNTER  
EXIST TO REMAIN
  - WALL PHONE OUTLET - MOUNTING AT 56" A.F.F. - 3/4" C WITH PULL WIRE TO ABOVE ACCESSIBLE CEILING. CABLE TO BOARD
  - DATA OUTLET, 2 GANG BOX W/SINGLE GANG COVER. MOUNTING AT 18" AFF, U.O.N. 3/4" C TO ABOVE ACCESSIBLE CEILING W/PULL. JACK. CABLE TO BD OR HUB
  - TELEPHONE/DATA OUTLET. MOUNTING AT 18" A.F.F. - 3/4" C TO ABOVE ACCESSIBLE CLG. JACKS AND CABLE TO BOARD/HUB. SEE DWGS (2)4PR CAT5E FROM OUTLET TO SERVER RM. (2)R45 JACKS
  - FIRE ALARM PULL STATION - VERIFY MOUNTING HEIGHT
  - FIRE ALARM HORN WITH FLASHING LIGHT - MOUNTING AT 80" A.F.F. OR 6" BELOW CEILING, WHICHEVER IS LOWER.
  - FIRE ALARM FLASHING LIGHT - MOUNT AT 80" A.F.F. OR 6" BELOW CEILING, WHICHEVER IS LOWER.
  - FIRE ALARM SMOKE DETECTOR - CEILING MOUNTED - U.O.N.
  - FIRE ALARM HEAT DETECTOR - CEILING MOUNTED - U.O.N.
  - FIRE ALARM DUCT SMOKE DETECTOR
  - SPRINKLER SYSTEM FLOW AND TAMPER SWITCH. CONNECT TO FA SYSTEM.
  - SPEAKER CEILING MOUNTED - RECESSED
  - SPEAKER CEILING MOUNTED - RECESSED WITH INTEGRAL VOLUME CONTROL



**POWER PLAN - EAST**  
SCALE: 1/8"=1'-0"

NOTE: CLG IS AIR PLENUM. ALL EXPOSED CABLE TO BE FIRE RATED




**PARTIAL ONE LINE DIAGRAM**  
N.T.S.

- NOTES:**
1. MOUNT ALL OUTLETS AT DESKS IN OPEN KNEE SPACES. SEE ARCH ELEVATIONS.
  2. PROVIDE JBOX AND 1/2" C UP TO CLG SPACE FOR PATIENT RM INDICATION(DR PAGING). VERIFY MTG HT W/GC (EITHER 48" OR 54"). SYSTEM INSTALLED BY OTHERS. PROVIDE FOR EACH EXAM ROOM, TYP.
  3. CONNECT NEW EF HOOD INTO EXIST SW ON HOOD TO TURN ON EF.
  4. PROVIDE J-BOXES OVER COUNTER & 1" C BETWEEN FOR INTERCONNECTION OF EQUIP. TAG.

PANELBOARD DESIGNATION LP3												LOCATION:				
VOLTAGE 208/120 PH. 3 WIRE 4												MOUNTING: FLUSH X SURFACE				
AMPS 225 M.L.O. X M.C.B. AMPS												FED FROM: TOP X BOTTOM				
NO.	DESCRIPTION	LTG.	REC.	MISC.	A	B	C	MISC.	REC.	LTG.	DESCRIPTION	NO.	DESCRIPTION	LTG.	REC.	MISC.
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3	LTG	1.3						1.2			REC	4				
5	LTG	1.5						1.2			REC	6				
7	LTG	1.1						1.2			REC	8				
9	LTG	1.0						1.2			REC	10				
11	LTG	1.4						1.2			REC	12				
13	LTG	1.2						1.2			REC	14				
15	LTG	1.0						1.2			REC	16				
17	SPARE							1.2			REC	18				
19	SPARE							1.2			REC	20				
21	SPARE							1.2			REC	22				
23	SPARE							1.2			REC	24				
25	SPARE							1.2			REC	26				
27	REC							1.2			REC	28				
29	REC							1.2			REC	30				
31	REC							1.2			REC	32				
33	SPARE							1.2			REC	34				
35	SPARE							1.2			REC	36				
37	SPARE										SPARE	38				
39	SPARE										SPARE	40				
41	SPARE										SPARE	42				
KVA SUB TOTALS 9												DEMAND FACTOR				
CONN'D LOAD KVA 29												DEMAND LOAD KVA 20		DEMAND AMPERES 60		
NOTE: ALL BREAKERS 20A, UNLESS OTHERWISE NOTED. ALL BRKS FEEDING MECH UNITS SHALL BE HACR TYPE																

PANELBOARD DESIGNATION LP4												LOCATION:				
VOLTAGE 208/120 PH. 3 WIRE 4												MOUNTING: FLUSH X SURFACE				
AMPS 225 M.L.O. X M.C.B. AMPS												FED FROM: TOP X BOTTOM				
NO.	DESCRIPTION	LTG.	REC.	MISC.	A	B	C	MISC.	REC.	LTG.	DESCRIPTION	NO.	DESCRIPTION	LTG.	REC.	MISC.
1	LTG	1.0						1.2			REC	2				
3	LTG	1.3						1.2			REC	4				
5	LTG	1.4						1.2			REC	6				
7	LTG	1.2						1.2			REC	8				
9	LTG	1.0						1.2			REC	10				
11	LTG	1.2						1.2			REC	12				
13	LTG	1.2						1.2			REC	14				
15	SPARE							1.2			REC	16				
17	SPARE							1.2			REC	18				
19	SPARE							1.2			REC	20				
21	SPARE							1.2			REC	22				
23	SPARE							1.2			REC	24				
25	SPARE							1.2			REC	26				
27	SPARE							1.2			REC	28				
29	REC							1.2			REC	30				
31	REC							1.2			REC	32				
33	REC							1.2			REC	34				
35	REC							1.2			REC	36				
37	REC							1.2			REC	38				
39	SPARE										SPARE	40				
41	SPARE										SPARE	42				
KVA SUB TOTALS 7 6												DEMAND FACTOR				
CONN'D LOAD KVA 37												DEMAND LOAD KVA 28		DEMAND AMPERES 78		
NOTE: ALL BREAKERS 20A, UNLESS OTHERWISE NOTED. ALL BRKS FEEDING MECH UNITS SHALL BE HACR TYPE																

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- NOTES:**
1. REPLACE ALL F.A DEVICES ON ENTIRE 2nd FL. W/ NEW & CONNECT TO NEW SYSTEM
  2. APPROX 6 CKTS NOW FEED 2nd FL. ONCOLOGY AREA FROM EXIST PANEL TP1. TIE IN & REROUTE TO NEW PANEL LP1-27 THRU 37.

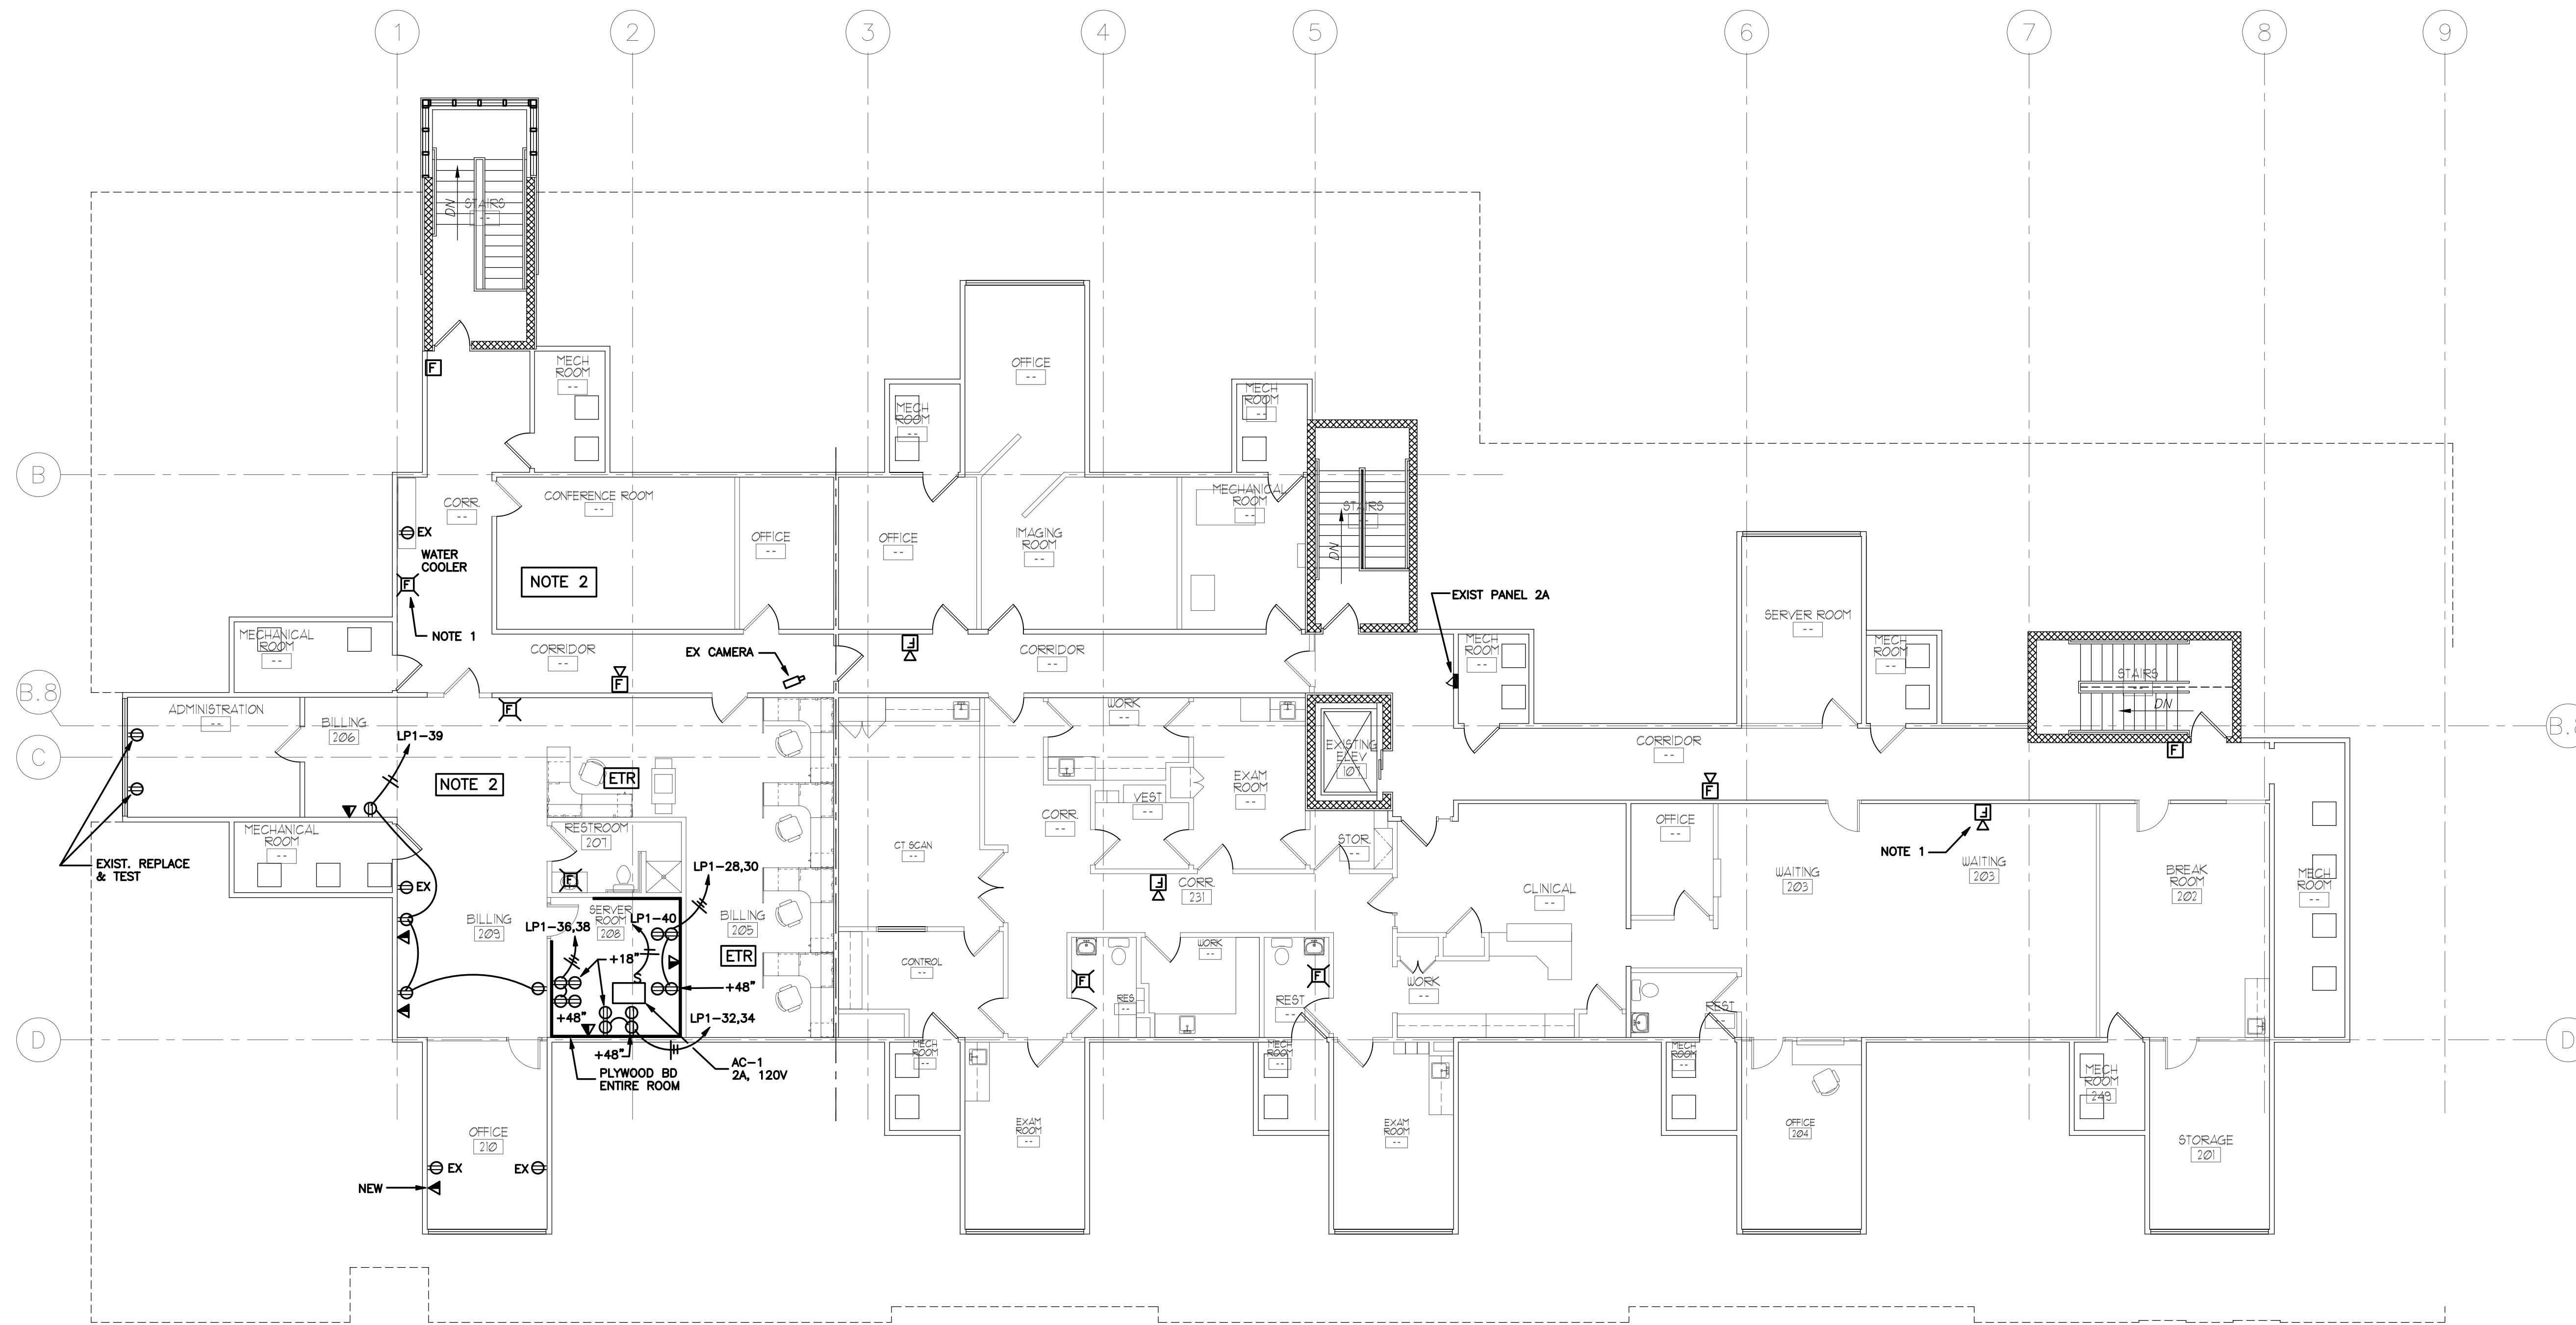
**SECOND FLOOR POWER PLAN**  
SCALE: 1/8" = 1' - 0"

NOTE: 2nd FL. IS PHASE 1. TEMP CKTS MAY BE REQ'D.



revisions


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drawing  
SECOND FLOOR POWER PLAN

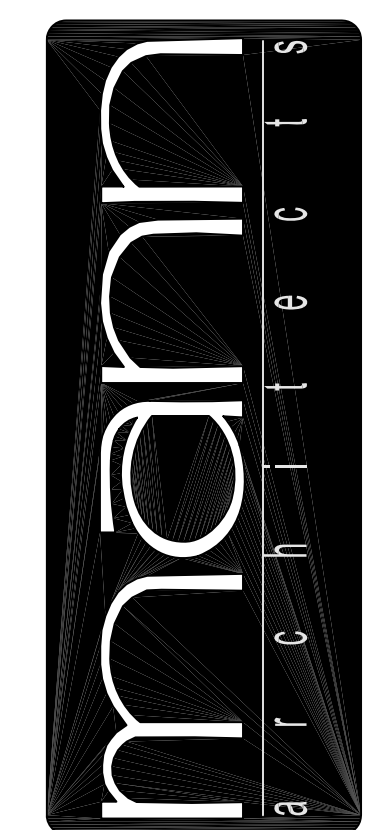project no. 11406  
date OCTOBER 23, 2007  
scale AS NOTED

**COLUMBUS ONCOLOGY**  
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sheet no.
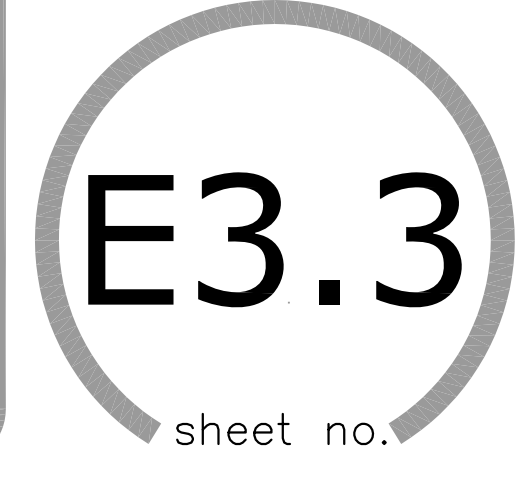
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